NYPL SCHOMBURG CENTER FOR RESEARCH IN BLACK CULTURE

515 MALCOLM X BOULEVARD NEW YORK, NY 10037

ENVELOPE RESTORATION AND ASSOCIATED ASBESTOS ABATEMENT

100% CD SUBMISSION




NEW YORK PUBLIC LIBRARY

476 FIFTH AVENUE NEW YORK, NY 10018




ARCHITECT:

CURTIS + GINSBERG ARCHITECTS ONE BATTERY PARK PLAZA, FL 27 NEW YORK, NEW YORK 10004 212.929.4417

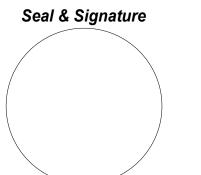

FACADE:

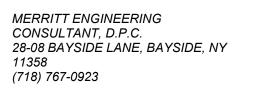


ignature


ENVIRONMENTAL:



THE LIRO GROUP 235 EAST JERICHO TURNPIKE, MINEOLA, NY 11501 516.746.2350


LIST OF DRAWINGS

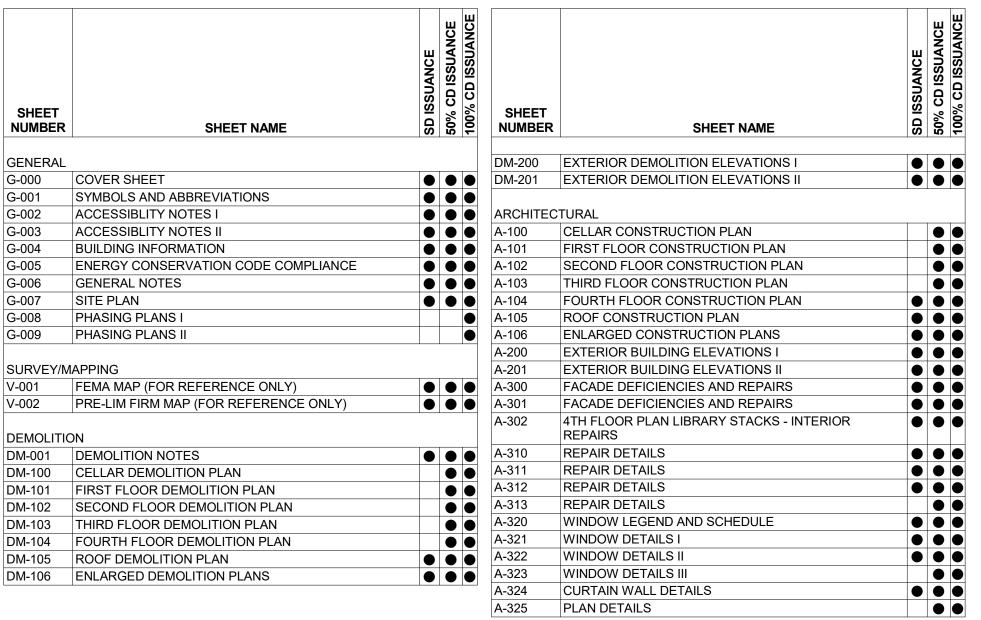

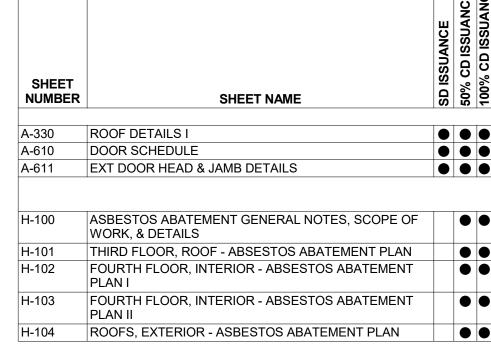

LOCATION PLAN

SITE PLAN

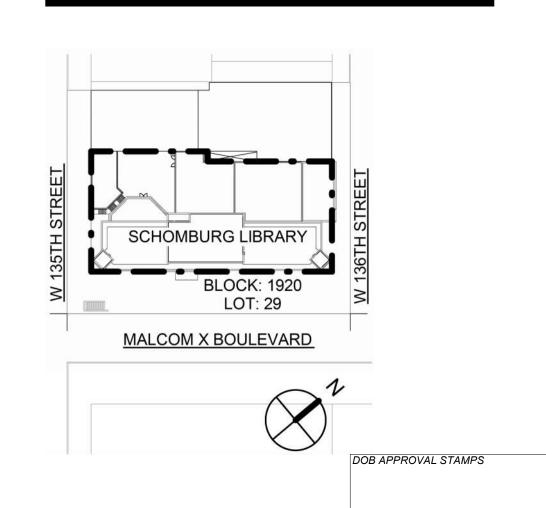


17 X N. 3706709999


39 Franklin Street, Buffalo, NY 14202-11

FOR THEIR INTENDED PURPOSE. ONCE THE INTENDED PURPOSE HAS CEASED

Drawing 1 of

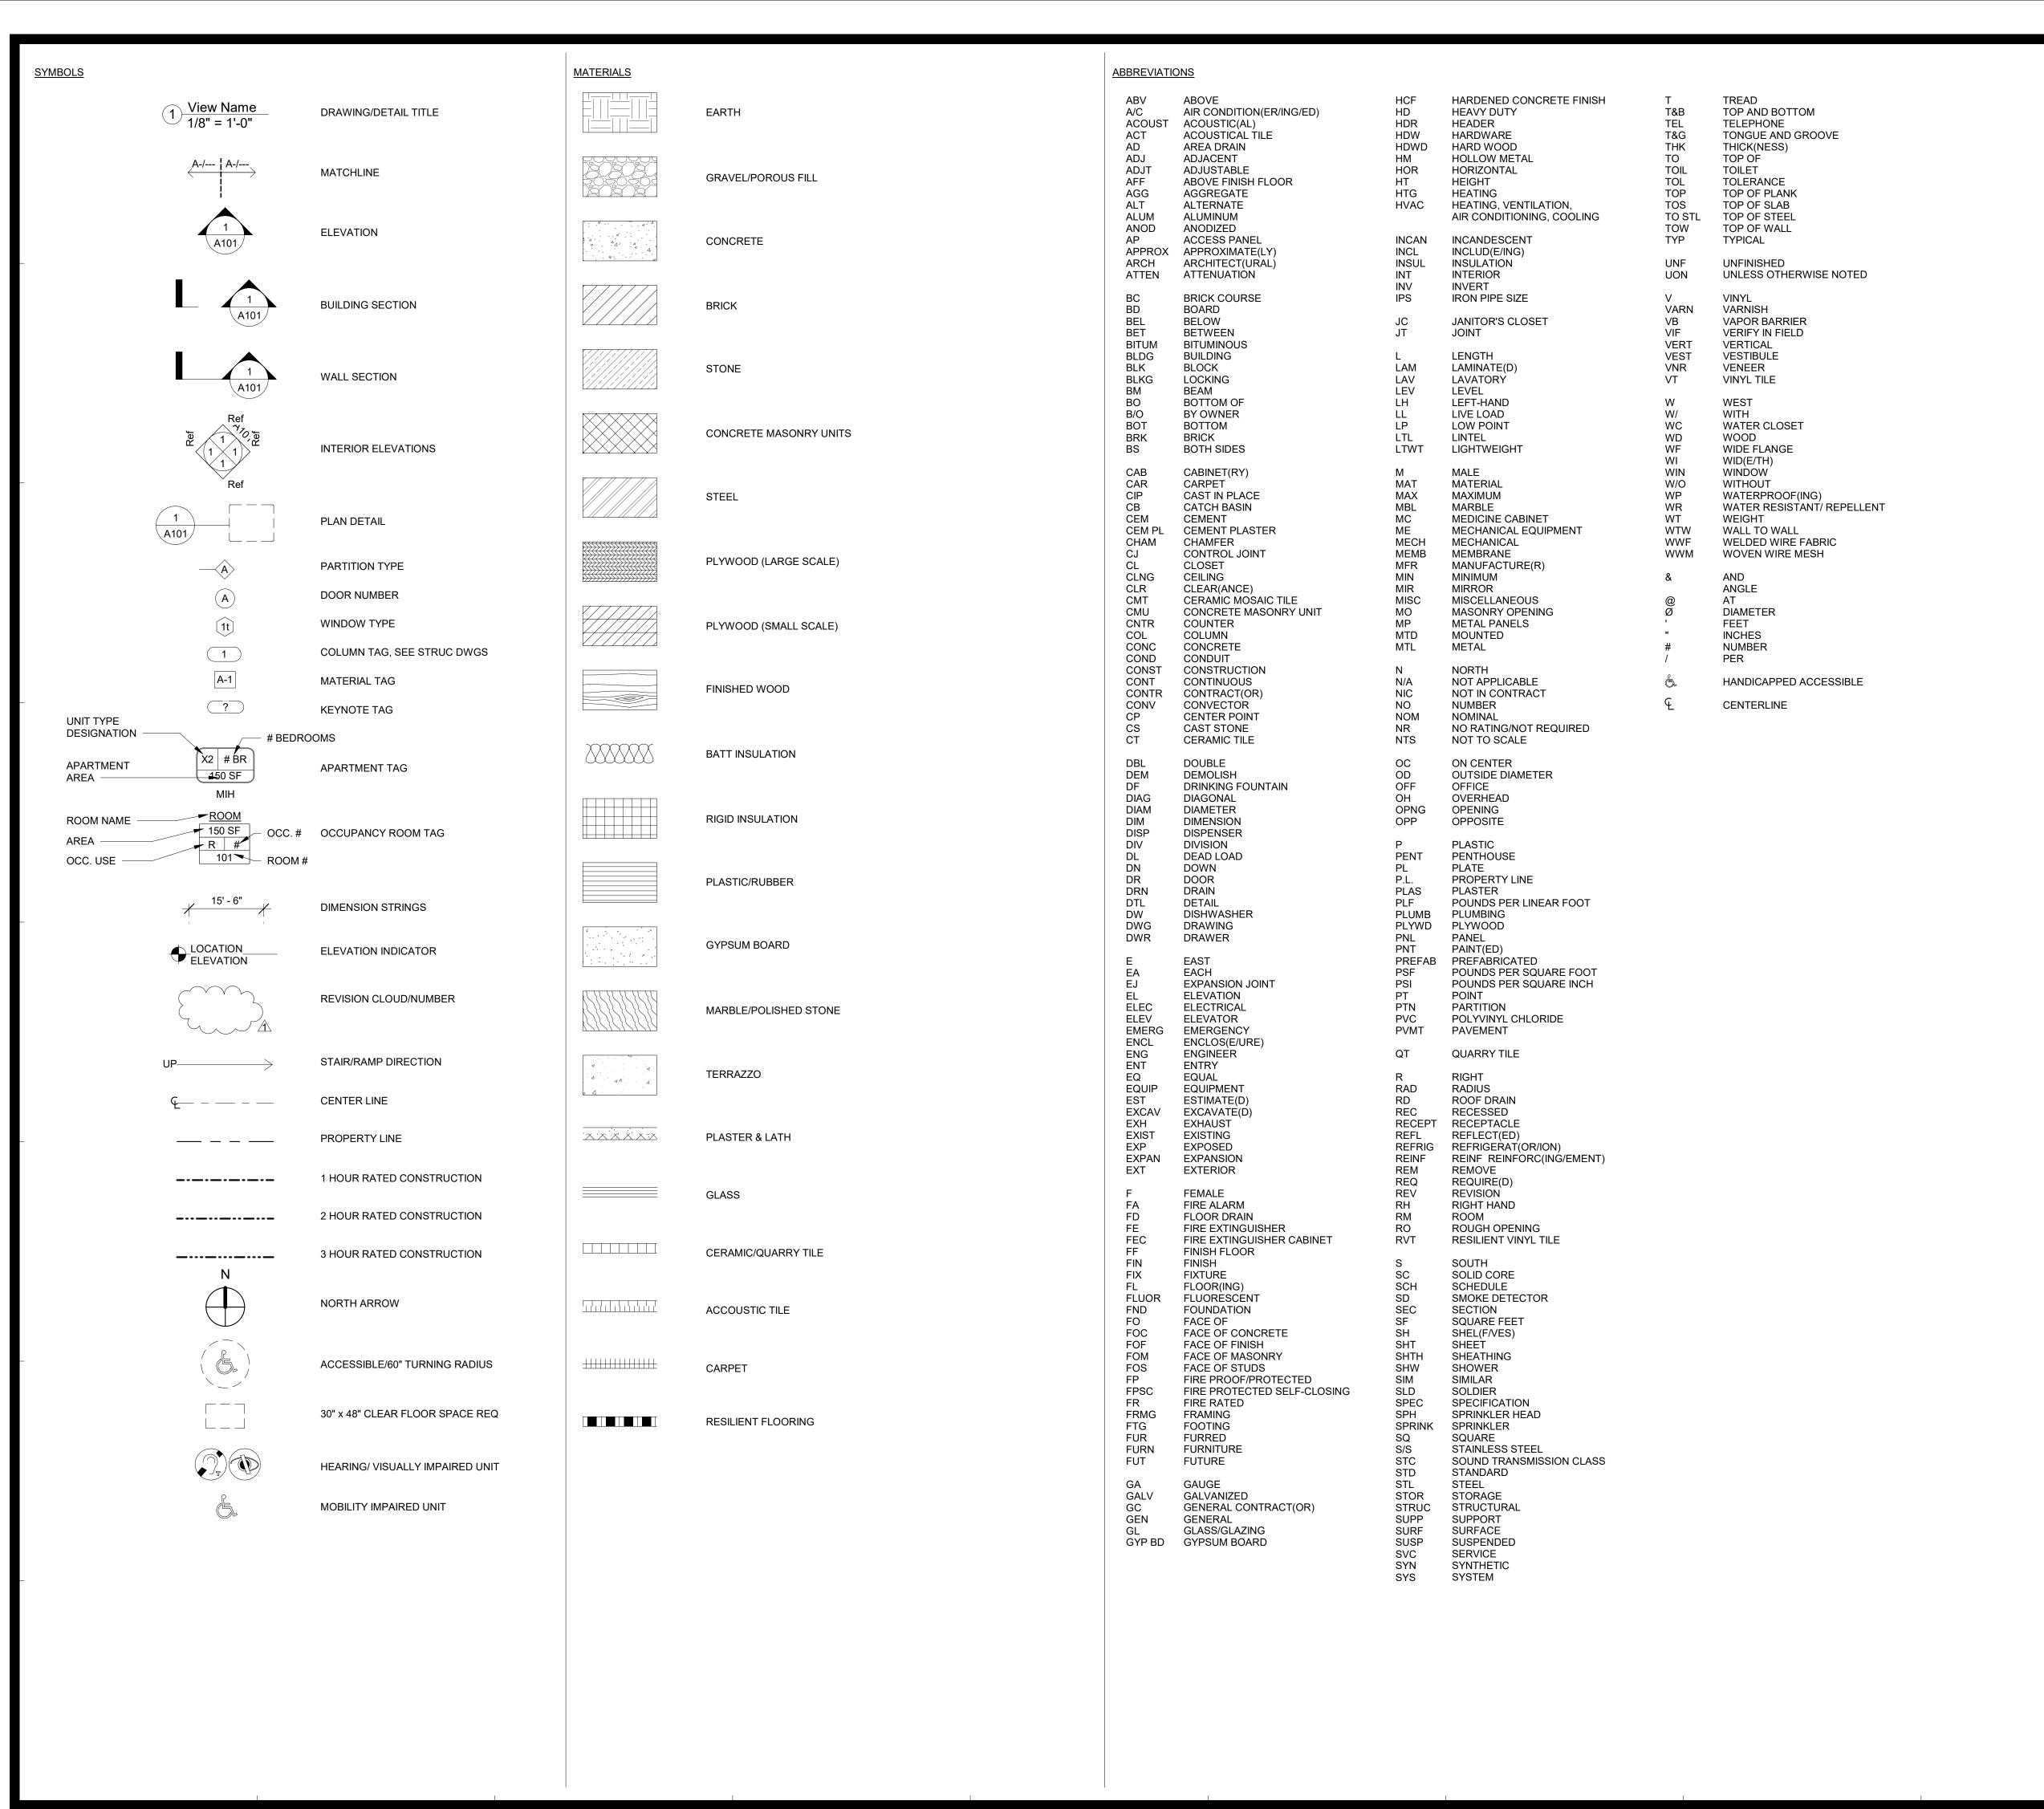

NEW YORK 515 Broadway, Albany, New York, 12207-2964 One Penn Plaza, 52 Floor, NY, NY 10119-0098 539 Franklin Street, Buffalo, NY 14202-1109 WWW.DASNY.ORG IESE DOCUMENTS CONTAIN POTENTIALLY SENSITIVE INFORMATION AND SHALL BE SED FOR THEIR INTENDED PURPOSE. ONCE THE INTENDED PURPOSE HAS CEASED, THE DOCUMENTS SHALL BE DESTROYED IN A SECURE MANNER. IT IS A VIOLATION OF STATE EDUCATION LAW FOR ANY PERSON, UNLESS UNDER THE DIRECTION OF A LICENSED ARCHITECT / ENGINEER TO ALTER THIS DOCUMENT IN ANY WAY AITERATIONS MIST HAVE THE SEAL AFFIXED ALONG WITH A DESCRIPTION OF THE ALTERATIONS, DATE AND ARCHITECT'S / ENGINEER'S SIGNATURE. COPYRIGH Consultants CURTIS + GINSBERG Curtis + ARCHITECTS
ONE BATTERY PARK PLAZA, ARCHITECTS Ginsberg FL 27 Architects NEW YORK, NEW YORK 10004 212.929.4417 Merritt Engineering 28-08 Bayside Lane, Queens, NY 11358 (718) 767-0923 The LiRo Group 235 East Jericho Turnpike, Mineola, NY 11501 516.746.2350

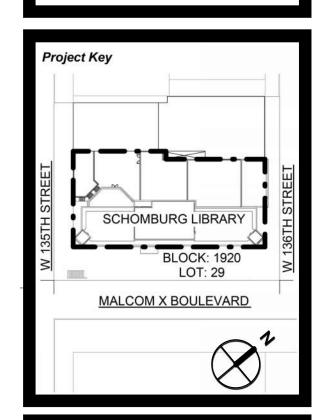

REVISIONS

Rev No Description


<u>3</u>
4
<u></u>
<u>6</u>
<u> </u>
<u>8</u>
<u> </u>
Client New York Public
Library
476 FIFTH AVENUE
NEW YORK, NY 10018

Date:

NYPL SCHOMBURG ENVELOPE RESTORATION 515 MALCOLM X BLVD NEW YORK, NY 10037

Drawing Title SYMBOLS AND **ABBREVIATIONS**

90% CD SUBMISSION Drawn By: Checked By: Date: Seal & Signature:

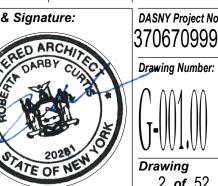


ACCESSIBILITY NOTES

- . ALL WORK SHALL COMPLY WITH THE APPLICABLE REQUIREMENTS OF CHAPTER 11 OF THE 2022 NEW YORK CITY BUILDING CODE, INCLUDING APPENDIX E. 2. PLACES OF PUBLIC ACCOMMODATION SHALL COMPLY WITH THE 2010 ADA STANDARDS FOR
- ACCESSIBLE DESIGN.
- . NOT ALL DIAGRAMS SHOWN ARE APPLICABLE TO THIS SET OF DRAWINGS 4. THE FOLLOWING DIAGRAMS ARE BASED ON ANSI A117.1-2009 WITH REVISIONS FOR


—COMPLIANCE WITH 2022 NEW YORK CITY BUILDING CODE AND/OR 2010 ADA. SECTION 302 FLOOR OR GROUND SURFACES

 FLOOR AND GROUND SURFACES SHALL BE STABLE, FIRM, AND SLIP RESISTANT. CARPET OR CARPET TILE SHALL BE SECURELY ATTACHED AND SHALL HAVE A FIRM CUSHION. PAD, OR BACKING OR NO CUSHION OR PAD. CARPET OR CARPET TILE SHALL HAVE A LEVEL LOOP, TEXTURED LOOP, LEVEL CUT PILE, OR LEVEL CUT/UNCUT PILE TEXTURE. PILE HEIGHT SHALL BE 1/2 INCH MAXIMUM. EXPOSED EDGES OF CARPET SHALL BE FASTENED TO FLOOR SURFACES AND SHALL HAVE TRIM ON THE ENTIRE LENGTH OF THE EXPOSED EDGE. CARPET EDGE TRIM SHALL COMPLY WITH SECTION 303.

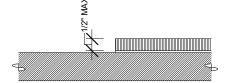


3. OPENINGS IN FLOOR OR GROUND SURFACES SHALL NOT ALLOW PASSAGE OF A SPHERE MORE THAN 1/2 INCH DIAMETER EXCEPT AS ALLOWED BY SECTIONS 407.4.3, 409.4.3, 410.4, 810.5.3, AND 810.10. ELONGATED OPENINGS SHALL BE PLACES SO THAT THE LONG DIMENSION IS PERPENDICULAR TO THE DOMINANT DIRECTION OF TRAVEL

DOMINANT DIRECTION OF TRAVEL

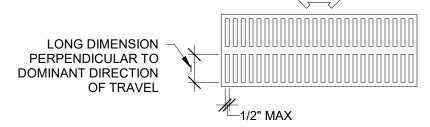

SECTION 303 CHANGES IN LEVEL

- . CHANGES IN LEVEL OF 1/4 INCH MAXIMUM IN HEIGHT SHALL BE PERMITTED TO BE VERTICAL 2. CHANGES IN LEVEL BETWEEN 1/4 INCH HIGH MINIMUM AND 1/2 INCH HIGH MAXIMUM SHALL BE
- BEVELED WITH A SLOPE NOT STEEPER THAN 1:2. : 4 INCH MAXIMUM CHANGE IN LEVEL ALLOWED AT TERRACES CONSTRUCTED OF IMPERVIOUS

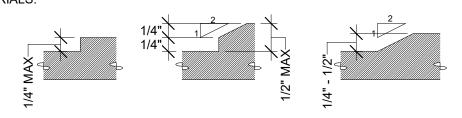

SECTION 304 TURNING SPACE

- . FLOOR OR GROUND SURFACES OF A TURNING SPACE SHALL COMPLY WITH SECTION 302. CHANGES IN LEVEL ARE NOT PERMITTED. SLOPES NOT STEEPER THAN 1:48 SHALL BE PERMITTED. .. THE TURNING SPACE SHALL BE A CIRCULAR SPACE OF 60 INCHES DIAMETER MINIMUM. THE SPACE
- SHALL BE PERMITTED TO INCLUDE KNEE AND TOE CLEARANCE COMPLYING WITH SECTION 306. 2. THE TURNING SPACE SHALL BE A T-SHAPED SPACE WITHIN A 60 INCH MINIMUM SQUARE WITH ARMS AND BASE 36 INCHES WIDE MINIMUM. EACH ARM OF THE T SHALL BE CLEAR OF
- OBSTRUCTIONS 12 MINIMUM IN EACH DIRECTION AND THE BASE SHALL BE CLEAR OF OBSTRUCTIONS 24 INCHES MINIMUM. THE SPACE SHALL BE PERMITTED TO INCLUDE KNEE AND TOE CLEARANCE COMPLYING WITH SECTION 306 ONLY AT THE END OF EITHER THE BASE OF ONE ARM. UNLESS OTHERWISE SPECIFIED, DOORS SHALL BE PERMITTED TO SWING INTO TURNING SPACES.

T-SHAPED TURNING SPACE

SECTION 305 CLEAR FLOOR SPACE

- 1. FLOOR OR GROUND SURFACES OF A CLEAR FLOOR OR GROUND SPACE SHALL COMPLY WITH SECTION 302. CHANGES IN LEVEL ARE NOT PERMITTED. SLOPES NOT STEEPER THAN 1:48 SHALL
- 2. THE CLEAR FLOOR OR GROUND SPACE SHALL BE 30 INCHES MINIMUM BY 48 INCHES MINIMUM.

CIRCULAR TURNING SPACE




- 3. UNLESS OTHERWISE SPECIFIED, CLEAR FLOOR OR GROUND SPACE SHALL BE PERMITTED TO INCLUDE KNEE AND TOE CLEARANCE COMPLYING WITH SECTION 306.
- . UNLESS OTHERWISE SPECIFIED, CLEAR FLOOR OR GROUND SPACE SHALL BE POSITIONED FOR EITHER FORWARD OR PARALLEL APPROACH TO AN ELEMENT.
- 5. ONE FULL UNOBSTRUCTED SIDE OF THE CLEAR FLOOR OR GROUND SPACE SHALL ADJOIN AN ACCESSIBLE ROUTE OR ADJOIN ANOTHER CLEAR FLOOR OR GROUND SPACE.
- 6. ALCOVES SHALL BE 36 INCHES WIDE MINIMUM WHERE THE DEPTH EXCEEDS 24 INCHES.



SECTION 306 KNEE AND TOE CLEARANCE

- . SPACE UNDER AN ELEMENT BETWEEN THE FINISH FLOOR OR GROUND AND 9 INCHES ABOVE THE FINISH FLOOR OR GROUND SHALL BE CONSIDERED TOE CLEARANCE.
- 2. TOE CLEARANCE SHALL EXTEND 25 INCHES MAXIMUM UNDER AN ELEMENT 3. WHERE TOE CLEARANCE IS REQUIRED AT AN ELEMENT AS PART OF A CLEAR FLOOR SPACE, THE
- TOE CLEARANCE SHALL EXTEND 17 INCHES MINIMUM UNDER THE ELEMENT. . SPACE EXTENDING GREATER THAN 6 INCHES BEYOND THE AVAILABLE KNEE CLEARANCE AT 9 INCHES ABOVE THE FINISH FLOOR OR GROUND SHALL NOT BE CONSIDERED TOE CLEARANCE. 5. TOE CLEARANCE SHALL BE 30 INCHES WIDE MINIMUM.



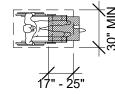


SECTION 306 KNEE AND TOE CLEARANCE (CONT.)

- 6. SPACE UNDER AN ELEMENT BETWEEN 9 INCHES AND 27 INCHES ABOVE THE FINISH FLOOR SHALL
- BE CONSIDERED KNEE CLEARANCE. 7. KNEE CLEARANCE SHALL EXTEND 25 INCHES MAXIMUM UNDER AN ELEMENT AT 9 INCHES ABOVE
- THE FINISH FLOOR OR GROUND. 8. MINIMUM KNEE CLEARANCE IS REQUIRED UNDER AN ELEMENT AS PART OF A CLEAR FLOOR SPACE THE KNEE CLEARANCE SHALL BE 11 INCHES DEEP MINIMUM AT 9 INCHES ABOVE THE FINISH FLOOR OR GROUND, AND 8 INCHES DEEP MINIMUM AT 27 INCHES ABOVE THE FINISH FLOOR OR GROUND. 9. BETWEEN 9 INCHES AND 27 INCHES ABOVE THE FINISH FLOOR OR GROUND, THE KNEE CLEARANCE SHALL BE PERMITTED TO REDUCE AT A RATE OF 1 INCH IN DEPTH FOR EACH 6 INCHES IN HEIGHT.




SECTION 307 PROTRUDING OBJECTS

- 1. OBJECTS WITH LEADING EDGES MORE THAN 27 INCHES AND NOT MORE THAN 80 INCHES ABOVE THE FINISH FLOOR OR GROUND SHALL PROTRUDE 4 INCHES
- MAXIMUM HORIZONTALLY INTO THE CIRCULATION PATH. 2. HANDRAILS SHALL BE PERMITTED TO PROTRUDE 4 1/2 INCHES MAXIMUM.

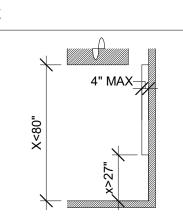

SECTION 308 REACH RANGES

- 1. WHERE A FORWARD REACH IS UNOBSTRUCTED, THE HIGH FORWARD REACH SHALL BE 48 INCHES
- 2. WHERE A HIGH FORWARD REACH IS OVER AN OBSTRUCTION, THE REACH SHALL BE 48 INCHES MAXIMUM WHERE THE REACH DEPTH IS 20 INCHES MAXIMUM. WHERE THE REACH DEPTH EXCEEDS 20 INCHES, THE HIGH FORWARD REACH SHALL BE 44 INCHES MAXIMUM AND THE
- THE LOW SIDE REACH SHALL BE 15 INCHES MINIMUM ABOVE THE FLOOR. 4. WHERE A HIGH SIDE REACH IS OVER AN OBSTRUCTION, THE HEIGHT OF THE OBSTRUCTION SHALL BE 34 INCHES MAXIMUM AND THE DEPTH OF THE OBSTRUCTION SHALL BE 24 INCHES MAXIMUM.
- THE HIGH SIDE REACH SHALL BE 48 INCHES MAXIMUM FOR A REACH DEPTH OF 10 INCHES MAXIMUM. WHERE THE REACH DEPTH EXCEEDS 10 INCHES. THE HIGH SIDE REACH SHALL BE 46 INCHES MAXIMUM FOR A REACH DEPTH OF 24 INCHES MAXIMUM.

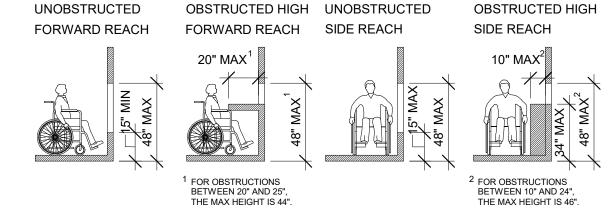


SECTION 309 OPERABLE PARTS

- 1. A CLEAR FLOOR SPACE COMPLYING WITH SECTION 305 SHALL BE PROVIDED.
- 2. OPERABLE PARTS SHALL BE PLACED WITHIN ONE OR MORE OF THE REACH RANGES SPECIFIED IN SECTION 308.
- 3. OPERABLE PARTS SHALL BE OPERABLE WITH ONE HAND AND SHALL NOT REQUIRE TIGHT GRASPING, PINCHING OR TWISTING OF THE WRIST. THE FORCE REQUIRED TO ACTIVATE OPERABLE PARTS SHALL BE 5.0 POUNDS MAXIMUM.


SECTION 403 WALKING SURFACES

LONG MINIMUM AND 36 INCHES WIDE MINIMUM.

- 1 FLOOR OR GROUND SURFACES SHALL COMPLY WITH SECTION 302 2. THE RUNNING SLOPE OF WALKING SURFACES SHALL NOT BE STEEPER THAN 1:20. THE CROSS SLOPE OF WALKING SURFACES SHALL NOT BE STEEPER THAN 1:48.
- 3. CHANGES IN LEVEL SHALL COMPLY WITH SECTION 303. 4. THE CLEAR WIDTH OF WALKING SURFACES SHALL BE 36 INCHES MINIMUM. THE CLEAR WIDTH SHALL BE PERMITTED TO BE REDUCED TO 32 INCHES MINIMUM FOR A LENGTH OF 24 INCHES MAXIMUM PROVIDED THAT REDUCED WIDTH SEGMENTS ARE SEPARATED BY SEGMENTS THAT ARE 48 INCHES

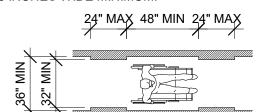


- 5. WHERE THE ACCESSIBLE ROUTE MAKES A 180 DEGREE TURN AROUND AN ELEMENT WHICH IS LESS THAN 48 INCHES WIDE, CLEAR WIDTH SHALL BE 42 INCHES MINIMUM APPROACHING THE TURN, 48
- INCHES MINIMUM AT THE TURN AND 42 INCHES MINIMUM LEAVING THE TURN. 6. WHERE THE CLEAR WIDTH AT THE TURN IS 60 INCHES MINIMUM COMPLIANCE WITH 403.5.2 SHALL NOT BE REQUIRED.

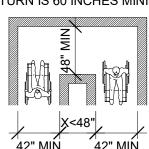

7. AN ACCESSIBLE ROUTE WITH A CLEAR WIDTH LESS THAN 60 INCHES SHALL PROVIDE PASSING SPACES AT INTERVALS OF 200 FEET MAXIMUM, PASSING SPACES SHALL BE EITHER: A SPACE 60 INCHES MINIMUM BY 60 INCHES MINIMUM; OR, AN INTERSECTION OF TWO WALKING SURFACES PROVIDING A T-SHAPED SPACE COMPLYING WITH 304.3.2 WHERE THE BASE AND ARMS OF THE T-SHAPED SPACE EXTEND 48 INCHES MINIMUM BEYOND THE INTERSECTION.

SECTION 404.2.3 CLEAR WIDTH AT DOORS


1. DOOR OPENINGS SHALL PROVIDE A CLEAR WIDTH OF 32 INCHES MINIMUM. CLEAR OPENING OF DOORWAYS WITH SWINGING DOORS SHALL BE MEASURED BETWEEN THE FACE OF THE DOOR AND THE STOP, WITH THE DOOR OPEN 90 DEGREES. THERE SHALL BE NO PROJECTIONS INTO THE REQUIRED CLEAR OPENING WIDTH LOWER THAN 34 INCHES ABOVE THE FINISH FLOOR OR GROUND. PROJECTIONS INTO THE CLEAR OPENING WIDTH BETWEEN 34 INCHES AND 80 INCHES ABOVE THE FINISH FLOOR SHALL NOT EXCEED 4 INCHES.

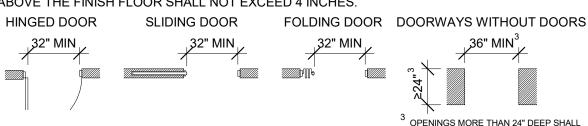


PROVIDE A CLEAR OPENING OF 36" MINIMUM

SECTION 404.2.4 MANEUVERING CLEARANCES AT DOORS

1. MINIMUM MANEUVERING CLEARANCES AT DOORS SHALL COMPLY WITH THE DIAGRAMS BELOW. SWINGING DOORS

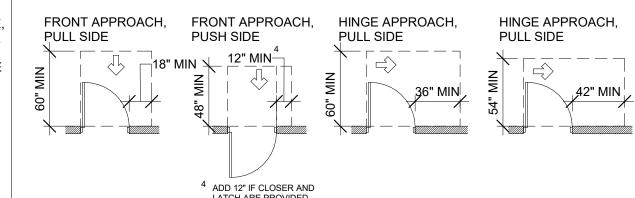

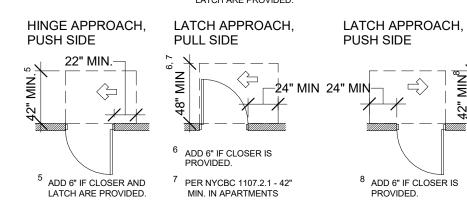

SIDE APPROACH

SLIDING AND FOLDING DOORS


FRONT APPROACH

RECESSED DOORS

PULL SIDE

FRONT APPROACH POCKET OR HINGE STOP OR LATCH APPROACH MAXIMUM AND THE LOW FORWARD REACH SHALL BE 15 INCHES MINIMUM ABOVE THE FLOOR.

REACH DEPTH SHALL BE 25" MAXIMUM. 3. WHERE A SIDE REACH IS UNOBSTRUCTED, HIGH SIDE REACH SHALL BE 48 INCHES MAXIMUM AND DOORWAYS WITHOUT DOORS

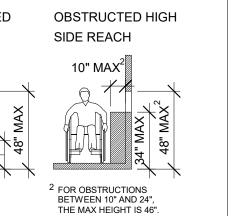


<u>SECTION 404.2.6 TWO DOORS IN SERIES</u>

THE DISTANCE BETWEEN TWO HINGED OR PIVOTED DOORS IN SERIES SHALL BE 48 INCHES MINIMUM PLUS THE WIDTH OF THE DOORS OR GATES SWINGING INTO THE SPACE

PUSH SIDE, DOOR WITH

CLOSER AND LATCH

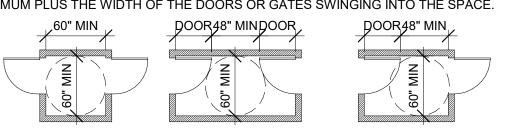

SECTION 404.2.8 CLOSING SPEED


- . DOOR CLOSERS SHALL BE ADJUSTED SO THAT FROM AN OPEN POSITION OF 90 DEGREES, THE TIME REQUIRED TO MOVE THE DOOR TO A POSITION OF 12 DEGREES FROM THE LATCH IS 5 SECOND MINIMUM.
- DOOR SPRING HINGES SHALL BE ADJUSTED SO THAT FROM THE OPEN POSITION OF 70 DEGREES, THE DOOR SHALL MOVE TO THE CLOSED POSITION IN 1.5 SECONDS MINIMUM.

SECTION 404.2.9 DOOR OPENING FORCE

- 1. FIRE DOORS SHALL HAVE A MINIMUM OPENING FORCE ALLOWABLE BY THE APPROPRIATE ADMINISTRATIVE AUTHORITY. THE FORCE FOR PUSHING OR PULLING OPEN A DOOR OTHER THAN FIRE DOORS SHALL BE AS FOLLOWS:
- A) INTERIOR HINGED DOORS AND GATES: 5 POUNDS MAXIMUM. B) SLIDING OR FOLDING DOORS: 5 POUNDS MAXIMUM.
- THESE FORCES DO NOT APPLY TO THE FORCE REQUIRED TO RETRACT LATCH BOLTS OR DISENGAGE OTHER DEVICES THAT HOLD THE DOOR IN A CLOSED POSITION.

SECTION 404.2.10 DOOR SURFACE AND 404.2.11 AND VISION LITES

- SWINGING DOOR SURFACES WITHIN 10 INCHES OF THE FINISH FLOOR OR GROUND MEASURED VERTICALLY SHALL BE A SMOOTH SURFACE ON THE PUSH SIDE EXTENDING THE FULL WIDTH OF THE DOOR.
- . DOORS AND SIDE LIGHTS ADJACENT TO DOORS CONTAINING ONE OR MORE GLAZING PANELS THAT PERMIT VIEWING THROUGH THE PANELS SHALL HAVE THE BOTTOM OF AT LEAST ONE GLAZED PANEL LOCATED 43 INCHES MAXIMUM ABOVE THE FINISH FLOOR. VISION LIGHTS WITH THE LOWEST PART MORE THAN 66 INCHES FROM THE FINISH FLOOR OR GROUND SHALL NOT BE REQUIRED

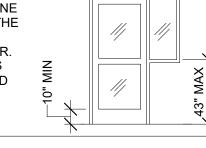

SECTION 405 RAMPS


TO COMPLY.

- . RAMP RUNS SHALL HAVE A RUNNING SLOPE NOT STEEPER THAN 1:12. 2. CROSS SLOPE OF RAMP RUNS SHALL NOT BE STEEPER THAN 1:48.
- 3. THE CLEAR WIDTH OF A RAMP RUN AND, WHERE HANDRAILS ARE PROVIDED, THE CLEAR WIDTH
- BETWEEN HANDRAILS SHALL BE 36 INCHES MINIMUM
- THE RISE FOR ANY RAMP RUN SHALL BE 30 INCHES MAXIMUM. 5. RAMPS SHALL HAVE LANDINGS AT THE TOP AND BOTTOM OF EACH RAMP RUN. LANDINGS SHALL COMPLY WITH SECTION 302. CHANGES IN LEVEL ARE NOT PERMITTED. SLOPES NOT STEEPER THAN 1:48 SHALL BE PERMITTED. THE LANDING CLEAR WIDTH SHALL BE AT LEAST AS WIDE AS THE WIDEST RAMP RUN LEADING TO THE LANDING. THE LANDING CLEAR LENGTH SHALL BE 60 INCHES LONG MINIMUM. RAMPS THAT CHANGE DIRECTION BETWEEN RUNS AT LANDINGS SHALL HAVE A CLEAR LANDING 60 INCHES MINIMUM BY 60 INCHES MINIMUM.

SECTION 405 RAMPS (CONT.) *CLEAR BETWEEN HANDRAILS

6. RAMP RUNS WITH A RISE GREATER THAN 6 INCHES SHALL HAVE HANDRAILS COMPLYING WITH


- . EDGE PROTECTION SHALL BE PROVIDED ON EACH SIDE OF RAMP RUNS AND AT EACH SIDE OF RAMP LANDINGS. EDGE PROTECTION SHALL NOT BE REQUIRED ON RAMPS THAT ARE NOT REQUIRED TO HAVE HANDRAILS AND HAVE SIDES COMPLYING WITH SECTION 406.3. EDGE PROTECTION SHALL NOT BE REQUIRED ON SIDES OF RAMP LANDINGS SERVING AN ADJOINING RAMP RUN OR STAIRWAY. EDGE PROTECTION SHALL NOT BE REQUIRED ON THE SIDES OF RAMP LANDINGS HAVING A VERTICAL DROP-OFF OF 1/2 INCH MAXIMUM WITHIN 10 INCHES HORIZONTALLY
- OF THE MINIMUM LANDING AREA. A) THE FLOOR OR GROUND SURFACE OF THE RAMP RUN OR LANDING SHALL EXTEND 12 INCHES MINIMUM BEYOND THE INSIDE FACE OF A HANDRAIL COMPLYING WITH SECTION 505.
- B) A CURB BARRIER SHALL BE PROVIDED THAT PREVENTS THE PASSAGE OF A 4 INCH DIAMETER SPHERE, WHERE ANY PORTION OF THE SPHERE IS WITHIN 4 INCHES OF THE FINISH FLOOR OR GROUND SURFACE.

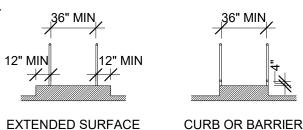

SECTION 406 CURB RAMPS


- 1. CURB RAMPS SHALL NOT BE STEEPER THAN 1:12. 2. COUNTER SLOPES OF ADJOINING GUTTERS AND ROAD SURFACES IMMEDIATELY ADJACENT TO THE CURB RAMP SHALL NOT BE STEEPER THAN 1:20. THE ADJACENT SURFACES AT TRANSITIONS
- AT CURB RAMPS TO WALKS, GUTTERS, AND STREETS SHALL BE AT THE SAME LEVEL 3. WHERE PROVIDED, CURB RAMP FLARES SHALL NOT BE
- STEEPER THAN 1:10. 4. CURB RAMPS SHALL BE 36 INCHES MINIMUM IN WIDTH EXCLUSIVE OF FLARED SIDES.
- 5. LANDINGS SHALL BE PROVIDED AT THE TOPS OF CURB RAMPS. THE LANDING CLEAR LENGTH SHALL BE 36 INCHES MINIMUM. THE LANDING CLEAR WIDTH SHALL BE AT LEAST AS WIDE AS THE CURB RAMP, EXCLUDING

FLARED SIDES, LEADING TO THE LANDING.

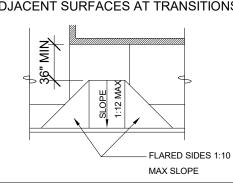


SECTION 407 ELEVATORS

- 1. ELEVATOR CALL BUTTONS AT ELEVATOR LANDINGS SHALL BE RAISED OR FLUSH. 2. CALL BUTTONS SHALL BE LOCATED WITHIN ONE OF THE REACH RANGES SPECIFIED IN SECTION 308, MEASURED TO THE CENTERLINE OF THE HIGHEST OPERABLE PART. 3. CALL BUTTONS SHALL BE 3/4 INCH MINIMUM IN THE SMALLEST DIMENSION.
- 4. A CLEAR FLOOR SPACE COMPLYING WITH SECTION 305 SHALL BE PROVIDED AT CALL CONTROLS. 5. THE CALL BUTTON THAT DESIGNATES THE UP DIRECTION SHALL BE LOCATED ABOVE THE CALL
- BUTTON THAT DESIGNATES THE DOWN DIRECTION. 6. FLOOR DESIGNATIONS SHALL BE PROVIDED ON BOTH JAMBS OF ELEVATOR HOISTWAY ENTRANCES. FLOOR DESIGNATIONS SHALL BE PROVIDED IN BOTH TACTILE CHARACTERS AND BRAILLE. TACTILE CHARACTERS SHALL BE 2 INCHES HIGH MINIMUM. A TACTILE STAR SHALL BE PROVIDED ON BOTH JAMBS AT THE MAIN ENTRY LEVEL.
- 7. DOOR WIDTH AND INSIDE DIMENSIONS OF ELEVATOR CARS SHALL COMPLY WITH THE DIAGRAMS

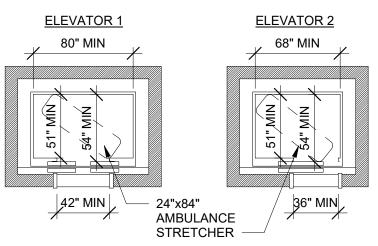

SECTION 505 HANDRAILS

- HANDRAILS SHALL BE PROVIDED ON BOTH SIDES OF STAIRS AND RAMPS.
- 2. HANDRAILS SHALL BE CONTINUOUS WITHIN THE FULL LENGTH OF EACH STAIR FLIGHT OR RAMP RUN. INSIDE HANDRAILS ON SWITCHBACK OR DOGLEG STAIRS AND RAMPS SHALL BE CONTINUOUS BETWEEN FLIGHTS OR RUNS.
- 3. TOP OF GRIPPING SURFACES OF HANDRAILS SHALL BE 34 INCHES MINIMUM AND 38 INCHES MAXIMUM VERTICALLY ABOVE WALKING SURFACES, STAIR NOSINGS, AND RAMP SURFACES. HANDRAILS SHALL BE AT A CONSISTENT HEIGHT ABOVE WALKING SURFACES. STAIR NOSINGS. AND RAMP SURFACES.
- 4. CLEARANCE BETWEEN HANDRAIL GRIPPING SURFACES AND ADJACENT SURFACES SHALL BE 1 1/2 INCHES MINIMUM
- 5. HANDRAIL GRIPPING SURFACES SHALL BE CONTINUOUS ALONG THEIR LENGTH AND SHALL NOT BE OBSTRUCTED ALONG THEIR TOPS OR SIDES. THE BOTTOMS OF HANDRAIL GRIPPING SURFACES SHALL NOT BE OBSTRUCTED FOR MORE THAN 20 PERCENT OF THEIR LENGTH. WHERE PROVIDED HORIZONTAL PROJECTIONS SHALL OCCUR 1 1/2 INCHES MINIMUM BELOW THE BOTTOM OF THE HANDRAIL GRIPPING SURFACE.
- 6. HANDRAIL GRIPPING SURFACES SHALL EXTEND BEYOND AND IN THE SAME DIRECTION OF STAIR FLIGHTS AND RAMP RUNS. RAMP HANDRAILS SHALL EXTEND HORIZONTALLY ABOVE THE LANDING 12 INCHES MINIMUM BEYOND THE TOP AND BOTTOM OF RAMP RUNS. EXTENSIONS SHALL RETURN TO A WALL, GUARD, OR THE LANDING SURFACE, OR SHALL BE CONTINUOUS TO THE HANDRAIL OF AN ADJACENT RAMP RUN. AT THE TOP OF A STAIR FLIGHT, HANDRAILS SHALL EXTEND HORIZONTALLY ABOVE THE LANDING FOR 12 INCHES MINIMUM BEGINNING DIRECTLY ABOVE THE FIRST FLOOR RISER NOSING. EXTENSIONS SHALL RETURN TO A WALL, GUARD, OR THE LANDING SURFACE, OR SHALL BE CONTINUOUS TO THE HANDRAIL OF AN ADJACENT STAIR FLIGHT. AT THE BOTTOM OF A STAIR FLIGHT, HANDRAILS SHALL EXTEND AT THE SLOPE OF THE STAIR FLIGHT FOR A HORIZONTAL DISTANCE EQUAL TO ONE TREAD DEPTH BEYOND THE LAST RISER NOSING. EXTENSIONS SHALL RETURN TO A WALL, GUARD, OR THE LANDING SURFACE, OR SHALL BE
- CONTINUOUS TO THE HANDRAIL OF AN ADJACENT STAIR FLIGHT. . HANDRAIL EXTENSION DIMENSION IS FOR STRAIGHT RAIL ONLY. DIMENSION DOES NOT INCLUDE RADIUSED CORNERS.

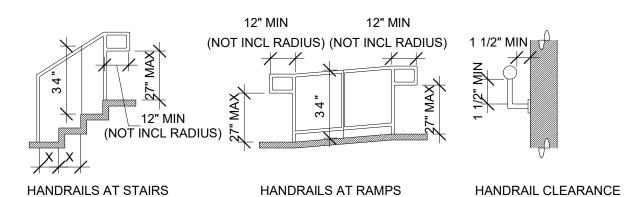

DOB APPROVAL STAMPS



515 Broadway, Albany, New York, 12207-2964 One Penn Plaza, 52 Floor, NY, NY 10119-0098 539 Franklin Street, Buffalo, NY 14202-1109

WWW.DASNY.ORG SE DOCUMENTS CONTAIN POTENTIALLY SENSITIVE INFORMATION AND SHALL D FOR THEIR INTENDED PURPOSE. ONCE THE INTENDED PURPOSE HAS CEASED, HE DOCUMENTS SHALL BE DESTROYED IN A SECURE MANNER.

IS A VIOLATION OF STATE EDUCATION LAW FOR ANY PERSON, UNLESS UNDER T RECTION OF A LICENSED ARCHITECT / ENGINEER TO ALTER THIS DOCUMENT IN ANY WAY, ALTERATIONS MUST HAVE THE SEAL AFFIXED ALONG WITH A DESCRIPTION OF THE ALTERATIONS, DATE AND ARCHITECT'S / ENGINEER'S SIGNATURE. COPYRIG


Curtis + ONE BATTERY PARK PLAZA, insberg FL 27 Architects NEW YORK, NEW YORK 10004

ARCHITECTS


CURTIS + GINSBERG

Merritt Engineering 8-08 Bayside Lane, Queens, NY 11358

> The LiRo Group 235 East Jericho Turnpike, Mineola, NY 11501

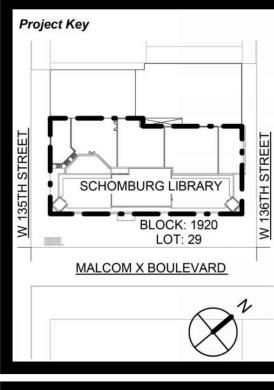


REVIS	REVISIONS				
Rev No	Description	Date:			
1					
<u>2</u>					
<u>3</u>					
<u>4</u>					
<u>/</u> 5					
<u>6</u>					
<u> </u>					
8					
<u> 2</u>					

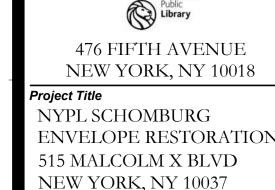

Drawing Title ACCESSIBLITY

> **90**% CD SUBMISSION Drawn By: | Checked By: | Date: DC/RE DASNY Project N



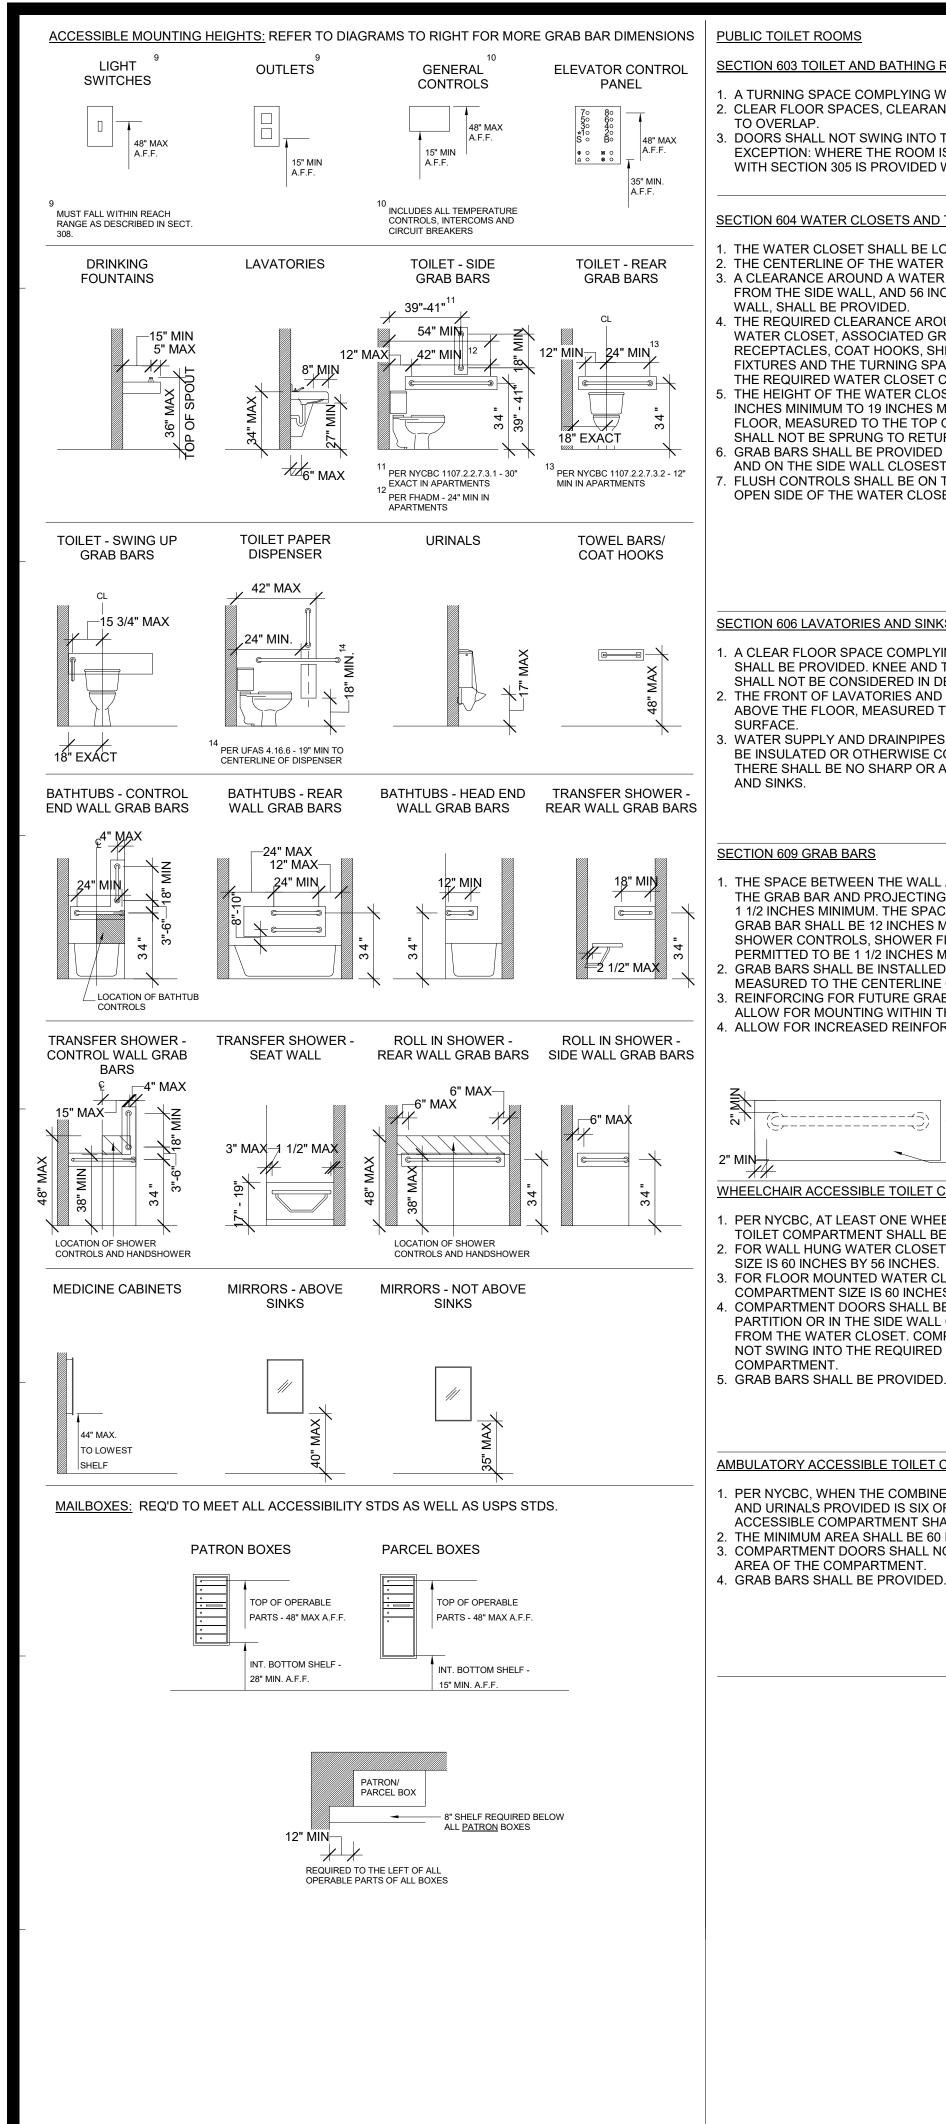


SECTION 603 TOILET AND BATHING ROOMS

- . A TURNING SPACE COMPLYING WITH SECTION 304 SHALL BE PROVIDED WITHIN THE ROOM. 2. CLEAR FLOOR SPACES, CLEARANCES AT FIXTURES AND TURNING SPACES SHALL BE PERMITTED
- . DOORS SHALL NOT SWING INTO THE CLEAR FLOOR SPACE OR CLEARANCE FOR ANY FIXTURE. EXCEPTION: WHERE THE ROOM IS FOR INDIVIDUAL USE AND A CLEAR FLOOR SPACE COMPLYING WITH SECTION 305 IS PROVIDED WITHIN THE ROOM BEYOND THE ARC OF THE DOOR SWING.


SECTION 604 WATER CLOSETS AND TOILET COMPARTMENTS

- THE WATER CLOSET SHALL BE LOCATED WITH A WALL OR PARTITION TO THE REAR AND ONE SIDE. . THE CENTERLINE OF THE WATER CLOSET SHALL BE 18 INCHES FROM THE SIDE WALL OR PARTITION.
- 3. A CLEARANCE AROUND A WATER CLOSET 60 INCHES MINIMUM, MEASURED PERPENDICULAR FROM THE SIDE WALL, AND 56 INCHES MINIMUM, MEASURED PERPENDICULAR FROM THE REAR WALL, SHALL BE PROVIDED. . THE REQUIRED CLEARANCE AROUND THE WATER CLOSET SHALL BE PERMITTED TO OVERLAP THE
- WATER CLOSET, ASSOCIATED GRAB BARS, PAPER DISPENSERS, SANITARY NAPKIN RECEPTACLES, COAT HOOKS, SHELVES, ACCESSIBLE ROUTES, CLEAR FLOOR SPACE AT OTHER FIXTURES AND THE TURNING SPACE. NO OTHER FIXTURES OR OBSTRUCTIONS SHALL BE WITHIN THE REQUIRED WATER CLOSET CLEARANCE.
- THE HEIGHT OF THE WATER CLOSET SEATS SHALL BE 17 INCHES MINIMUM TO 19 INCHES MAXIMUM ABOVE THE FLOOR, MEASURED TO THE TOP OF THE SEAT. SEATS SHALL NOT BE SPRUNG TO RETURN TO A LIFTED POSITION GRAB BARS SHALL BE PROVIDED ON THE REAR WALL
- AND ON THE SIDE WALL CLOSEST TO THE WATER CLOSET FLUSH CONTROLS SHALL BE ON THE OPEN SIDE OF THE WATER CLOSET.

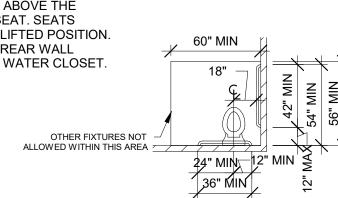


SECTION 606 LAVATORIES AND SINKS

- A CLEAR FLOOR SPACE COMPLYING WITH SECTION 305, POSITIONED FOR FORWARD APPROACH. SHALL BE PROVIDED. KNEE AND TOE CLEARANCE SHALL BE PROVIDED. THE DIP OF THE OVERFLOW SHALL NOT BE CONSIDERED IN DETERMINING KNEE AND TOE CLEARANCES.
- THE FRONT OF LAVATORIES AND SINKS SHALL BE 34 INCHES MAXIMUM ABOVE THE FLOOR, MEASURED TO THE HIGHER OF THE RIM OR COUNTER
- WATER SUPPLY AND DRAINPIPES UNDER LAVATORIES AND SINKS SHALL BE INSULATED OR OTHERWISE CONFIGURED TO PROTECT AGAINST CONTACT. THERE SHALL BE NO SHARP OR ABRASIVE SURFACES UNDER LAVATORIES AND SINKS.

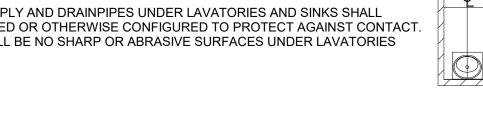


SECTION 609 GRAB BARS

- THE SPACE BETWEEN THE WALL AND THE GRAB BAR SHALL BE 1 1/2 INCHES. THE SPACE BETWEEN THE GRAB BAR AND PROJECTING OBJECTS BELOW AND AT THE ENDS OF THE GRAB BAR SHALL BE 1 1/2 INCHES MINIMUM. THE SPACE BETWEEN THE GRAB BAR AND PROJECTING OBJECTS ABOVE THE GRAB BAR SHALL BE 12 INCHES MINIMUM. EXCEPTION: THE SPACE BETWEEN GRAB BARS AND SHOWER CONTROLS, SHOWER FITTINGS, AND OTHER GRAB BARS ABOVE THE GRAB BAR SHALL BE PERMITTED TO BE 1 1/2 INCHES MINIMUM.
- GRAB BARS SHALL BE INSTALLED IN A HORIZONTAL POSITION, 84 INCHES ABOVE THE FLOOR MEASURED TO THE CENTERLINE OF THE GRAB BAR.
- . REINFORCING FOR FUTURE GRAB BARS SHALL EXTEND BEYOND THE GIVEN GRAB BAR LENGTH AND ALLOW FOR MOUNTING WITHIN THE REQUIRED MOUNTING RANGES. SEE #2 ABOVE 4. ALLOW FOR INCREASED REINFORCING AT FOLD-UP GRAB BARS.

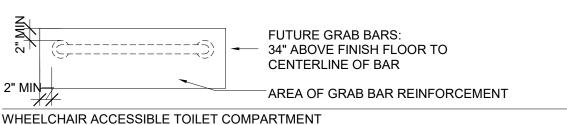


- PER NYCBC, AT LEAST ONE WHEELCHAIR ACCESSIBLE TOILET COMPARTMENT SHALL BE PROVIDED.
- 2. FOR WALL HUNG WATER CLOSETS, MINIMUM COMPARTMENT SIZE IS 60 INCHES BY 56 INCHES. 3. FOR FLOOR MOUNTED WATER CLOSETS, MINIMUM
- COMPARTMENT SIZE IS 60 INCHES BY 59 INCHES. COMPARTMENT DOORS SHALL BE LOCATED IN THE FRONT PARTITION OR IN THE SIDE WALL OR PARTITION FARTHEST FROM THE WATER CLOSET. COMPARTMENT DOORS SHALL
- NOT SWING INTO THE REQUIRED MINIMUM AREA OF THE COMPARTMENT. 5. GRAB BARS SHALL BE PROVIDED.

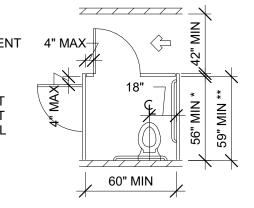

* AT WALL HUNG WATER CLOSETS ** AT FLOOR MOUNTED WATER CLOSETS

AMBULATORY ACCESSIBLE TOILET COMPARTMENT

- . PER NYCBC, WHEN THE COMBINED TOTAL WATER CLOSET COMPARTMENTS AND URINALS PROVIDED IS SIX OR MORE, AT LEAST ONE AMBULATORY
- ACCESSIBLE COMPARTMENT SHALL BE PROVIDED. THE MINIMUM AREA SHALL BE 60 INCHES BY 36 INCHES. 3. COMPARTMENT DOORS SHALL NOT SWING INTO THE REQUIRED MINIMUM
- AREA OF THE COMPARTMENT.

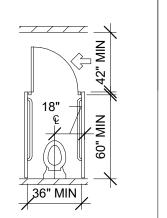


RESIDENTIAL BATHROOMS

BATHROOMS IN RESIDENTIAL BUILDINGS

- I. FOR ALL ADAPTABLE TYPE B BATHROOMS IN RESIDENTIAL BUILDINGS GRAB BARS ARE NOT REQUIRED WHERE APPROPRIATE REINFORCING IS PROVIDED AND LOCATED FOR FUTURE GRAB
- BAR INSTALLATION. 2. ALL LAVATORIES ARE TO BE WALL HUNG WITH REMOVABLE VANITY BELOW.
- 3. FOR GRAB BAR HEIGHTS SEE "MOUNTING HEIGHTS" ON PREVIOUS PAGE.


BATHROOMS WITH SHOWERS

- 1. SEE FOLLOWING DIAGRAMS FOR SHOWER CLEARANCES.
- 2. SINK PERMITTED IN CLEAR FLOOR SPACE AT SHOWER CONTROL END FOR ROLL-IN SHOWER PER ANSI A117.1 SECTION 608.2.2.
- 3. THRESHOLDS AT ROLL-IN AND TRANSFER TYPE SHOWERS SHALL BE 1/2 " MAX. IN HEIGHT.

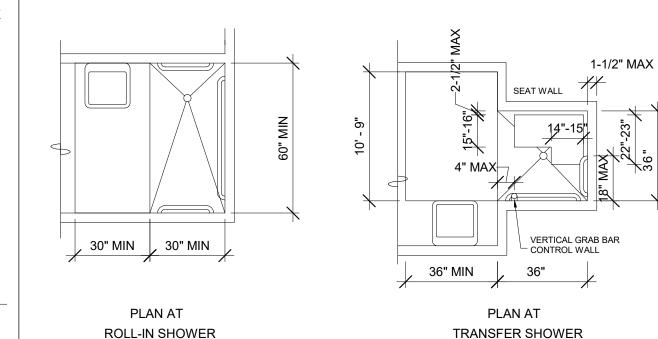


SECTION AT REMOVABLE VANITY CABINET

- ALL VANITY CABINETS IN RESIDENTIAL DWELLING UNITS TO BE REMOVABLE. INSULATED PIPE PROTECTION TO BE INSTALLED WHEN CABINET IS REMOVED.
- MUST PROVIDE FINISHED FLOOR AND WALLS WHERE CABINET IS REMOVED.
- 30" X 48" CLEAR FLOOR SPACE IS REQUIRED TO BE CENTERED ON SINK ONLY 19" OF CLEAR FLOOR SPACE MAY EXTEND UNDER SINK

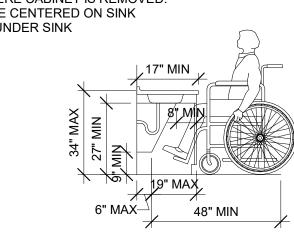


BATHROOM CONFIGURATION 1

- . PROVIDE A 66" X 48" CLEAR FLOOR SPACE AT TOILET ONLY TO BE OVERLAPPED BY SINK PROVIDED THERE IS AN 18" MINIMUM SPACE FROM SINK TO CENTERLINE OF TOILET 2. PROVIDE A 30" X 48" CLEAR FLOOR SPACE CENTERED ON SINK
- 3. PROVIDE A 30" X 48" CLEAR FLOOR SPACE AT BATH, ALIGNED WITH SHOWER CONTROL END; TO BE OVERLAPPED ONLY BY SINK UP TO A MAX. OF 19".

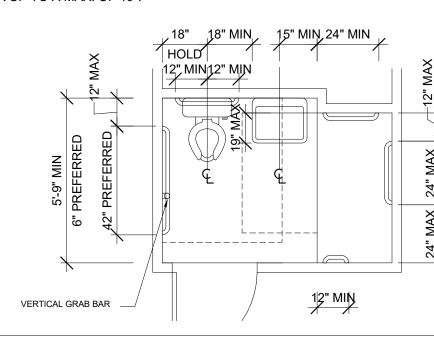

BATHROOM CONFIGURATION 2:

- . PROVIDE A 56" X 48" CLEAR FLOOR SPACE AT TOILET ONLY TO BE OVERLAPPED BY SINK PROVIDED.
- THERE IS AN 18" MINIMUM SPACE FROM SINK TO CENTERLINE OF TOILET . PROVIDE A 30" X 48" CLEAR FLOOR SPACE CENTERED ON SINK
- 3. PROVIDE A 30"X 48" CLEAR FLOOR SPACE AT BATH, ALIGNED WITH SHOWER CONTROL END; TO BE OVERLAPPED ONLY BY SINK UP TO A MAX. OF 19".

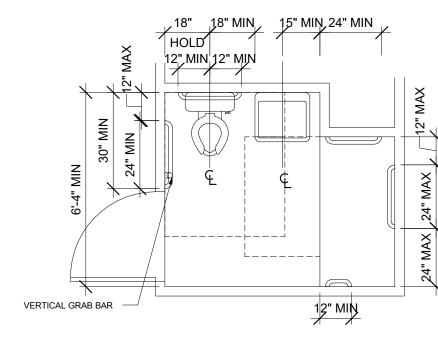



RESIDENTIAL KITCHENS


- PROVIDE 30" REMOVABLE CABINET UNDER SINK WITH FINISHED WALLS, FLOOR AND SIDE CABINETS, AND INSULATED PIPE PROTECTION.
- PROVIDE ADDITIONAL 30" REMOVABLE CABINET TO BE USED AS WORK SURFACE AT 34" ABOVE FINISHED FLOOR: OR PROVIDE A COUNTER ADJUSTABLE BETWEEN 29" AND 36" ABOVE FINISHED
- 3. PROVIDE 30" X 48" CLEAR FLOOR SPACE CENTERED ON EACH APPLIANCE FOR PARALLEL
- APPROACH 4. PROVIDE A SELF-CLEANING OVEN.

CABINET REQ'D

5. PROVIDE A SELF-DEFROSTING FREEZER WHEN LESS THAN 100% OF FREEZER IS WITHIN 54" REACH RANGE ABOVE FINISHED FLOOR.

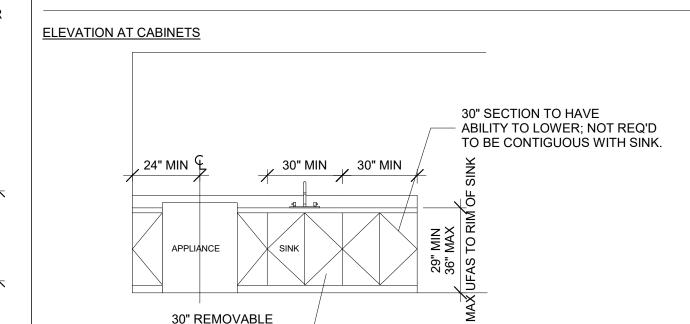


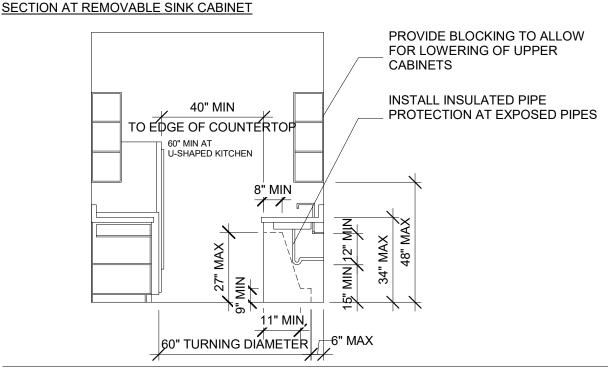

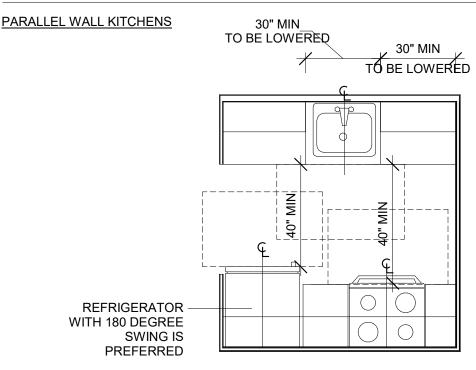

U-SHAPED KITCHENS

. THE FOLLOWING DIAGRAM APPLIES WHEN THE RANGE OR SINK IS AT THE BOTTOM OF THE U-SHAPE.

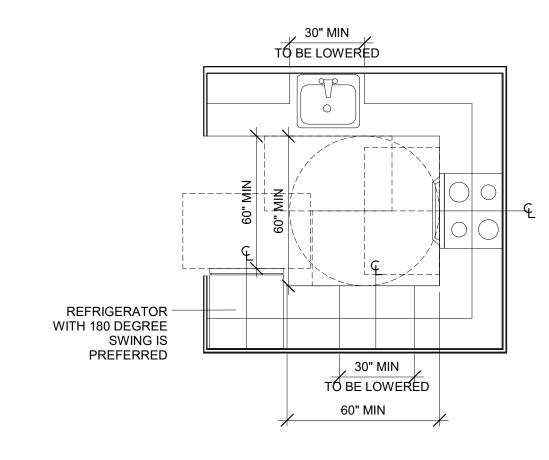

DOB APPROVAL STAMPS



515 Broadway, Albany, New York, 12207-2964 One Penn Plaza, 52 Floor, NY, NY 10119-0098 539 Franklin Street, Buffalo, NY 14202-1109 WWW.DASNY.ORG


SE DOCUMENTS CONTAIN POTENTIALLY SENSITIVE INFORMATION AND SHALL

D FOR THEIR INTENDED PURPOSE. ONCE THE INTENDED PURPOSE HAS CEASED, HE DOCUMENTS SHALL BE DESTROYED IN A SECURE MANNER. T IS A VIOLATION OF STATE EDUCATION LAW FOR ANY PERSON, UNLESS UNDER T DIRECTION OF A LICENSED ARCHITECT / ENGINEER TO ALTER THIS DOCUMENT IN ANY WAY, ALTERATIONS MUST HAVE THE SEAL AFFIXED ALONG WITH A DESCRIPTION OF THE ALTERATIONS, DATE AND ARCHITECT'S / ENGINEER'S SIGNATURE. COPYRIG


onsultants CURTIS + GINSBERG ARCHITECTS Curtis + ARCHITECTS
ONE BATTERY PARK PLAZA, Ginsberg FL 27 Architects NEW YORK, NEW YORK 10004

Merritt Engineering 28-08 Bayside Lane, Queens, NY 11358


The LiRo Group 235 East Jericho Turnpike, Mineola, NY 11501

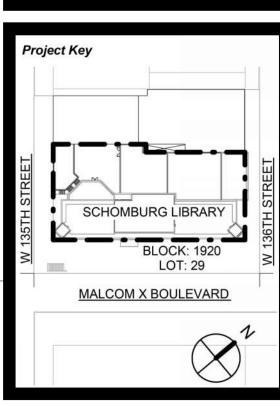


REVISIONS		
Rev No	Description	Date:
11		
<u>^2</u>		
3		
4		
<u></u> 5		
<u>6</u>		
<u> </u>		
8		
9		

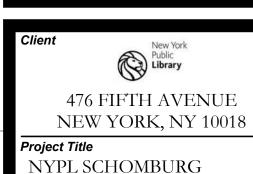

ENVELOPE RESTORATION 515 MALCOLM X BLVD NEW YORK, NY 10037 Drawing Title ACCESSIBLITY

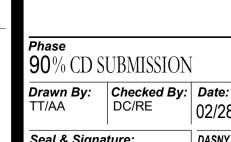

NOTES II

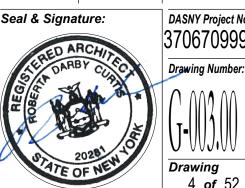

BUILDING INFORMATION

ADDRESS	515 MALCOLM X BOULEVARD (503 LENOX AVENUE),
	MANHATTAN, NY. 10037
BIN	1058276
BLOCK	1920
LOT	29
ZONING DISTRICT	R7-2, C1-4
ZONING MAP	6a
FIRE INDEX	1
INSIDE FIRE DISTRICT	YES
COMMUNITY BOARD	10
HISTORIC DISTRICT	N/A
CURRENT C OF O #	1058276 (TEMPORARY)
OCCUPANCY GROUP	E - EDUCATIONAL
ZONING USE GROUP	3, LIBRARY
CONST. CLASS	1-C: 2 HR PROTECTED
BUILDING HEIGHT	60' - 10"
BUILDING STORIES	4
LOT SIZE	199.08' X 100'
LOT AREA	19,910 SF

PROPOSED SCOPE OF WORK UNDER THIS APPLICATION

EXTERIOR RESTORATION OF EXISTING COMMUNITY FACILITY (LIBRARY). BUILDING SCOPE OF WORK INCLUDES PARTIAL ROOF REPLACEMENT, SELECTIVE WINDOW REPLACEMENT, SELECTIVE DOOR REPLACEMENT, AND MASONRY RESTORATION.

THERE IS NO CHANGE PROPOSED TO THE USE, EGRESS, OR OCCUPANCY OF THE BUILDING.

DEPARTMENT OF BUILDINGS RESPONSIBILITY CHART

S = SIGNOFF

AGENCY	WORK TYPE	APPLICATION TYPE	APPLICATION #	ARCHITECT/ OWNER	CONTRACTOR
DOB	ALT-GC	ALT. II		A/I	P/S/C

REQUIRED INSPECTIONS

SPECIAL INSPECTIONS

P = PERMITS

DOB FORM	INSPECTION TYPE	INSPECTION PROCEDURE
TR-1	MASONRY	BC 1705.4
TR-1	FIRE-RESISTANT PENETRATIONS AND JOINTS	BC 1705.17
TR-1	STRUCTURAL STABILITY	BC 1705.25
TR-1	POST-INSTALLED ANCHORS (BB# 2014-018, 2014-019)	BC 1705.37

PROGRESS INSPECTIONS

DOB FORM	INSPECTION TYPE	INSPECTION PROCEDURE
TR-8	ENERGY CODE COMPLIANCE INSPECTIONS	BC 110.3.5
TR-8	INSULATION PLACEMENT AND R-VALUES	(IA2),(IIA2)
TR-8	FENESTRATION AND DOOR U-FACTOR AND	
	PRODUCT RATINGS	(IA3),(IIA3)
TR-8	FENESTRATION AIR LEAKAGE	(IA4),(IIA4)
TR-8	FENESTRATION AREAS	(IA5),(IIA5)
TR-8	VESTIBULES	(IIA9)
TR-1	FIRE-RESISTANCE RATED CONSTRUCTION	BC 110.3.4
TR-1	FINAL INSPECTION	28-114, 28-116, BC 110.5

NOTE: INSPECTION LISTED ARE BASED ON KNOWN SCOPE OF WORK AND ARE SUBJECT TO CHANGE, UNUSED INSPECTIONS CAN BE WAIVED AT ANY TIME, ADDED INSPECTIONS SHALL

FLOOD ZONE COMPLIANCE NOTE

THIS PROPERTY IS NOT LOCATED IN A SPECIAL FLOOD HAZARD AREA (SFHA). SEE FEMA FLOOD INSURANCE RATE MAP ON V-002 FOR PROPERTY LOCATION.

APPLICABLE CODES

1968 BUILDING CODE OF NEW YORK CITY

NYC BUILDING CODE 2022 (WHERE 1968 CODE NOT APPLICABLE) NYC MECHANICAL CODE 2022

NYC PLUMBING CODE 2022

NYC FIRE CODE 2022 NYC FUEL GAS CODE 2022

NYC ENERGY CONSERVATION CODE 2020

2010 ADA STANDARDS ANSI ICC A117.1-2009

NYC CONSTRUCTION CODE SUMMARY

2022 GENERAL ADMINISTRATIVE PROVISIONS, CHAPTER 1 - ADMINISTRATION

§28-101.3.1 OCCUPANCY CLASSIFICATIONS IN PRIOR CODES. WITH REGARD TO PRIOR CODE BUILDINGS, REFERENCES TO OCCUPANCY CLASSIFICATIONS IN THIS CODE SHALL BE DEEMED TO REFER TO THE EQUIVALENT OCCUPANCY CLASSIFICATION UNDER THE 1968 OR PRIOR BUILDING

1968 CODE OCCUPANCY GROUP IS "G" EDUCATIONAL (LIBRARY)

§28-101.4.3 OPTIONAL USE OF THE 1968 BUILDING CODE FOR WORK ON PRIOR CODE BUILDINGS: AT THE OPTION OF THE OWNER, AND SUBJECT TO APPLICABLE PROVISIONS OF THIS CODE, WORK ON PRIOR CODE BUILDINGS MAY BE PERFORMED IN ACCORDANCE WITH THE REQUIREMENTS SET FORTH IN THE 1968 BUILDING CODE, OR WHERE THE 1968 CODE SO AUTHORIZES, THE CODE IN EFFECT PRIOR TO DECEMBER 6, 1968.

EXCEPTIONS: 1. FUEL GAS, PLUMBING AND MECHANICAL WORK: THE INSTALLATION AND WORK ON ALL APPLIANCES, EQUIPMENT, AND SYSTEMS TO BE GOVERNED BY 2022 FUEL GAS CODE, 2022 PLUMBING CODE, AND 2022 MECHANICAL CODE. REFER TO RELATED PLUMBING AND

MECHANICAL FILINGS. 2. FIRE PROTECTION SYSTEMS: THE ALTERATION AND CHANGE OF USE OR OCCUPANCY TO BE GOVERNED BY CHAPTER 9 OF 2022 BUILDING CODE AS REQUIRED. REFER TO RELATED FIRE

PROTECTION FILING. 3. **ELEVATORS (...):** THE INSTALLATION OF AND WORK ON ELEVATORS TO BE GOVERNED BY

CHAPTER 30 AND APPENDIX K OF 2022 BUILDING CODE AS REQUIRED.

4. SAFETY DURING CONSTRUCTION OPERATIONS: SAFETY OF PUBLIC AND PROPERTY DURING CONSTRUCTION OPERATIONS TO BE GOVERNED BY CHAPTER 33 OF 2022 BUILDING CODE. 5. ACCESSIBILITY: THE ALTERATION AND CHANGES OF USE OR OCCUPANCY TO BE GOVERNED BY

CHAPTER 11 OF 2022 BUILDING CODE AS REQUIRED. 6. ENCROACHMENTS INTO THE PUBLIC RIGHT OF WAY: ENCROACHMENTS ONTO THE PUBLIC

RIGHT OF WAY TO BE GOVERNED BY CHAPTER 32 OF 2022 BUILDING CODE. 7. ADMINISTRATION AND ENFORCEMENT: ADMINISTRATION AND ENFORCEMENT TO BE GOVERNED BY 2022 CONSTRUCTION CODE.

8. SPECIAL INSPECTIONS: CONTROLLED INSPECTIONS AND SEMI-CONTROLLED INSPECTIONS AS REFERENCED IN THE 1968 BUILDING CODE SHALL BE DEEMED SPECIAL INSPECTIONS AND BE GOVERNED BY 2022 CONSTRUCTION CODE.

9. MATERIALS: MATERIALS REGULATED IN THEIR USE BY THE 1968 BUILDING CODE TO BE SUBJECT TO APPLICABLE PROVISIONS OF 2022 CONSTRUCTION CODE.

10. **SECURITY GRILLES:** THE INSTALLATION AND REPLACEMENT OF SECURITY GRILLES TO BE

GOVERNED BY SECTION 1010.1.4.4 OF 2022 BUILDING CODE. 11. ENERGY EFFICIENCY: NOT APPLICABLE. REFER TO 2020 NYC ENERGY CONSERVATION CODE

COMPLIANCE NOTE. 12. ROOF RECOVERING AND REPLACEMENTS:

A. INSTALLATION AND MATERIALS: RECOVERING OR REPLACING OF AN EXISTING ROOF COVERING TO BE GOVERNED BY SECTIONS 1511.1 THROUGH 1511.7 OF 2022 BUILDING CODE. B. COOL ROOFS: RECOVERING OR REPLACING OF AN EXISTING ROOF COVERING TO BE

GOVERNED BY SECTION 1504.9 OF 2022 BUILDING CODE UNLESS THE AREA TO BE RECOVERED OR REPLACED IS LESS THAN 50% THE ROOF AREA AND LESS THAN 500 SF. C. GREEN ROOFS: GREEN ROOF SYSTEMS AND CONTAINER GARDENS SHALL BE PERMITTED TO

BE PERFORMED PURSUANT TO CHAPTER 15 OF 2022 BUILDING CODE. D. SUSTAINABLE ROOFS: REPLACING OF AN ENTIRE EXISTING ROOF DECK OR ROOF ASSEMBLY TO COMPLY WITH SECTION 1512.2 OF 2022 BUILDING CODE.

13. HANDRAILS: THE ALTERATIONS, INCLUDING THE ADDITION OR REPLACEMENT OF AN ENTIRE STAIR ENCLOSURE INCLUDING THE STAIRS, TO COMPLY WITH SECTIONS 1011.11 AND 1014 OF 2022 BUILDING CODE. THE ALTERATIONS, INCLUDING THE ADDITION OR REPLACEMENT OF RAMPS, TO COMPLY WITH SECTIONS 1012.8 AND 1014 OF 2022 BUILDING CODE.

14. GUARDS: THE ALTERATIONS OR REPAIRS, INVOLVING THE ADDITION OR REPLACEMENT OF GUARDS, TO COMPLY WITH SECTIONS 1015 AND 1607.8 OF 2022 BUILDING CODE. 15. FLOOD HAZARD AREAS: NOT APPLICABLE. REFER TO FLOOD ZONE COMPLIANCE NOTE.

16. STRUCTURAL: THE USE OF LOAD RESISTANCE FACTOR DESIGN (LRFD), CALCULATION OF LIVE LOADS, AND APPLICABILITY OF SEISMIC AND WIND LOADS TO BE GOVERNED BY SPECIAL PROVISIONS FOR PRIOR CODE BUILDINGS AS SET FORTH IN SECTION 1601.2 OF 2022 BUILDING CODE. REFER TO RELATED STRUCTURAL FILING.

17. EMERGENCY AND STANDBY POWER SYSTEMS: THE INSTALLATION OF EMERGENCY AND STANDBY POWER SYSTEMS TO COMPLY WITH SECTION 2702.1 OF 2022 BUILDING CODE. 18. PARKING GARAGES AND OPEN PARKING LOTS: NOT APPLICABLE.

19. MOLD PROTECTION: THE ALTERATIONS ARE TO COMPLY WITH SECTIONS 2506 AND 2509 OF 2022 BUILDING CODE RELATING TO AREAS SUBJECT TO MOISTURE OR WATER DAMAGE. 20. EXTERIOR GLAZING: NOT APPLICABLE. REFER TO BIRD FRIENDLY MATERIALS COMPLIANCE

§28-101.4.4 REDUCTIONS OF FIRE SAFETY OR STRUCTURAL SAFETY OF PRIOR CODE BUILDINGS PROHIBITED.

NO REDUCTIONS OF FIRE SAFETY OR STRUCTURAL SAFETY PROPOSED §28-101.4.5 WORK THAT INCREASES EXISTING FLOOR SURFACE AREA OF A PRIOR CODE BUILDING BY MORE THAN 110 PERCENT.

NOT APPLICABLE, ENLARGEMENT EXCEEDING 110 PERCENT NOT PROPOSED

1968 BUILDING CODE COMPLIANCE

PROPOSED WORK IS DESIGNED IN COMPLIANCE WITH THE FOLLOWING SECTIONS OF THE 1968 BC: SUBCHAPTER 3 - OCCUPANCY AND CONSTRUCTION CLASSIFICATION §[C26-301.2] 27-238 CLASSIFICATION OF SPACES: OCCUPANCY GROUP "G" FIRE INDEX 1 (LIBRARY) NO CHANGE PROPOSED

§[C26-301.3] 27-239 CLASSIFICATION OF BUILDING: OCCUPANCY GROUP "G" FIRE INDEX 1 (LIBRARY) NO CHANGE PROPOSED

§[C26-313.2] 27-270 CLASSIFICATION OF BUILDINGS AND SPACES: CONSTRUCTION CLASS 1-C - (2-

NO CHANGE TO CONSTRUCTION CLASSIFICATION PROPOSED SUBCHAPTER 4 - BUILDING LIMITATIONS

SUBARTICLE 2: FACILITIES FOR PEOPLE HAVING DISABILITIES: ALTERATIONS TO COMPLY WITH CHAPTER 11 OF 2022 BUILDING CODE **§IC26-407.11 27-307 PERMISSIBLE PROJECTIONS BEYOND THE STREET LINE**

ENCROACHMENTS ONTO THE PUBLIC RIGHT OF WAY TO BE GOVERNED BY CHAPTER 32 OF 2022 §[C26-408.1] 27-313 PROJECTIONS ABOVE GRADE

ENCROACHMENTS ONTO THE PUBLIC RIGHT OF WAY TO BE GOVERNED BY CHAPTER 32 OF 2022 BUILDING CODE. §[C26-408.2] 27-314 PROJECTIONS BELOW GRADE

ENCROACHMENTS ONTO THE PUBLIC RIGHT OF WAY TO BE GOVERNED BY CHAPTER 32 OF 2022

SUBCHAPTER 5 - FIRE PROTECTION CONSTRUCTION REQUIREMENTS ALTERATIONS TO COMPLY WITH SUBCHAPTER 5 EXCEPT AS NOTED BELOW ARTICLE 4 - PREVENTION OF EXTERIOR FIRE SPREAD ALTERATIONS TO COMPLY WITH ARTICLE 4 EXCEPT AS NOTED BELOW

§[C26-503.4] 27-334 PROTECTIVE GUARDS ALTERATIONS TO COMPLY WITH SECTIONS 1015 AND 1607.8 OF 2022 BUILDING CODE

SUBCHAPTER 6 - MEANS OF EGRESS NO CHANGE PROPOSED

SUBCHAPTER 7 - SPECIAL USES AND OCCUPANCIES NOT APPLICABLE

SUBCHAPTER 8 - PLACES OF ASSEMBLY NO CHANGE PROPOSED

SUBCHAPTER 9 - LOADS NO CHANGE PROPOSED

SUBCHAPTER 10 - STRUCTURAL WORK NO CHANGE PROPOSED

SUBCHAPTER 11 - FOUNDATIONS NO CHANGE PROPOSED

SUBCHAPTER 12 - LIGHT, HEAT, VENTILATION, AND NOISE CONTROL §[C26-1201.1] 27-731 ALTERATIONS ALTERATIONS TO COMPLY WITH §[C26-1201.1] 27-731

SUBCHAPTER 13 - MECHANICAL VENTILATION, AIR CONDITIONING, AND REFRIGERATION SYSTEMS

SUBCHAPTER 14 - HEATING AND COMBUSTION EQUIPMENT

NO CHANGE PROPOSED **SUBCHAPTER 15 - CHIMNEYS AND GAS VENTS**

NO CHANGE PROPOSED SUBCHAPTER 16 - PLUMBING AND GAS PIPING

NO CHANGE PROPOSED

SUBCHAPTER 17 - FIRE ALARM, DETECTION AND EXTINGUISHING EQUIPMENT NO CHANGE PROPOSED

SUBCHAPTER 18 - ELEVATORS AND CONVEYORS NO CHANGE PROPOSED

SUBCHAPTER 19 - SAFETY OF PUBLIC AND PROPERTY DURING CONSTRUCTION OPERATIONS REQUIRED SAFETY OF PUBLIC AND PROPERTY DURING CONSTRUCTION OPERATIONS TO COMPLY WITH CHAPTER 33 OF 2022 BUILDING CODE

2022 BUILDING CODE COMPLIANCE

PROPOSED WORK IS DESIGNED IN COMPLIANCE WITH THE FOLLOWING SECTIONS OF THE 2022 BC, AS REQUIRED FOR PRIOR CODE BUILDINGS: **CHAPTER 9 - FIRE PROTECTION SYSTEMS**

901.9.1 SPECIAL PROVISIONS FOR PRIOR CODE BUILDINGS: THE PROVISIONS OF THIS CHAPTER SHALL APPLY TO ALTERATIONS AND CHANGES OF USE OR OCCUPANCY TO PRIOR CODE BUILDINGS IN ACCORDANCE WITH SECTIONS 901.9.1 THROUGH 901.9.6.

PROTECTION FILINGS

CHAPTER 10 - MEANS OF EGRESS 1015.1 GUARDS SHALL COMPLY WITH THE PROVISIONS OF SECTIONS 1015.2 THROUGH 1015.7 INSTALLATION OF NEW OR ALTERATIONS TO GUARDS TO COMPLY WITH SECTION BC 1015

ALTERATIONS TO COMPLY WITH CHAPTER 9, REFER TO RELATED FIRE ALARM AND FIRE

CHAPTER 11 - ACCESSIBILITY

1101.3 SPECIAL PROVISIONS FOR PRIOR CODE BUILDINGS: THE PROVISIONS OF THIS CHAPTER SHALL APPLY TO ALTERATIONS, INCLUDING MINOR ALTERATIONS BUT EXCLUDING ORDINARY REPAIRS, AND CHANGES OF USE OR OCCUPANCY TO PRIOR CODE BUILDINGS, PORTIONS OF SUCH BUILDINGS, AND SPACES WITHIN SUCH BUILDINGS IN ACCORDANCE WITH SECTIONS1101.3.1 THROUGH 1101.3.5. ALTERATIONS WITHIN PRIOR CODE BUILDINGS AFFECTING AN AREA CONTAINING A PRIMARY FUNCTION SHALL COMPLY WITH THE REQUIREMENTS OF SECTION 1101.4. THIS SECTION SHALL NOT IMPOSE A REQUIREMENT FOR GREATER ACCESSIBILITY THAN THAT WHICH WOULD BE REQUIRED FOR NEW CONSTRUCTION, NOR SHALL IT REDUCE OR HAVE THE EFFECT OF REDUCING ACCESSIBILITY. ALTERATIONS TO COMPLY WITH CHAPTER 11

CHAPTER 33 - SAFEGUARDS DURING CONSTRUCTION OR DEMOLITION

3301.1 SCOPE. THE PROVISIONS OF THIS CHAPTER SHALL GOVERN THE CONDUCT OF ALL CONSTRUCTION OR DEMOLITION OPERATIONS WITH REGARD TO THE SAFETY OF THE PUBLIC AND PROPERTY. FOR REGULATIONS RELATING TO THE SAFETY OF PERSONS EMPLOYED IN CONSTRUCTION OR DEMOLITION OPERATIONS. OSHA STANDARDS SHALL APPLY.

PROJECT TO COMPLY WITH CHAPTER 33 AND WITH ALL APPLICABLE CODES, LOCAL LAWS, AND GOVERNING REGULATIONS AS NOTED ON PLANS. APPLICATIONS RELATED TO SAFEGUARDS REQUIRED DURING CONSTRUCTION OR DEMOLITION,

SUCH AS FOR A SIDEWALK SHED PERMIT, TO BE FILED BY THE CONTRACTOR AT A LATER DATE.

LOCAL LAW 92/94 NOTE:

COMPLIANCE WITH BB 2019-10, AND LOCAL LAWS 92 AND 94 OF 2019, IS NOT REQUIRED FOR THIS PROJECT. AS PER BUILDINGS BULLETIN 2019-010, LOCAL LAWS 92 AND 94 OF 2019 ARE APPLICABLE TO (SEE SECTION I OF THE BULLETIN -APPLICABILITY); NEW BUILDINGS, NEW ROOFS RESULTING FROM ENLARGEMENT OF EXISTING BUILDINGS. AND EXISTING BUILDINGS REPLACING AN ENTIRE EXISTING ROOF DECK OR ROOF ASSEMBLY TO BE PROVIDED WITH A SUSTAINABLE ROOFING ZONE.



515 Broadway, Albany, New York, 12207-2964 One Penn Plaza, 52 Floor, NY, NY 10119-0098 539 Franklin Street, Buffalo, NY 14202-1109 WWW.DASNY.ORG


IESE DOCUMENTS CONTAIN POTENTIALLY SENSITIVE INFORMATION AND SHALL BE

ED FOR THEIR INTENDED PURPOSE. ONCE THE INTENDED PURPOSE HAS CEASED, THE DOCUMENTS SHALL BE DESTROYED IN A SECURE MANNER. IT IS A VIOLATION OF STATE EDUCATION LAW FOR ANY PERSON, UNLESS UNDER TH DIRECTION OF A LICENSED ARCHITECT / ENGINEER TO ALTER THIS DOCUMENT IN ANY WAY, ALTERATIONS MUST HAVE THE SEAL AFFIXED ALONG WITH A DESCRIPTION OF THE ALTERATIONS, DATE AND ARCHITECT'S / ENGINEER'S SIGNATURE. COPYRIGH Consultants CURTIS + GINSBERG

ARCHITECTS Curtis + ONE BATTERY PARK PLAZA, Ginsberg FL 27 Architects NEW YORK, NEW YORK 10004

Merritt Engineering 28-08 Bayside Lane, Queens, NY 11358

The LiRo Group 235 East Jericho Turnpike, Mineola, NY 11501

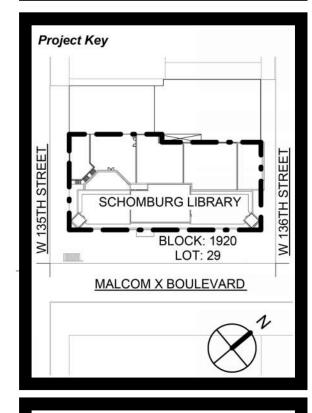

REVISIONS		
Rev No	Description	Date:
1		
2		
3		
4		
<u></u> <u>5</u>		
<u>6</u>		
<u> </u>		
<u>8</u>		
<u> </u>		

Public Library 476 FIFTH AVENUE NEW YORK, NY 10018 NYPL SCHOMBURG ENVELOPE RESTORATION 515 MALCOLM X BLVD

Drawing Title BUILDING **INFORMATION**

NEW YORK, NY 10037

90% CD SUBMISSION Drawn By: | Checked By: | Date: Seal & Signature:

DASNY Project No

DOB JOB #: M01133253-I1

2020 NYC ENERGY CONSERVATION CODE COMPLIANCE NOTE

<u>PROFESSIONAL STATEMENT:</u>
TO THE BEST OF MY KNOWLEDGE, BELIEF, AND PROFESSIONAL JUDGEMENT, THESE PLANS AND SPECIFICATIONS ARE IN COMPLIANCE WITH THE 2020 ENERGY CONSERVATION CODE OF NYC.

C301.1 - NYC - CLIMATE ZONE 4A - CHAPTER R4 & R5.

C401.2 COMPLIANCE. PROJECTS SHALL COMPLY WITH ONE OF THE FOLLOWING:

2. PRESCRIPTIVE COMPLIANCE PATH. C402 THROUGH C405, C406 & C408.

3. PERFORMANCE COMPLIANCE PATH C407.

C503.1 - "ALTERATIONS TO ANY BUILDING OR STRUCTURE SHALL COMPLY WITH THE REQUIREMENTS OF THE CODE FOR NEW CONSTRUCTION. ALTERATIONS SHALL BE SUCH THAT THE EXISTING BUILDING OR STRUCTURE IS NO LESS CONFORMING TO THE PROVISIONS OF THIS CODE THAN THE EXISTING BUILDING OR STRUCTURE WAS PRIOR TO THE ALTERATION. ALTERATIONS TO AN EXISTING BUILDING, BUILDING SYSTEM OR PORTION THEREOF SHALL CONFORM TO THE PROVISIONS OF THIS CODE AS THOSE PROVISIONS RELATE TO NEW CONSTRUCTION WITHOUT REQUIRING THE UNALTERED PORTIONS OF THE EXISTING BUILDING OR BUILDING SYSTEM TO COMPLY WITH THIS CODE. ALTERATIONS SHALL NOT CREATE AN UNSAFE OR HAZARDOUS CONDITION OR OVERLOAD EXISTING BUILDING SYSTEMS."

EXCEPTION 4: CONSTRUCTION WHERE ROOF, WALL OR FLOOR CAVITY IS NOT EXPOSED.

THIS PROJECT DOES NOT AFFECT THE WALL CAVITY AND MEANT TO RESTORE EXISTING FACADES TO COMPLY WITH FACADE SAFETY INSPECTION PROGRAM.

WALL CAVITY IS CONSIDERED THE CAVITY WITHIN EXTERIOR CMU BACKUP WALL AND NOT AN AIR CAVITY BETWEEN BACK UP CMU AND MASONRY BRICK.

SECTION C504 REPAIRS


BUILDINGS AND STRUCTURES, AND PARTS THEREOF, SHALL BE REPAIRED IN COMPLIANCE WITH SECTION C501.3 AND THIS SECTION. WORK ON NONDAMAGED COMPONENTS THAT IS NECESSARY FOR THE REQUIRED REPAIR OF DAMAGED COMPONENTS SHALL BE CONSIDERED TO BE PART OF THE REPAIR AND SHALL NOT BE SUBJECT TO THE REQUIREMENTS FOR ALTERATIONS IN THIS


REPAIRS AND RESTORATION WORK TO COMPLY WITH CHAPTER C5 EXISTING BUILDINGS

2020 NYC ENERGY CONSERVATION CODE COMPLIANCE SUMMARY


PROFESSIONAL STATEMENT:
TO THE BEST OF MY KNOWLEDGE, BELIEF, AND PROFESSIONAL JUDGEMENT, THESE PLANS AND SPECIFICATIONS, AS THEY RELATE TO THE FIRST FLOOR ADDITION ONLY, ARE IN COMPLIANCE WITH THE 2020 ENERGY CONSERVATION CODE OF NYC.

NYCECC CITATION	PROVISION	ITEM DESCRIPTION	CODE PRESCRIPTIVE VALUE (ECC)	PROPOSED DESIGN VALUE	SUPPORTING DOCUMENTATION
C402.1.3, TABLE C402.1.3	INSULATION ENTIRELY ABOVE ROOF DECK	REPLACEMENT OF EXISTING ROOFING.	R-30ci	R-30ci MINIMUM	A-330 (ROOF DETAILS)
C402.4, TABLE C402.4	FENESTRATION (PRESCRIPTIVE)	WINDOW, CURTAINWALL, AND ENTRY DOOR REPLACEMENTS	WINDOW U-FACTOR BELOW 95 FEET METAL FRAMING FIXED Umax-0.30, SHGCmax-0.36 METAL FRAMING OPERABLE Umax-0.40, SHGCmax-0.36 ENTRANCE DOORS Umax-0.77, SHGCmax-0.36	PROPOSED FENESTRATION U- FACTORS AND SOLAR HEAT GAIN COEFFICIENTS ARE NOT GREATER THAN THE MAXIMUMS SPECIFIED IN TABLE C402.4.	A-320 (WINDOW LEGEND AND SCHEDULE)
C402.5.2, TABLE C402.5.2	AIR LEAKAGE OF FENESTRATION	WINDOW, CURTAINWALL, AND ENTRY DOOR REPLACEMENTS	WINDOWS 0.20 CFM/FT ² SWINGING DOORS 0.20 CFM/FT ² SKYLIGHTS (WITH CONDENSATION WEEPAGE OPENINGS) 0.30 CFM/FT ² SKYLIGHTS (ALL OTHER) 0.20 CFM/FT ² STOREFRONT GLAZING 0.06 CFM/FT ² COMMERCIAL GLAZED SWINGING ENTRANCE DOORS 1.00 CFM/FT ²	PROPOSED AIR LEAKAGE OF FENESTRATION IS NOT GREATER THAN THE MAXIMUMS SPECIFIED IN TABLE C402.5.2.	A-320 (WINDOW LEGEND AND SCHEDULE)
C402.5.7	VESTIBULES	REPLACEMENT OF EXISTING LOBBY VESTIBULE AT FIRST FLOOR.	VESTIBULE PROVIDED AT DOOR SEPARATING CONDITIONED SPACE FROM THE EXTERIOR.	VESTIBULE PROVIDED AT EXTERIOR ENTRANCE DOORS SEPARATING CONDITIONED SPACE FROM THE EXTERIOR.	A-101 (PARTIAL LOWER FLOOR PLANS)

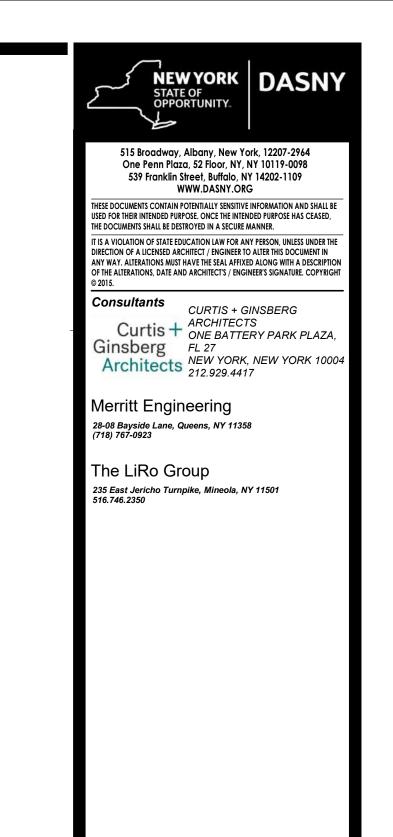

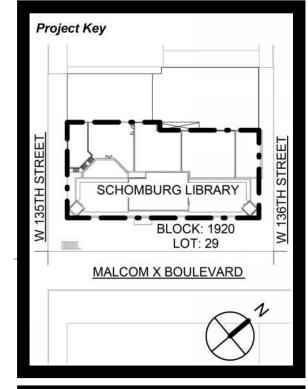


REVISIONS			
Rev No	Description	Date:	
1			
2			
3			
4			
<u>5</u>			
<u>6</u>			
<u> </u>			
8			
9			

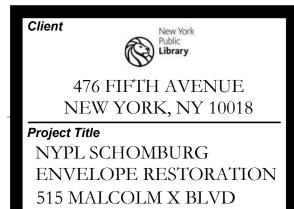

Drawing Title ENERGY CONSERVATION CODE COMPLIANCE

NEW YORK, NY 10037

90% CD SUBMISSION Drawn By: DC/RE DC/RE Date: 02/28/2025

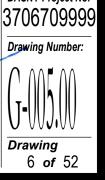

PERMITS & COMPLIANCE: ALL WORK SHALL CONFORM TO & BE PERFORMED IN STRICT

ACCORDANCE WITH THE CONTRACT DOCUMENTS, THE BUILDING & ELECTRICAL CODES OF THE CITY OF NEW YORK, & ALL OTHER REGULATIONS HAVING JURISDICTION. ALL REQUIRED PERMITS SHALL BE OBTAINED BY THE CONTRACTOR BEFORE COMMENCEMENT OF THE WORK. ALL ELECTRICAL, PLUMBING, & SPRINKLER WORK SHALL BE PERFORMED, RESPECTIVELY, BY LICENSED ELECTRICIANS, PLUMBERS, FIRE ALARM & FIRE SUPPRESSION PIPING CONTRACTORS.

SPECIAL INSPECTIONS: AFTER ISSUANCE OF WORK PERMIT, SPECIAL AND OTHER INSPECTIONS SHALL BE MADE IN ACCORDANCE WITH AN INSPECTION PROGRAM SET FORTH IN THE PERMIT APPLICATION. SPECIAL INSPECTION ITEMS REQUIRE 72 HOURS PRIOR WRITTEN NOTICE TO PERSONS RESPONSIBLE FOR INSPECTION. RECORDS OF INSPECTIONS SHALL BE KEPT BY INSPECTOR FOR AT LEAST 6 YRS. AND MADE AVAILABLE TO THE DEPT. UPON REQUEST. (SEC 28-116 ADMIN. CODE).

3. THE CONTRACT DOCUMENTS: CONSIST OF THE OWNER-CONTRACTOR AGREEMENT, THE CONDITIONS OF THE CONTRACT, THE DRAWINGS, THE SPECIFICATIONS, & ALL ISSUED MODIFICATIONS. IN CASE OF DISCREPANCIES BETWEEN THE CONTRACT DOCUMENTS, THE CONTRACTOR SHALL OBTAIN INSTRUCTIONS FROM THE ARCHITECT BEFORE PROCEEDING WITH

PROTECTION OF SITE: CONTRACTOR SHALL PROTECT EXISTING & NEIGHBORING BUILDINGS AS REQUIRED DURING CONSTRUCTION AND DO ALL SHORING & BRACING AS REQUIRED FOR PROPER AND SAFE EXECUTION OF THE WORK. ANY DAMAGE TO THE BUILDING & ADJACENT PROPERTIES CAUSED DURING CONSTRUCTION SHALL BE REPAIRED TO MATCH EXISTING CONDITIONS. ALL EXISTING TREES ON ADJACENT PROPERTIES SHALL BE PROTECTED FROM DAMAGE DURING COURSE OF WORK.

CONDITIONS AFFECTING THE WORK: BEFORE PROCEEDING WITH THE WORK, THE CONTRACTOR & SUBCONTRACTORS SHALL THOROUGHLY EXAMINE CONDITIONS AT THE PROJECT SITE TO ASSURE THAT THE WORK CAN PROCEED ACCORDING TO THE CONTRACT DOCUMENTS. CONDITIONS FOUND WHICH WILL ADVERSELY AFFECT THE WORK SHALL BE REVIEWED WITH THE ARCHITECT BEFORE PROCEEDING WITH THE AFFECTED WORK.

NOTIFICATION OF ADJACENT PROPERTY OWNERS: TEN DAYS PRIOR NOTICE SHALL BE GIVEN TO THE OWNER OF EACH ADJOINING LOT AS PER SEC. 105.5, 2113.1.6.3 AND 3304.3.2 OF THE NYC BUILDING CODE AS WELL AS TITLE 1, CH. 28 OF THE ADMIN. CODE.

COMMENCEMENT OF OPERATIONS: AT LEAST 24 HOURS, BUT NO MORE THAN 48 HOURS WRITTEN NOTICE SHALL BE GIVEN TO THE COMMISSIONER OF BUILDINGS BEFORE COMMENCING OF FOUNDATION AND EARTHWORK (B.C. SEC. 105.5). AT LEAST 48 HOURS WRITTEN NOTICE SHALL BE GIVEN TO THE DEPT. PRIOR TO COMMENCING DEMOLITION WORK (B.C. 105.6).

ELEVATION DATUM: SITE ELEVATIONS SHOWN REFER TO DATUM INDICATED ON THE SURVEY; SEE DRAWINGS LIST FOR SURVEY REFERENCE.

REFERENCE DATUM: ELEVATIONS ON A-SERIES ELEVATIONS AND SECTIONS DRAWINGS REFER TO MANHATTAN HIGHWAY DATUM.

10. <u>SURVEY AND BORINGS</u>: SURVEY AND SUB-SURFACE TEST BORINGS ARE PROVIDED FOR INFORMATION ONLY. CURTIS + GINSBERG ARCHITECTS LLP AND SUBCONSULTANTS ARE NOT RESPONSIBLE FOR THE ACCURACY OR COMPLETENESS OF INFORMATION CONTAINED IN THE SURVEY OR TEST BORINGS PREPARED BY OTHERS.

. DIMENSIONS: ALL DIMENSIONS ARE DRAWN TO FACE OF FINISH WALL, UNLESS OTHERWISE NOTED IN THE DRAWINGS. WRITTEN DIMENSIONS SHALL GOVERN OVER SCALED DIMENSIONS. WHEN A DETAIL, DIMENSION, OR REFERENCE IS INDICATED AS "TYPICAL," IT APPLIES TO ALL SIMILAR SITUATIONS, WHETHER OR NOT INDICATED. MANEUVERING CLEARANCE SHALL BE MEASURED BETWEEN BASE MOLDINGS.

12. CORNER CLEARANCE: THE DISTANCE FROM ANY DOOR OPENING TO ADJACENT PARTITIONS SHALL NOT BE LESS THAN 2", UNLESS OTHERWISE NOTED IN THE DRAWINGS.

13. MEANS AND METHODS: THE ARCHITECT SHALL NOT HAVE CONTROL OR CHARGE & SHALL NOT BE RESPONSIBLE FOR THE MEANS, METHODS, TECHNIQUES, SEQUENCES, OR PROCEDURES OF CONSTRUCTION, FABRICATION, PROCUREMENT, SHIPMENT, DELIVERY, OR INSTALLATION, OR FOR SAFETY PRECAUTIONS AND PROGRAMS IN CONNECTION WITH THE WORK, FOR THE ACTS OR OMISSIONS OF THE CONTRACTORS, SUBCONTRACTORS, SUPPLIERS, OR ANY OTHER PERSONS PERFORMING ANY OF THE WORK, OR FOR THE FAILURE OF ANY OF THEM TO CARRY OUT THE WORK IN THE CONTRACT DOCUMENTS.

14. <u>COORDINATION</u>: BEFORE PROCEEDING WITH THE WORK, THE CONTRACTOR & SUBCONTRACTORS SHALL COORDINATE THE SEQUENCING & INSTALLATION OF THE WORK COVERED IN THE CONTRACT DOCUMENTS.

15. MATERIALS: MATERIALS, ASSEMBLIES, EQUIPMENT, METHODS OF CONSTRUCTION, & SERVICE EQUIPMENT SHALL MEET THE APPROVAL OF THE COMMISSIONER, IN ALL INSTANCES, AS PER ARTICLE 113 OF THE ADMIN. CODE.

16. FACILITIES AND SERVICES: THE WORK & OPERATIONS OF DEMOLITION & CONSTRUCTION SHALL COMMENCE ONLY AFTER ALL REQUIRED TEMPORARY PROTECTION & SERVICES ARE IN PLACE. EXISTING FACILITIES & SERVICES SHALL BE DISCONNECTED AND/OR REMOVED FOR THE PURPOSES OF CONSTRUCTION OR DEMOLITION ONLY AFTER THEY ARE REPLACED BY TEMPORARY OR PERMANENT NEW FACILITIES & SERVICES.

7. RODENT PROOFING: APPENDIX F OF THE NYC BUILDING CODE SHALL APPLY TO ALL RODENT PROOFING REQUIREMENTS FOR CONSTRUCTION.

18. RATED ASSEMBLIES: ALL MATERIALS OR ASSEMBLIES REQUIRED TO HAVE A FIRE RESISTANCE RATING SHALL COMPLY WITH THE APPROPRIATE NEW YORK CITY BUILDING CODE STANDARDS.

19. MASONRY UNITS: ALL MASONRY UNITS AND CONSTRUCTION ASSEMBLIES SHALL COMPLY WITH THE APPROPRIATE NEW YORK CITY BUILDING CODE STANDARDS.

20. FLAME-SPREAD & SMOKE DENSITY FOR NEW CONSTRUCTION:

A) FLAME-SPREAD RATING TO COMPLY WITH 603 AND CH. 8 OF THE NEW YORK CITY BUILDING

B) SMOKE DEVELOPED INDEX SHALL COMPLY WITH CH. 8 OF THE NEW YORK CITY BUILDING

C) SMOKE DENSITY: NO MATERIAL SHALL BE USED FOR INTERIOR FINISH FOR EXITS OR CORRIDORS THAT HAS A SMOKE DENSITY RATING GREATER THAN 25, AS PER 603 AND 803.1.1 OF THE NEW YORK CITY BUILDING CODE.

21. <u>FIRESTOPPING - GENERAL</u>: CONCEALED SPACES WITH PARTITIONS, WALLS, FLOORS, ROOFS STAIRS, FURRING, PIPE SPACES, COLUMN ENCLOSURES, ETC. SHALL BE FIRESTOPPED (EXCEPT WHERE CONCEALED SPACE IS SPRINKLERED) WITH NON-COMBUSTIBLE MATERIAL THAT CAN BE SHAPED, FITTED, & PERMANENTLY SECURED IN POSITION AS PER 717 OF THE NEW YORK CITY BUILDING CODE, AND WHICH HAS BEEN TESTED IN ACCORDANCE WITH ASTM E 814 CRITERIA.

22. FIRESTOPPING - FURRING OF INTERIOR FINISHES: PER SEC. 803.4 OF THE NYC BUILDING CODE, ANY INTERIOR FINISH APPLIED TO A RATED ASSEMBLY/WALL SHALL BE DIRECTLY ATTACHED OR BY FURRING STRIPS NOT EXCEEDING 0.75 IN. APPLIED DIRECTLY AGAINST SUCH SURFACES. INTERVENING SPACES BETWEEN STRIPS SHALL BE FILLED WITH INORGANIC OR CLASS A MATERIAL OR BE FIREBLOCKED AT A MAX. OF 8 FT. IN ANY DIRECTION.

23. FIRESTOPPING - DUCTS, PIPES, & CONDUITS: DUCTS, PIPES, & CONDUITS PASSING THOUGH FIRE RATED CONSTRUCTION SHALL HAVE SURROUNDING SPACES NOT EXCEEDING 1/2" IN WIDTH FILLED WITH FIRESTOPPING MATERIAL APPROVED BY THE CODE & CLOSED OFF WITH CLOSE-FITTING METAL CLOSURES. REFER TO DEFINITION OF CONCEALED SPACES IN BC 702.1. DUCTWORK PENETRATIONS SHALL ALSO BE PROTECTED BY RATED SELF CLOSING DEVICES, PER 716 OF THE NEW YORK CITY BUILDING CODE.

24. ELEVATORS: SHALL BE FILED AS SEPARATE NYC BLDG. DEPT. APPLICATION. ELEVATORS SHALL COMPLY WITH ALL APPLICABLE ACCESSIBILITY REGULATIONS AS WELL AS APPENDIX K OF THE NYC BUILDING CODE. ELEVATORS AND ACCESSORIES SHALL COMPLY WITH THE REQUIREMENTS FOR THE FIREMEN'S RECALL SYSTEM. SIGNAGE SHALL COMPLY WITH CH. 10 & CH. 11 OF THE NYC BUILDING CODE. PROVIDE MIRRORS IN ELEVATOR CAB.

25. WASTE DISPOSAL: THE CONTRACTOR SHALL BE RESPONSIBLE FOR THE REMOVAL OF ALL CONSTRUCTION DEBRIS & SHIPPING CARTONS FROM THE PREMISES, INCLUDING THOSE OF OTHER CONTRACTORS.

CLEANING: THE SITE IS TO BE KEPT BROOM SWEPT AT THE END OF EACH DAY. WHEN WORK IS COMPLETE IN A GIVEN AREA. CLEAN ALL SURFACES AS REQUIRED, GIVEN THE NATURE OF FINISH. TO BE FREE OF DUST, STAINS, FILMS, & OTHER FOREIGN SUBSTANCES. IN ADDITION, REMOVE ALL DEBRIS, PACKING MATERIAL, & CONTRACTOR'S EQUIPMENT.

27. NOISE CONTROL: THE WORK SHALL COMPLY WITH REQUIREMENTS FOR MC-926 AND INTERIOR

ENVIRONMENT CHAPTER 12 AND ADDITIONALLY CHAPTER 30 OF NYC BUILDING: A) AIR BORNE NOISE: WALLS, PARTITIONS, FLOOR-CEILING CONST. SEPARATING DWELLING

UNITS - STC 50 IF LAB. TESTED BY ASTM E 90 OR NOT LESS THAN 45 IF FIELD TESTED WITH ASTM E 336. DWELLING UNIT ENTRANCE DOORS - STC 35. B) STRUCTURE BORNE NOISE: FLOOR-CEILING CONST. SEPARATING DWELLING UNITS SHALL

HAVE AN IMPACT INSULATION CLASS(IIC) RATING OF NOT LESS THAN 50 IF LAB. TESTED WITH ASTM E492 OR 45 IF FIELD TESTED WITH ASTM E 1007. C) EQUIPMENT/MACHINE RM.: SHALL COMPLY WITH SEC. 1207.2.1 & TABLE 1207.2.1 OF NYC

BUILDING CODE.

28. INSTALLATION: THE CONTRACTOR SHALL PROVIDE COMPLETE INSTALLATION IN CONFORMANCE WITH THE DESIGN INTENT OF THE DRAWINGS & SPECIFICATIONS, WHICH INCLUDES ALL REQUIRED FASTENERS, HARDWARE, & ACCESSORIES. THESE ITEMS SHALL BE PROVIDED EVEN IF THEY ARE NOT SPECIFICALLY MENTIONED IN THE CONTRACT DOCUMENTS. ANY OF THE ABOVE ITEMS IN PLAIN VIEW SHALL BE APPROVED BY THE ARCHITECT BEFORE INSTALLATION.

29. <u>SCHEDULED MATERIALS, FIXTURES, & EQUIPMENT</u>: ALL MATERIALS, FIXTURES, & EQUIPMENT SHALL BE INSTALLED IN ACCORDANCE WITH THE MANUFACTURER'S REQUIREMENTS, UNLESS OTHERWISE NOTED IN THE DRAWINGS & SPECIFICATIONS.

A) FOR NOTES REFERRING TO LIVE AND DEAD LOADS, STRUCTURAL WORK AND FOUNDATIONS, REFER TO STRUCTURAL DRAWINGS.

B) MINIMUM CLEAR STORY HEIGHT, FINISHED FLOOR TO FINISHED CEILING IN APARTMENTS SHALL BE 8'-0".

C) STRUCTURAL PLANS WILL BE FILED SHOWING ALL FOOTINGS, FOUNDATIONS, WALLS, SLABS, REINFORCING, ETC.

31. <u>FINISHES</u>: INTERIOR FINISHES & MATERIALS FOR FLOORS, BASE, WALLS, & CEILING ARE INDICATED BY ROOM ON THE FINISH SCHEDULE. THE CONTRACTOR SHALL PROVIDE SCHEDULED FINISHES FOR EACH ROOM & SPACE IN ACCORDANCE WITH THE CONTRACT DOCUMENTS.

32. DOORS, FRAMES, & HARDWARE: DOORS, FRAMES, & HARDWARE ARE INDICATED ON THE DOOR SCHEDULE. THE CONTRACTOR SHALL PROVIDE SCHEDULED DOOR(S), FRAME(S), & HARDWARE FOR EACH DOOR OPENING ACCORDING TO THE CONTRACT DOCUMENTS.

33. MECHANICAL VENTILATION: MECHANICAL VENTILATION SHALL COMPLY WITH CHAPTER 12 OF THE NEW YORK CITY BUILDING CODE.

34. <u>SIGNAGE</u>: SIGNS SHALL BE POSTED WHERE APPLICABLE AT ALL BUILDING, ROOM & DWELLING UNIT ENTRANCES AND ALL EXITS, STAIRS(1019), RAMPS TO COMPLY WITH CHAPTERS 10 & 11 OF THE NYC BLDG. CODE.

35. WORK BEYOND STREET LINE: NO WORK SHALL BE PERFORMED BEYOND THE STREET LINE PRIOR TO OBTAINING APPROVAL FROM THE DEPARTMENT OF HIGHWAYS. PERMITS FOR ALL WORK OUTSIDE THE STREET LINE SHALL BE OBTAINED BY THE CONTRACTOR. SIDEWALK & STREET CURBING SHALL BE REBUILT IN ACCORDANCE WITH THE REQUIREMENTS OF THE DEPARTMENT OF HIGHWAYS.

36. ACCESSIBILITY/ADAPTABILITY: BUILDING SHALL BE HCPD. ACCESSIBLE AND/OR ADAPTABLE PER CH. 11(1101) OF THE N.Y.C BUILDING CODE AND FAIR HOUSING ACT DESIGN MANUAL.

37. PAVING PLANS SHALL BE FILED WITH THE DEPARTMENT OF TRANSPORTATION PURSUANT TO SEC. 19-113 & 19-115 OF THE ADMIN. CODE.

39. FIRE HYDRANT: BUILDING ENTRANCE IS WITHIN 250 FEET OF FIRE HYDRANT.

40. NOTIFICATION WILL BE PROVIDED TO THE DOB 24 - 48 HOURS PRIOR TO COMMENCEMENT OF EARTHWORK.

HAZARDOUS MATERIAL NOTES

IN THE EVENT OF ASBESTOS OR OTHER TOXIC SUBSTANCE ARE FOUND DURING THE COURSE OF WORK, THE CONTRACTOR SHALL INFORM THE CLIENT WHO WILL HAVE THE DUTY TO INFORM THE ENVIRONMENTAL CONSULTANT, ARCHITECT AND/OR THE ENGINEER OF SUCH RISKS KNOWN OR REASONABLY KNOWABLE TO CLIENT.

REFER TO ENVIRONMENTAL REPORT AND SCOPE.

CONSTRUCTION PROTECTION PLAN

CONTRACTOR TO PROCURE A CONSTRUCTION PROTECTION PLAN TO ENSURE 103 WEST 135TH STREET AND 112 WEST 136TH STREET ARE NOT DAMAGED BY SCOPE OF WORK.


515 Broadway, Albany, New York, 12207-2964 One Penn Plaza, 52 Floor, NY, NY 10119-0098 539 Franklin Street, Buffalo, NY 14202-1109 WWW.DASNY.ORG

IESE DOCUMENTS CONTAIN POTENTIALLY SENSITIVE INFORMATION AND SHALL BE SED FOR THEIR INTENDED PURPOSE. ONCE THE INTENDED PURPOSE HAS CEASED, THE DOCUMENTS SHALL BE DESTROYED IN A SECURE MANNER. IT IS A VIOLATION OF STATE EDUCATION LAW FOR ANY PERSON, UNLESS UNDER THE DIRECTION OF A LICENSED ARCHITECT / ENGINEER TO ALTER THIS DOCUMENT IN ANY WAY, ALTERATIONS MUST HAVE THE SEAL AFFIXED ALONG WITH A DESCRIPTION OF THE ALTERATIONS, DATE AND ARCHITECT'S / ENGINEER'S SIGNATURE. COPYRIGH Consultants CURTIS + GINSBERG


Curtis + ARCHITECTS
ONE BATTERY PARK PLAZA, Ginsberg FL 27 Architects NEW YORK, NEW YORK 10004 212.929.4417


Merritt Engineering 28-08 Bayside Lane, Queens, NY 11358


The LiRo Group 235 East Jericho Turnpike, Mineola, NY 11501

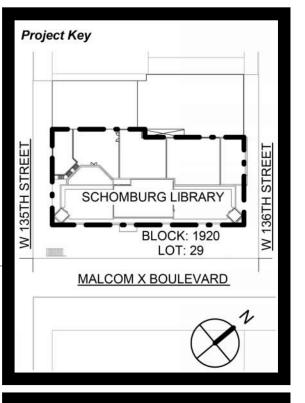

REVISIONS				
Rev No	Description	Date:		
<u> </u>				
2				
<u>3</u>				
4				
<u>5</u>				
<u>6</u>				
<u> </u>				
<u>8</u>				
9				

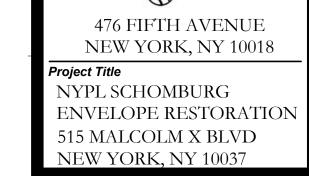

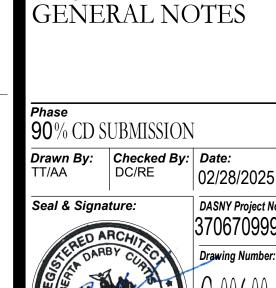

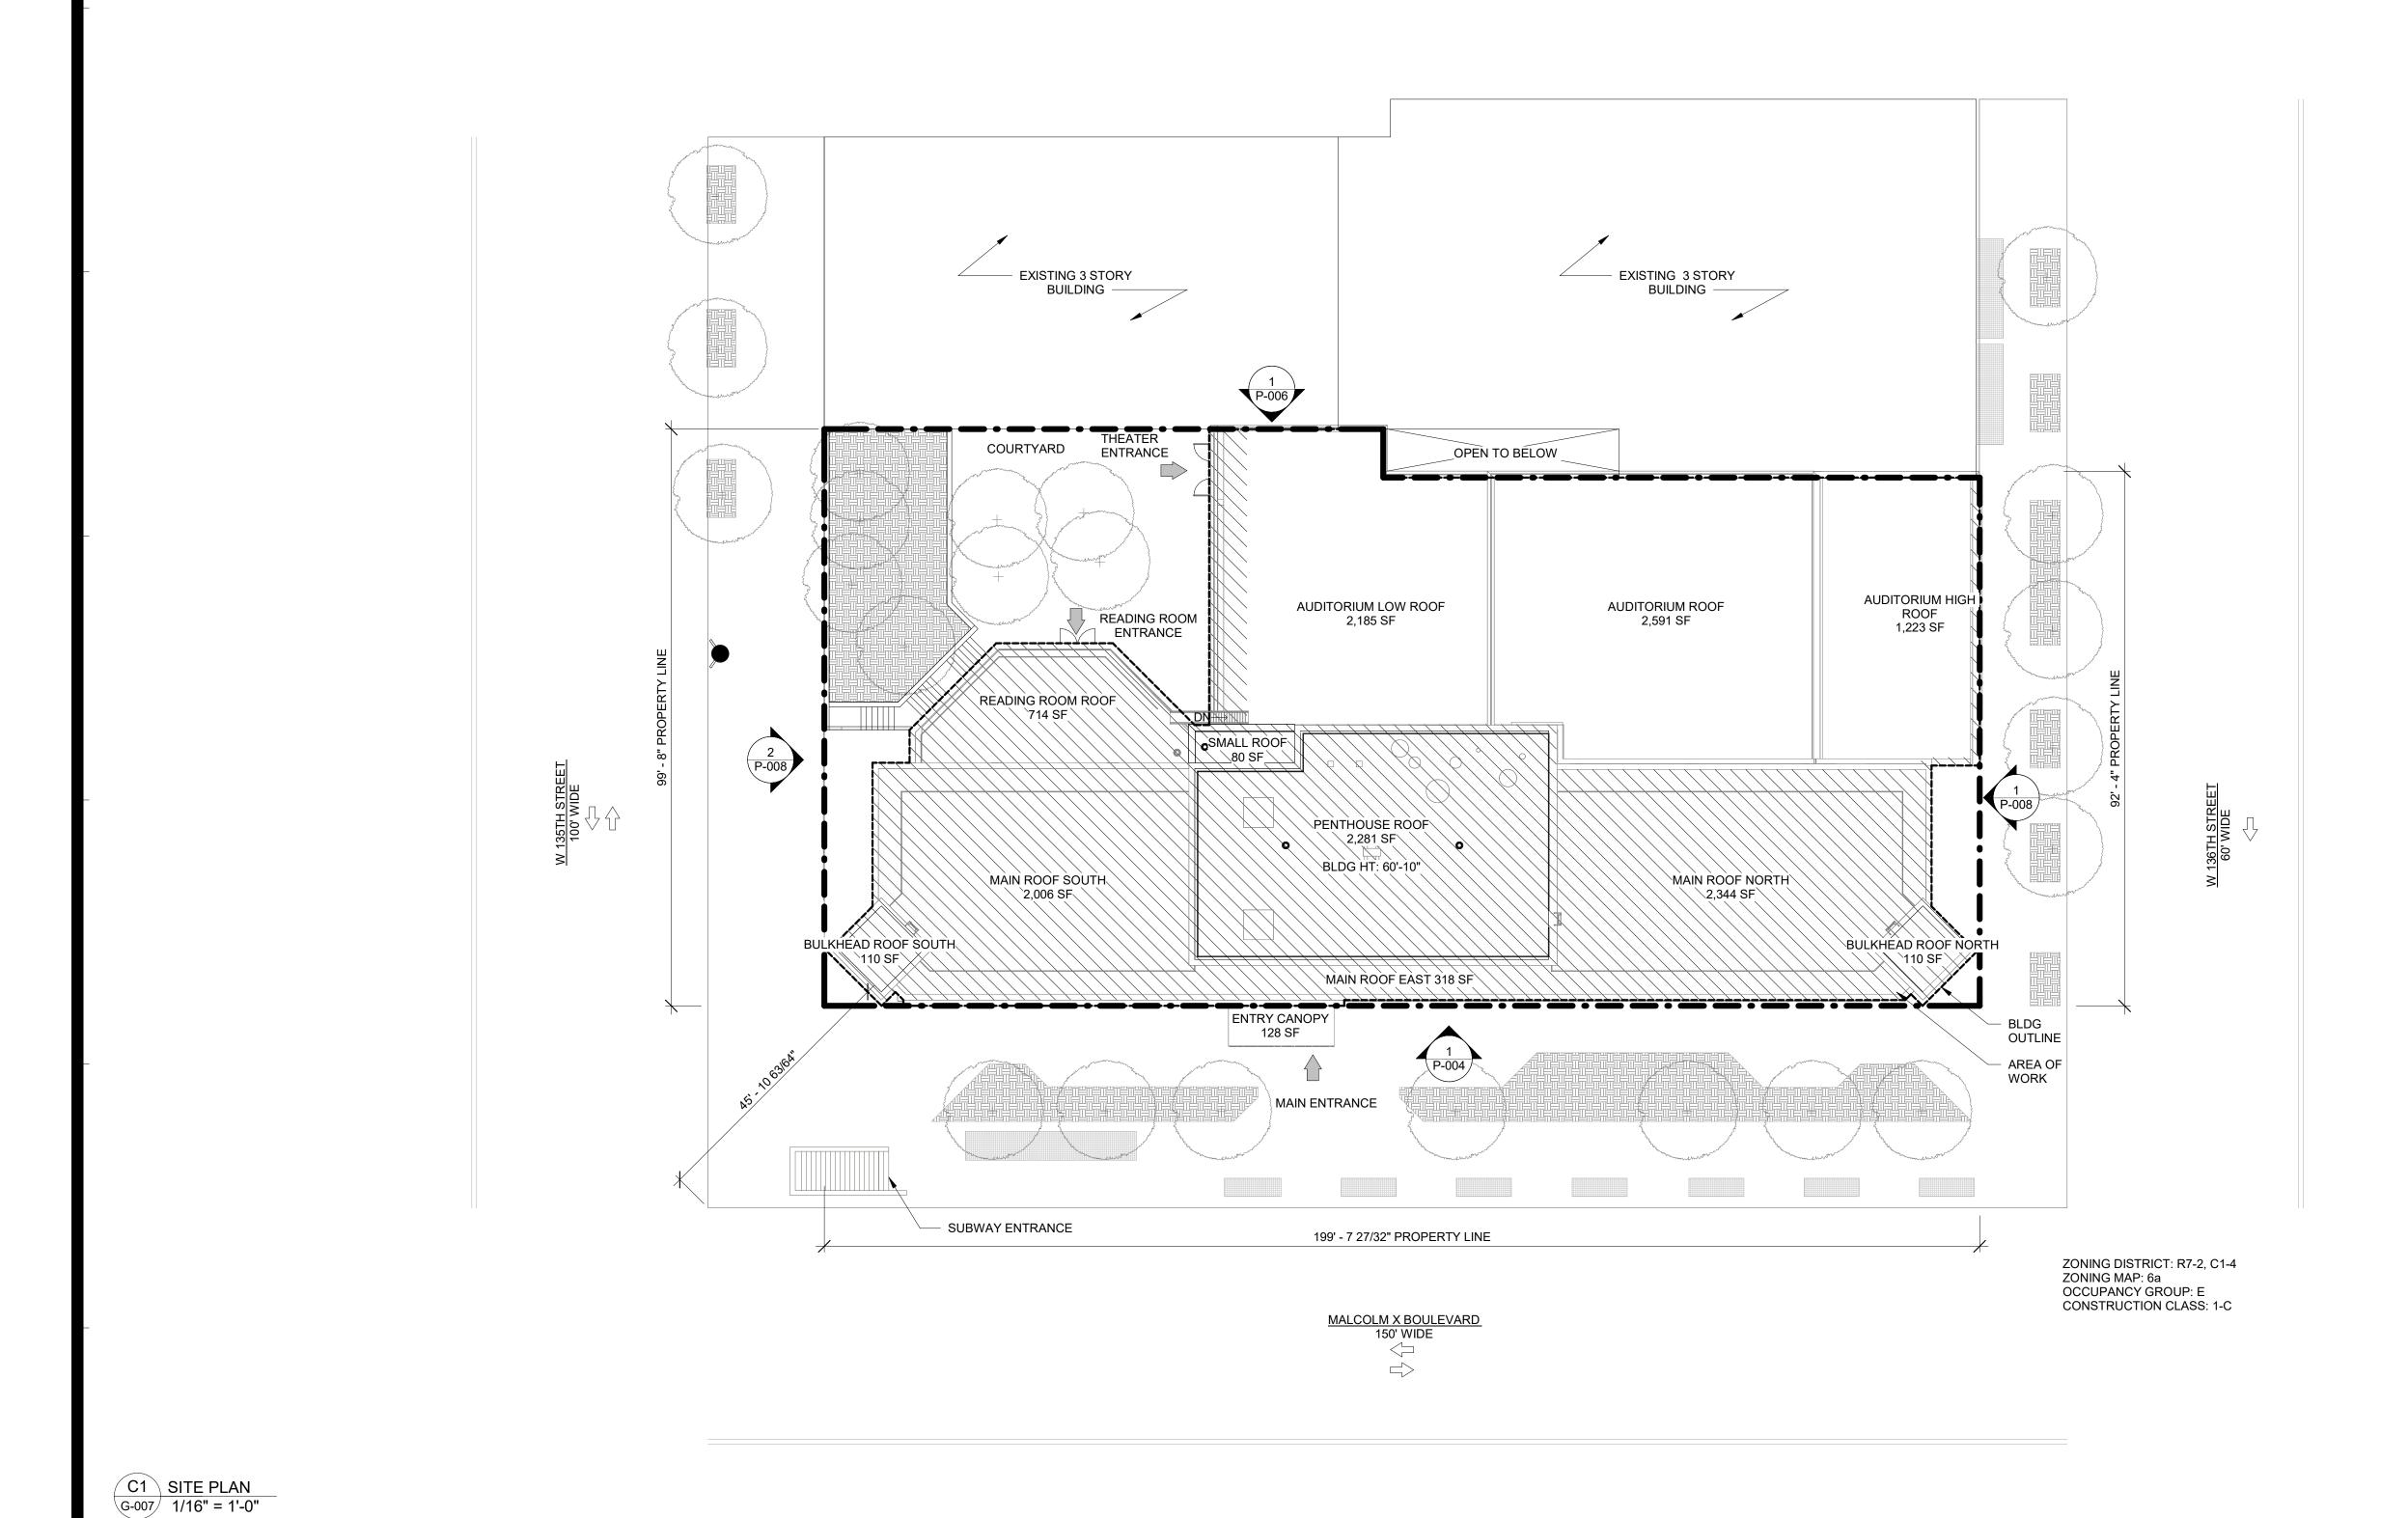

KEYNOTES:

TAGGED KEYNOTES ONLY APPLY WHERE INDICATED ON DRAWINGS

SITE PLAN NOTES:


3. SEE SHEET V-001 AND V-002 FOR FLOOD ZONE MAP.


5. RIGHTS-OF-WAY AND EASEMENTS - NONE

7. ELEVATIONS REFER TO NAVD 1988 DATUM.


4. LANDMARK OR HISTORIC DISTRICT DESIGNATION - NO


REQUIRED.

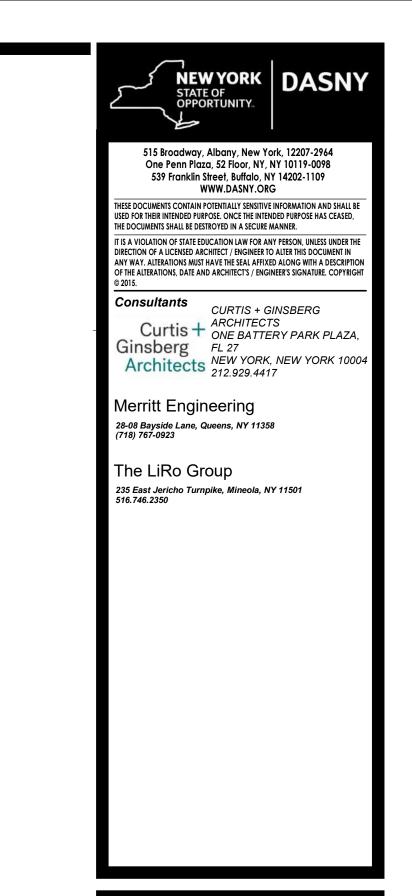

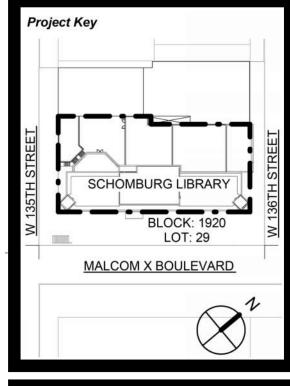


REVIS	REVISIONS		
Rev No	Description	Date:	
1			
<u>2</u>			
3			
4			
<u>5</u>			
<u>6</u>			
<u> </u>			
<u>8</u>			
<u> </u>			

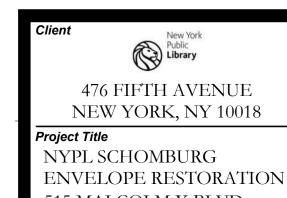


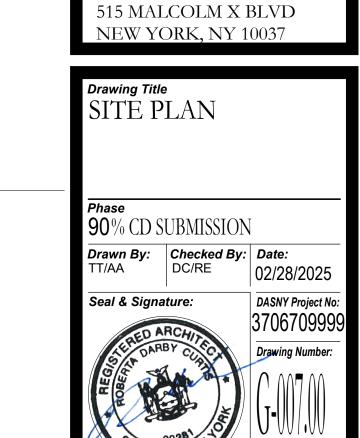



TAX LOT BOUNDARIES AND SITE SUPPORT. THE ARCHITECT ASSUMES NO RESPONSIBILITY FOR ITS ACCURACY. 2. THERE IS A FIRE HYDRANT LOCATED WITHIN 250'-0" OF ALL EXISTING BUILDING ENTRANCES AS EXISTING BUILDING 6. NO ADJACENT WETLAND AREAS OR COASTAL EROSION HAZARD AREAS. TRAFFIC DIRECTION SUBWAY GRATE

SCALE: NTS PLANTING AREA AREA OF WORK PLANS REFLECT EXISTING CONDITIONS UNLESS OTHERWISE NOTED. ALL DIMENSIONS TO BE VERIFIED IN FIELD.

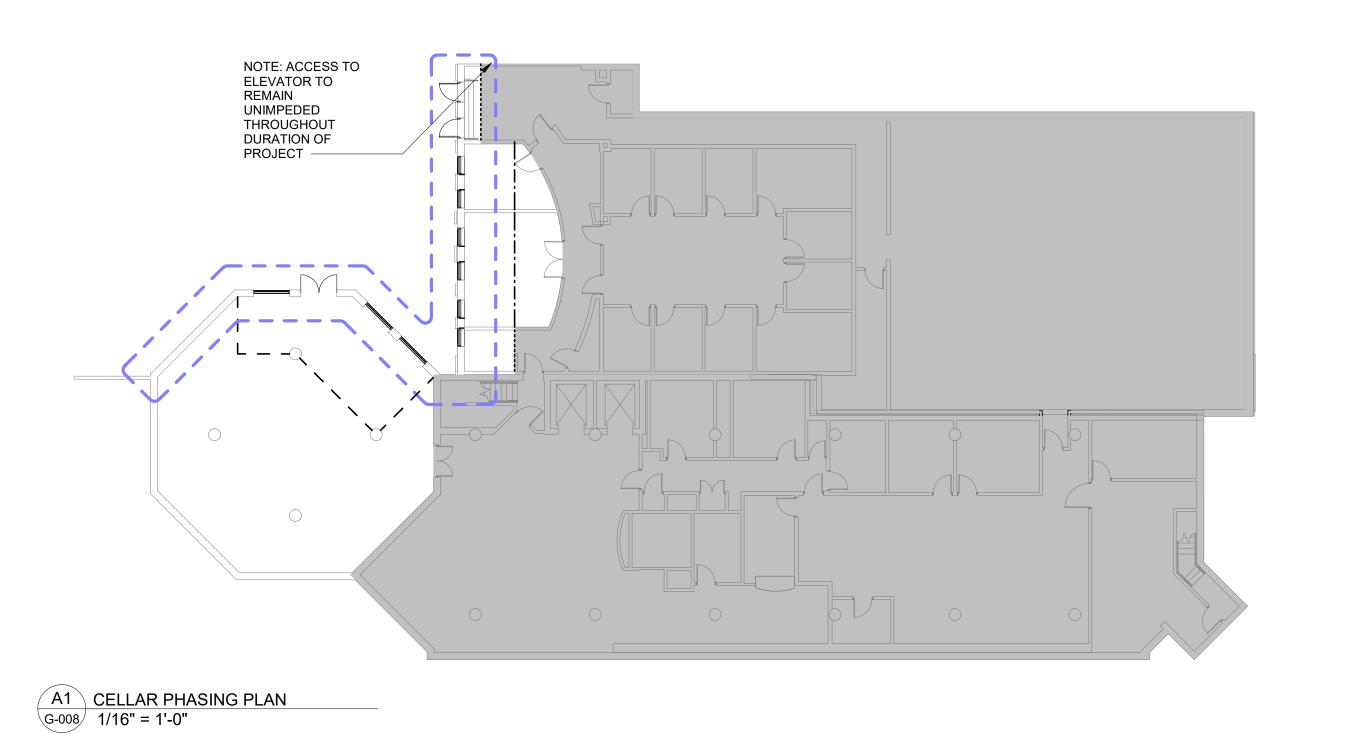

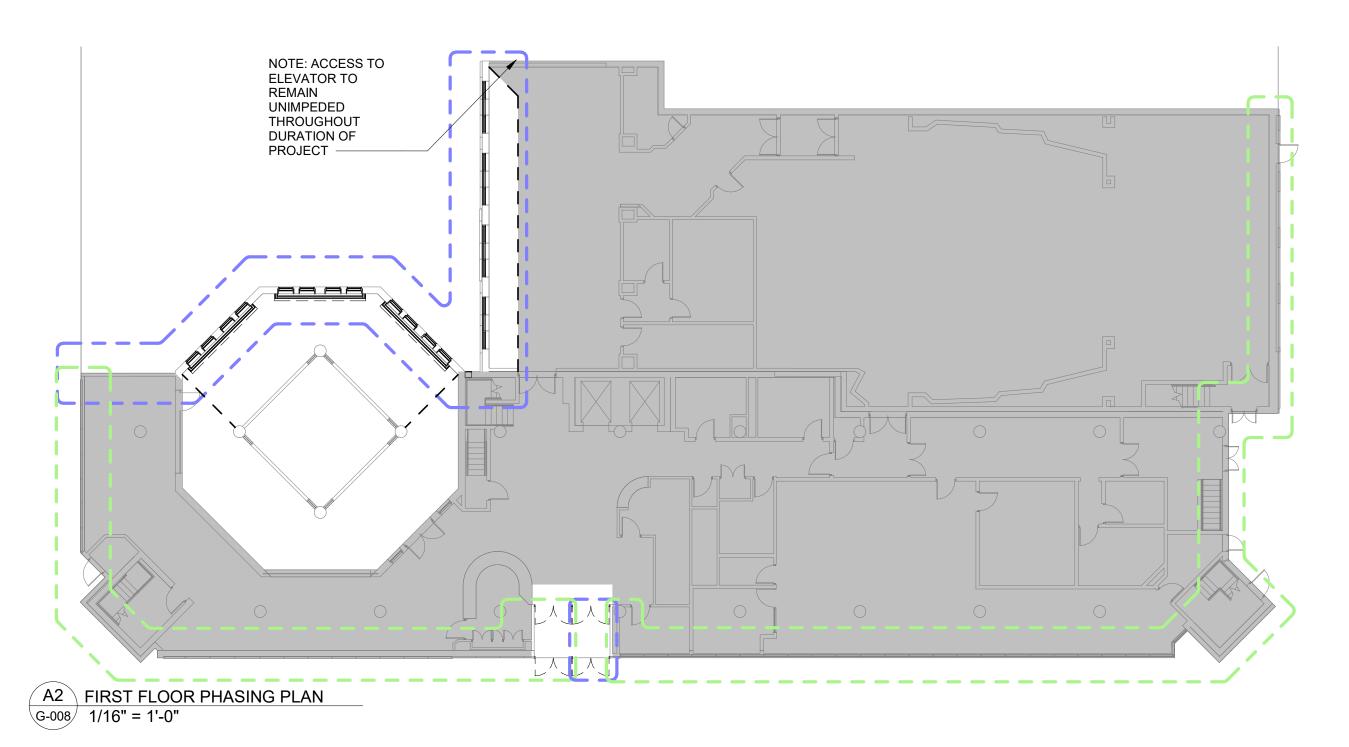

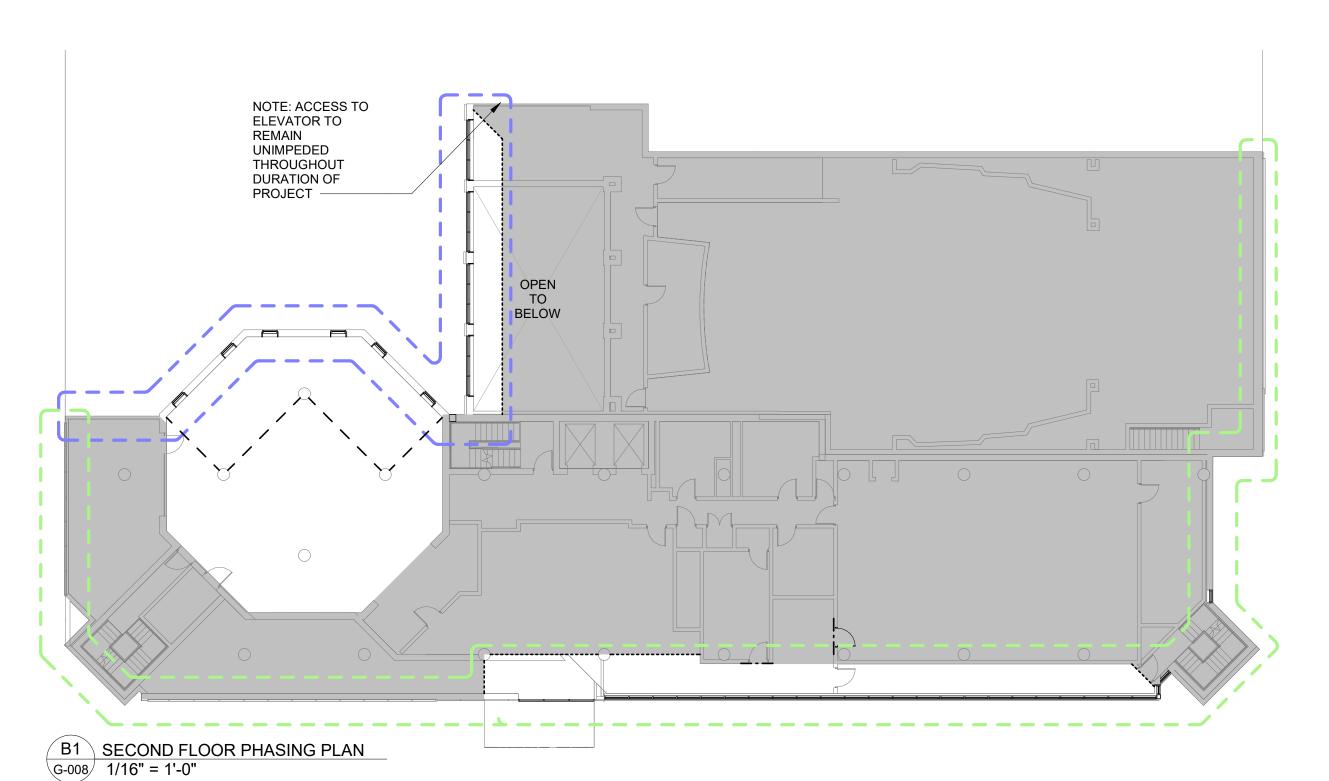

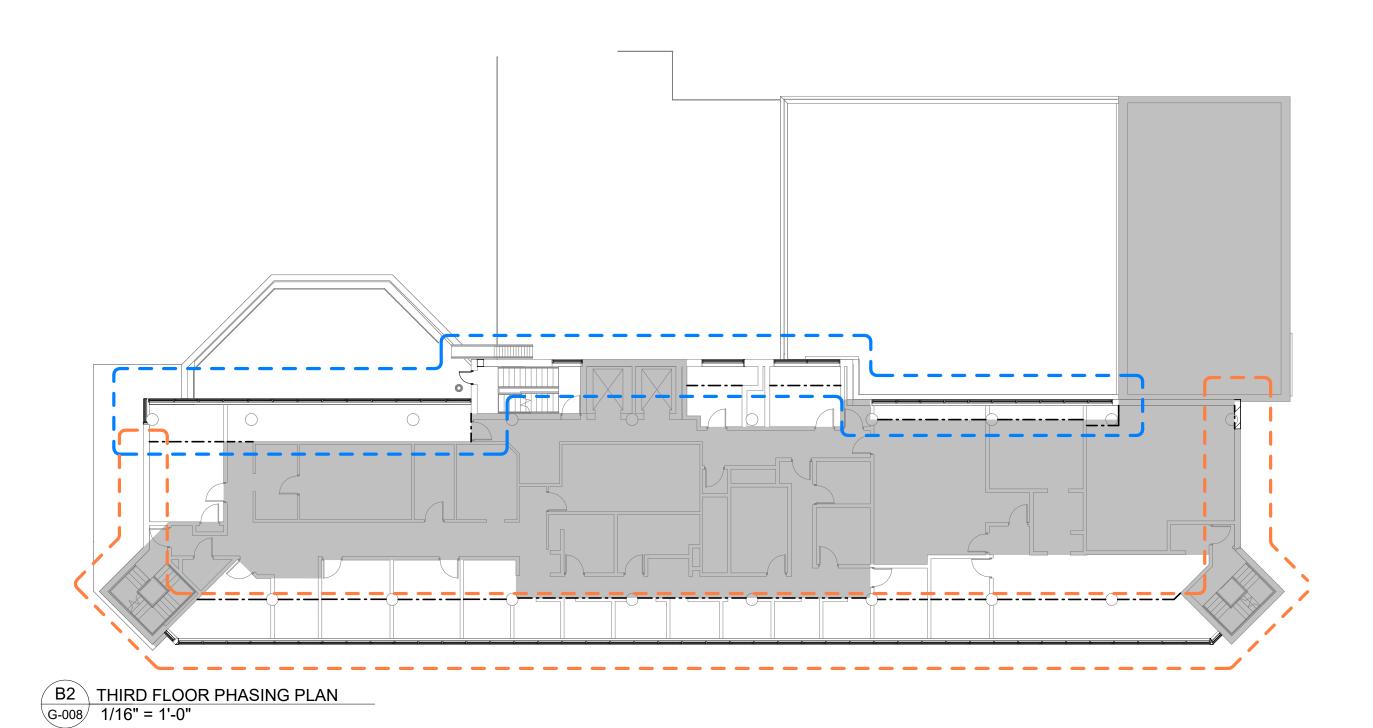

PHASING LEGEND

PHASE A PHASE B _ _ _ PHASE C ____ PHASE D ____

NOT TO BE UTILIZED FOR STAGING/WORK PARTITION TYPE A: SOLID PARTITION - METAL STUDS

WITH 1 LAYER ABUSE- — — — RESISTANT GWB EACH SIDE,

FINSH LEVEL 1 PARTITION TYPE B: SAME AS
TYPE A WITH FINISH LEVEL 3 ON PUBLIC SIDE

DUST BARRIER

NOTES: 1. MEANS OF EGRESS TO REMAIN UNIMPEDED THROUGHOUT DURATION OF

2. PUBLIC ACCESS TO ELEVATORS TO REMAIN UNIMPEDED THROUGHOUT DURATION OF PROJECT. 3. PHASING PROVIDED IS FOR REFERENCE ONLY. PHASING LOCATIONS, PROTECTIONS, DURATIONS, AND ALL

BY GC IN COORDINATION WITH OWNER.

ASSOCIATED WORK TO BE DETERMINED

DOB APPROVAL STAMPS

NEW YORK STATE OF OPPORTUNITY.

DASNY 515 Broadway, Albany, New York, 12207-2964

One Penn Plaza, 52 Floor, NY, NY 10119-0098 539 Franklin Street, Buffalo, NY 14202-1109 WWW.DASNY.ORG

THESE DOCUMENTS CONTAIN POTENTIALLY SENSITIVE INFORMATION AND SHALL BE USED FOR THEIR INTENDED PURPOSE. ONCE THE INTENDED PURPOSE HAS CEASED, THE DOCUMENTS SHALL BE DESTROYED IN A SECURE MANNER. IT IS A VIOLATION OF STATE EDUCATION LAW FOR ANY PERSON, UNLESS UNDER THE DIRECTION OF A LICENSED ARCHITECT / ENGINEER TO ALTER THIS DOCUMENT IN ANY WAY. ALTERATIONS MUST HAVE THE SEAL AFFIXED ALONG WITH A DESCRIPTION OF THE ALTERATIONS, DATE AND ARCHITECT'S / ENGINEER'S SIGNATURE. COPYRIGHT


Consultants

Consultants
CURTIS + GINSBERG
ARCHITECTS
ONE BATTERY PARK PLAZA,
Ginsberg
FL 27
Architects
NEW YORK, NEW YORK 10004
212.929.4417


Merritt Engineering

28-08 Bayside Lane, Queens, NY 11358 (718) 767-0923

The LiRo Group 235 East Jericho Turnpike, Mineola, NY 11501 516.746.2350

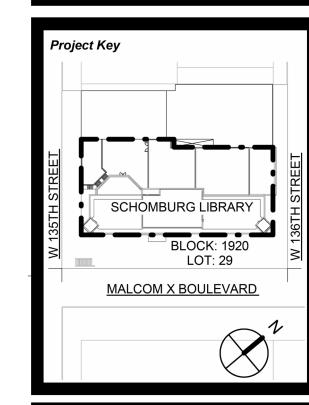


REVISIONS		
Rev No	Description	Date:
<u> </u>		
2		
3		
4		
5		
6		
<u> </u>		
8		
9		

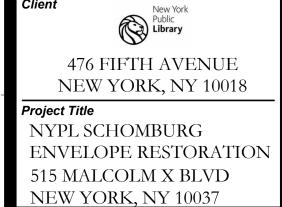





100% CD SUBMISSION

Drawn By:Checked By:Date:TT/AADC/RE02/47 Seal & Signature:

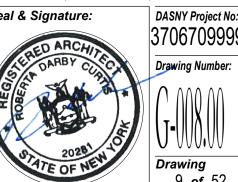

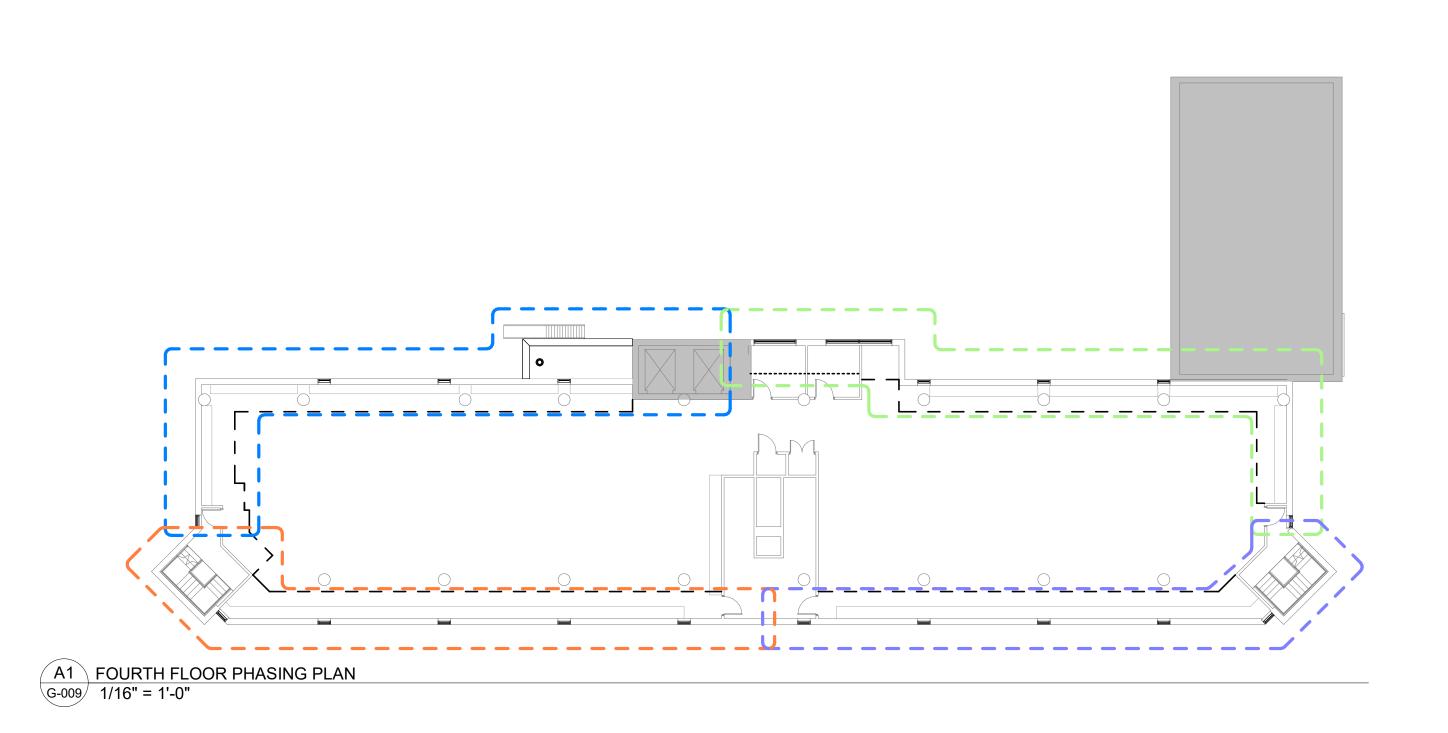

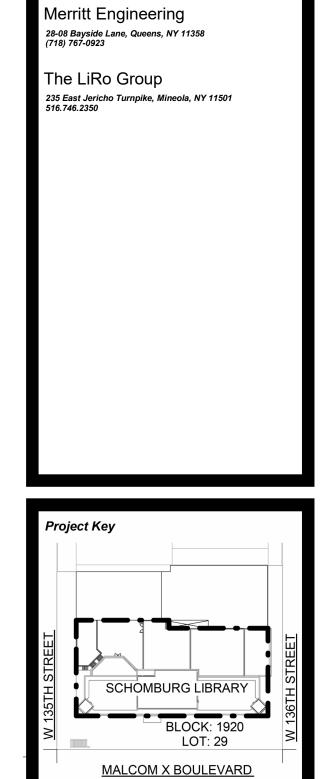

NEW YORK STATE OF OPPORTUNITY. DASNY

515 Broadway, Albany, New York, 12207-2964 One Penn Plaza, 52 Floor, NY, NY 10119-0098 539 Franklin Street, Buffalo, NY 14202-1109 WWW.DASNY.ORG

THESE DOCUMENTS CONTAIN POTENTIALLY SENSITIVE INFORMATION AND SHALL BE USED FOR THEIR INTENDED PURPOSE. ONCE THE INTENDED PURPOSE HAS CEASED, THE DOCUMENTS SHALL BE DESTROYED IN A SECURE MANNER.

IT IS A VIOLATION OF STATE EDUCATION LAW FOR ANY PERSON, UNLESS UNDER THE DIRECTION OF A LICENSED ARCHITECT / ENGINEER TO ALTER THIS DOCUMENT IN ANY WAY. ALTERATIONS MUST HAVE THE SEAL AFFIXED ALONG WITH A DESCRIPTION OF THE ALTERATIONS, DATE AND ARCHITECT'S / ENGINEER'S SIGNATURE. COPYRIGHT

Consultants

Consultants

CURTIS + GINSBERG

ARCHITECTS
ONE BATTERY PARK PLAZA,
Ginsberg
FL 27
Architects
NEW YORK, NEW YORK 10004
212.929.4417

Rev No	Description	Date:
1		
2		
3\		
4		
<u>/</u> 5\		
6\		
<u></u>		
8		
9		Ī

Chefft	New York Public
	Library
476	S FIFTH AVENUE
NEV	W YORK, NY 10018
Project Title	e
NYPL S	SCHOMBURG
ENVEL	LOPE RESTORATION
515 MA	LCOLM X BLVD
NEW Y	ORK, NY 10037

Drawing Title
PHASING PLANS II

100% CD SUBMISSION

DUST BARRIER

PHASING LEGEND

NOT TO BE UTILIZED FOR

PHASE A

PHASE B

PHASE C

PHASE D

STAGING/WORK

_ _ _

_ _ _

_ _ _

PARTITION TYPE A: SOLID PARTITION - METAL STUDS WITH 1 LAYER ABUSE- — — — RESISTANT GWB EACH SIDE, FINSH LEVEL 1 PARTITION TYPE B: SAME AS
TYPE A WITH FINISH LEVEL 3

ON PUBLIC SIDE

1. MEANS OF EGRESS TO REMAIN UNIMPEDED THROUGHOUT DURATION OF PROJECT. 2. PUBLIC ACCESS TO ELEVATORS TO REMAIN UNIMPEDED THROUGHOUT DURATION OF PROJECT. 3. PHASING PROVIDED IS FOR REFERENCE ONLY. PHASING LOCATIONS, PROTECTIONS, DURATIONS, AND ALL ASSOCIATED WORK TO BE DETERMINED BY GC IN COORDINATION WITH OWNER.

NOTES TO USERS

This map is for use in administering the National Flood Insurance Program. I does not necessarily identify all areas subject to flooding, particularly from local drainage sources of small size. The community map repository should be consulted for possible updated or additional flood hazard information.

To obtain more detailed information in areas where Base Flood Elevations (BFEs) and/or floodways have been determined, users are encouraged to consult the Flood Profiles and Floodway Data and/or Summary of Stillwater Elevations tables contained within the Flood Insurance Study (FIS) report that accompanies this FIRM. Users should be aware that BFEs shown on the FIRM represent rounded whole-foot elevations. These BFEs are intended for flood insurance rating purposes only and should not be used as the sole source of floor elevation information. Accordingly, flood elevation data presented in the FIS report should be utilized in conjunction with the FIRM for purposes of construction and/or floodplain management.

Coastal Base Flood Elevations (BFEs) shown on this map apply only landward of 0.0' National Geodetic Vertical Datum of 1929 (NGVD 29). Users of this FIRM should be aware that coastal flood elevations are also provided in the Summary of Stillwater Elevations tables in the Flood Insurance Study report for this jurisdiction. Elevations shown in the Summary of Stillwater Elevations tables should be used for construction and/or floodplain management purposes when they are higher than the elevations shown on this FIRM.

Boundaries of the floodways were computed at cross sections and interpolated between cross sections. The floodways were based on hydraulic considerations with regard to requirements of the National Flood Insurance Program. Floodway widths and other pertinent floodway data are provided in the Flood Insurance

Certain areas not in Special Flood Hazard Areas may be protected by flood control structures. Refer to Section 2.4 "Flood Protection Measures" of the Flood Insurance Study report for information on flood control structures for this

The projection used in the preparation of this map was New York State Plane FIPSZONE 3104. The horizontal datum was NAD 83, GRS80 spheroid. Differences in datum, spheroid, projection or State Plane zones used in the production of FIRMs for adjacent jurisdictions may result in slight positional differences in map features across jurisdiction boundaries. These differences do not affect the accuracy of this FIRM.

Flood elevations on this map are referenced to the National Geodetic Vertical Datum of 1929. These flood elevations must be compared to structure and ground elevations referenced to the same vertical datum. For information regarding conversion between the National Geodetic Vertical Datum of 1929 and the North American Vertical Datum of 1988, visit the National Geodetic Survey website at http://www.ngs.noaa.gov or contact the National Geodetic Survey at the following address:

NGS Information Services National Geodetic Survey SSMC-3, #9202 1315 East-West Highway

Silver Spring, Maryland 20910-3182

(301) 713-3242 To obtain current elevation, description, and/or location information for bench marks shown on this map, please contact the Information Services Branch of the National Geodetic Survey at (301) 713-3242, or visit its website at

http://www.ngs.noaa.gov. Base map information shown on this FIRM was provided in digital format by the Department of Information Technology and Telecommunication, City of New York. This information was derived from digital orthophotos produced at a scale of 1:1,200 with 2-foot pixel resolution from photography dated 2004.

Based on updated topographic information, this map reflects more detailed and up-to-date stream channel configurations and floodplain delineations than those shown on the previous FIRM for this jurisdiction. As a result, the Flood Profiles and Floodway Data tables in the Flood Insurance Study Report (which contains authoritative hydraulic data) may reflect stream channel distances that differ from what is shown on this map. Also, the road to floodplain relationships for unrevised streams may differ from what is shown on previous maps.

Corporate limits shown on this map are based on the best data available at the have occurred after this map was published, map users should contact appropriate community officials to verify current corporate limit locations.

Please refer to the separately printed Map Index for an overview map showing the layout of map panels for this jurisdiction

Contact the FEMA Map Service Center at 1-800-358-9616 for information on available products associated with this FIRM. Available products may include previously issued Letters of Map Change, a Flood Insurance Study report, and/or digital versions of this map. The FEMA Map Service Center may also be reached

by Γax at 1-800-358-9620 and its website at http://msc.fema.gov.

If you have questions about this map or questions concerning the National Flood Insurance Program in general, please call 1-877-FEMA MAP (1-877-336-2627) or visit the FEMA website at http://www.fema.gov.



LEGEND

SPECIAL FLOOD HAZARD AREAS SUBJECT TO INUNDATION BY THE 1% ANNUAL CHANCE FLOOD The 1% annual flood (100-year flood), also known as the base flood, is the flood that has a 1% chance of being equaled or exceeded in any given year. The Special Flood Hazard Area is the area subject to flooding by the 1% annual chance flood. Areas of Special Flood Hazard include Zones A, AE, AH, AO, AR, A99, V, and VE. The Base Flood Elevation is the water-surface elevation of the 1% annual chance flood.

No Base Flood Elevations determined. ZONE AE Base Flood Elevations determined. Flood depths of 1 to 3 feet (usually areas of ponding); Base Flood

ZONE AO Flood depths of 1 to 3 feet (usually sheet flow on sloping terrain); average depths determined. For areas of alluvial fan flooding, velocities also Special Flood Hazard Area formerly protected from the 1% annual chance flood by a flood control system that was subsequently decertified. Zone AR indicates that the former flood control system is being restored to provide protection from the 1% annual chance or greater flood. Area to be protected from 1% annual chance flood by a Federal flood protection system under construction; no Base Flood Elevations

Coastal flood zone with velocity hazard (wave action); no Base Flood Coastal flood zone with velocity hazard (wave action); Base Flood FLOODWAY AREAS IN ZONE AE

The floodway is the channel of a stream plus any adjacent floodplain areas that must be kept free of encroachment so that the 1% annual chance flood can be carried without substantial increases OTHER FLOOD AREAS ZONE X Areas of 0.2% annual chance flood; areas of 1% annual chance flood with average depths of less than 1 foot or with drainage areas less than 1 square mile; and areas protected by levees from 1% annual chance flood OTHER AREAS

ZONE D Areas in which flood hazards are undetermined, but possible. COASTAL BARRIER RESOURCES SYSTEM (CBRS) AREAS OTHERWISE PROTECTED AREAS (OPAs) CBRS areas and OPAs are normally located within or adjacent to Special Flood Hazard Areas.

ZONE X

Areas determined to be outside the 0.2% annual chance floodplain.

1% annual chance floodplain boundary

0.2% annual chance floodplain boundary Floodway boundary Zone D boundary _____ CBRS and OPA boundary

Boundary dividing Special Flood Hazard Area Zones and boundary dividing Special Flood Hazard Areas of different Base Flood Elevations, flood depths or flood velocities. → 513 → Base Flood Elevation line and value; elevation in feet* Base Flood Elevation value where uniform within zone; elevation * Referenced to the National Geodetic Vertical Datum of 1929

(3)----(3) Geographic coordinates referenced to the North American Datum of 1983 (NAD 83), Western Hemisphere 87°07'45", 32°22'30" 1000-meter Universal Transverse Mercator grid values, zone ²⁴76^{000™}N 5000-foot grid ticks: New York State Plane coordinate system, 600000 FT Long Island zone (FIPSZONE 3104), Lambert Conformal Conic Bench mark (see explanation in Notes to Users section of this

> River Mile MAP REPOSITORY Refer to listing of Map Repositories on Map Index INITIAL NEIP MAP DATE June 28, 1974 FLOOD HAZARD BOUNDARY MAP REVISIONS June 11, 1976 FLOOD INSURANCE RATE MAP EFFECTIVE November 16, 1983

FLOOD INSURANCE RATE MAP REVISIONS September 5, 2007 - to change Special Flood Hazard Areas, to reflect updated topographic information, and to update map format

To determine if flood insurance is available in this community, contact your Insurance agent or call the National Flood Insurance Program at 1-800-638-6620.

PANEL 0079F FLOOD INSURANCE RATE MAP CITY OF NEW YORK, NEW YORK BRONX, RICHMOND, NEW YORK, QUEENS, AND KINGS COUNTIES PANEL 79 OF 457 (SEE MAP INDEX FOR FIRM PANEL LAYOUT) CONTAINS COMMUNITY NUMBER PANEL SUFFIX NEW YORK, CITY OF 360497 0079 F Notice to User: The Map Number shown below should be used when placing map orders; the Community Number shown above should be used on insurance applications for the MAP NUMBER 3604970079F

MAP REVISED

SEPTEMBER 5, 2007

Federal Emergency Management Agency

DOB APPROVAL STAMPS

515 Broadway, Albany, New York, 12207-2964 One Penn Plaza, 52 Floor, NY, NY 10119-0098 WWW.DASNY.ORG


539 Franklin Street, Buffalo, NY 14202-1109 IESE DOCUMENTS CONTAIN POTENTIALLY SENSITIVE INFORMATION AND SHALL BE SED FOR THEIR INTENDED PURPOSE. ONCE THE INTENDED PURPOSE HAS CEASED, THE DOCUMENTS SHALL BE DESTROYED IN A SECURE MANNER. IT IS A VIOLATION OF STATE EDUCATION LAW FOR ANY PERSON, UNLESS UNDER THE

DIRECTION OF A LICENSED ARCHITECT / ENGINEER TO ALTER THIS DOCUMENT IN ANY WAY AITERATIONS MIIST HAVE THE SEAL AFFIXED ALONG WITH A DESCRIPTION OF THE ALTERATIONS, DATE AND ARCHITECT'S / ENGINEER'S SIGNATURE. COPYRIGH Consultants CURTIS + GINSBERG


Curtis + ARCHITECTS
ONE BATTERY PARK PLAZA, Ginsberg FL 27 Architects NEW YORK, NEW YORK 10004

Merritt Engineering 28-08 Bayside Lane, Queens, NY 11358 (718) 767-0923

The LiRo Group 235 East Jericho Turnpike, Mineola, NY 11501 516.746.2350

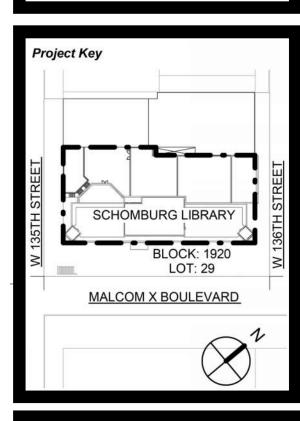


REVIS Rev No	Description	Date:
<u></u>		
2		
<u>3</u>		
4		
<u>/</u> 5		
6		
<u> </u>		
8		
9		

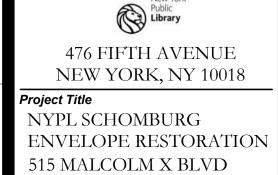



NEW YORK, NY 10037

90% CD SUBMISSION Drawn By: | Checked By: | Date: RE/TT/AA DC/SL

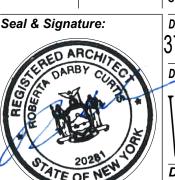

DASNY Project No

THIS PROPERTY IS NOT LOCATED IN A SPECIAL FLOOD HAZARD AREA (SFHA).

1. ALL ELEVATIONS REFER TO NAVD (19)88 DATUM. 2. SURVEY AND ALL INFORMATION INCLUDED WITHIN HAS BEEN PREPARED BY OTHERS AND HAS BEEN PROVIDED FOR REFERENCE PURPOSES ONLY. CURTIS + GINSBERG ARCHITECTS LLP ARE NOT RESPONSIBLE FOR THE ACCURACY OR COMPLETENESS OF INFORMATION CONTAINED WITHIN THIS SURVEY.

NOTES TO USERS

This map is for use in administering the National Flood Insurance Program. It does not necessarily identify all areas subject to flooding, particularly from local drainage sources of small size. The community map repository should be consulted for possible updated or additional flood hazard information.

To obtain more detailed information in areas where Base Flood Elevations (BFEs) and/or floodways have been determined, users are encouraged to consult the Flood Profiles and Floodway Data and/or Summary of Stillwater Elevations tables contained within the Flood Insurance Study (FIS) report that accompanies this FIRM. Users should be aware that BFEs shown on the FIRM represent rounded whole-foot elevations. These BFEs are intended for flood insurance rating purposes only and should not be used as the sole source of flood elevation information. Accordingly, flood elevation data presented in the FIS report should be utilized in conjunction with the FIRM for purposes of construction and/or floodplain management.

Coastal Base Flood Elevations shown on this map apply only landward of 0.0' North American Vertical Datum of 1988 (NAVD 88). Users of this FIRM should be aware that coastal flood elevations are also provided in the Summary of Stillwater Elevations tables in the Flood Insurance Study report for this jurisdiction. Elevations shown in the Summary of Stillwater Elevations tables should be used for construction and/or floodplain management purposes when they are higher than the elevations shown on this FIRM.

Boundaries of the floodways were computed at cross sections and interpolated between cross sections. The floodways were based on hydraulic considerations with regard to requirements of the National Flood Insurance Program. Floodway widths and other pertinent floodway data are provided in the Flood Insurance Study report for this jurisdiction.

Certain areas not in Special Flood Hazard Areas may be protected by flood

control structures. Refer to Section 2.4 "Flood Protection Measures" of the Flood Insurance Study report for information on flood control structures for this jurisdiction.

The projection used in the preparation of this map was New York Long Island State Plane FIPSZONE 3104. The horizontal datum was NAD 83. GRS80

State Plane FIPSZONE 3104. The horizontal datum was NAD 83, GRS80 spheroid. Differences in datum, spheroid, projection or State Plane zones used in the production of FIRMs for adjacent jurisdictions may result in slight positional differences in map features across jurisdiction boundaries. These differences do not affect the accuracy of this FIRM.

Flood elevations on this map are referenced to the North American Vertical Datum of 1988. These flood elevations must be compared to structure and ground elevations referenced to the same vertical datum. For information regarding conversion between the National Geodetic Vertical Datum of 1929 and the North American Vertical Datum of 1988, visit the National Geodetic Survey website at http://www.nos.noaa.cov or contact the National Geodetic Survey at the following address:

NGS Information Services NOAA, N/NGS12 National Geodetic Survey SSMC-3, #9202 1315 East-West Highway Silver Spring, Maryland 20910-3182

(301) 713-3242

community is located.

To obtain current elevation, description, and/or location information for bench marks shown on this map, please contact the Information Services Branch of the National Geodetic Survey at (301) 713-3242, or visit its website at http://www.nos.noaa.gov.

Base map information shown on this FIRM was provided in digital format by the

Department of Information Technology and Telecommunication, City of New York (DoITT). This information was derived from digital orthophotos produced at a scale of 1:1,200 with 2-foot pixel resolution from photography dated April 2008.

This map reflects more detailed and up-to-date stream channel configurations than those shown on the previous FIRM for this jurisdiction. The floodplains and floodways that were transferred from the previous FIRM may have been adjusted to conform to these new stream channel configurations. As a result, the Flood

Profiles and Floodway Data tables in the Flood Insurance Study Report (which

contains authoritative hydraulic data) may reflect stream channel distances that differ from what is shown on this map.

Corporate limits shown on this map are based on the best data available at the time of publication. Because changes due to annexations or de-annexations may have occurred after this map was published, map users should contact

Please refer to the separately printed Map Index for an overview map of the county showing the layout of map panels; community map repository addresses; and a Listing of Communities table containing National Flood Insurance Program dates for each community as well as a listing of the panels on which each

appropriate community officials to verify current corporate limit locations.


The AE Zone category has been divided by a Limit of Moderate Wave Action (LiMWA). The LiMWA represents the approximate landward limit of the 1.5 - foot breaking wave. The effects of wave hazards between the VE Zone and the LiMWA (or between the shoreline and the LiMWA for areas where VE Zones are not identified) will be similar to, but less severe than those in the VE Zone.

For information on available products associated with this FIRM visit the Map Service Center (MSC) website at http://msc.fema.gov. Available products may include previously issued Letters of Map Change, a Flood Insurance Study Report, and/or digital versions of this map. Many of these products can be ordered or obtained directly from the MSC website.

If you have questions about this map, how to order products or the National Flood Insurance Program in general, please call the FEMA Map Information eXchange (FMIX) at 1-877-FEMA-MAP (1-877-336-2627) or visit the FEMA website at http://www.fema.gov/business/nfip.



LEGEND SPECIAL FLOOD HAZARD AREAS SUBJECT TO INUNDATION BY THE 1% ANNUAL CHANCE FLOOD The 1% annual flood (100-year flood), also known as the base flood, is the flood that has a 1% chance of being equaled or exceeded in any given year. The Special Flood Hazard Area is the area subject to flooding by the 1% annual chance flood. Areas of Special Flood Hazard include Zones A, AE, AH, AO, AR, A99, V, and VE. The Base Flood Elevation is the water-surface elevation of the 1% annual chance flood. ZONE A No Base Flood Elevations determined. ZONE AE Base Flood Elevations determined. ZONE AH Flood depths of 1 to 3 feet (usually areas of ponding); Base Flood Flood depths of 1 to 3 feet (usually sheet flow on sloping terrain); average depths determined. For areas of alluvial fan flooding, velocities also ZONE AO Special Flood Hazard Area formerly protected from the 1% annual chance flood by a flood control system that was subsequently decertified. Zone AR indicates that the former flood control system is being restored to rovide protection from the 1% annual chance or greater floor Area to be protected from 1% annual chance flood by a Federal flood protection system under construction; no Base Flood Elevations Coastal flood zone with velocity hazard (wave action); no Base Flood Coastal flood zone with velocity hazard (wave action); Base Flood FLOODWAY AREAS IN ZONE AE The floodway is the channel of a stream plus any adjacent floodplain areas that must be kept free of encroachment so that the 1% annual chance flood can be carried without substantial increases in flood heights. OTHER FLOOD AREAS Areas of 0.2% annual chance flood; areas of 1% annual chance flood with average depths of less than 1 foot or with drainage areas less than 1 square mile; and areas protected by levees from 1% annual chanceflood. OTHER AREAS Areas determined to be outside the 0.2% annual chance floodplain. Areas in which flood hazards are undetermined, but possible. COASTAL BARRIER RESOURCES SYSTEM (CBRS) AREAS OTHERWISE PROTECTED AREAS (OPAs) CBRS areas and OPAs are normally located within or adjacent to Special Flood Hazard Areas. 1% annual chance floodplain boundary 0.2% annual chance floodplain boundary Floodway boundary Zone D boundary CBRS and OPA boundary Boundary dividing Special Flood Hazard Area Zones and boundary dividing Special Flood Hazard Areas of different Base Flood Bevations, flood depths or flood velocities. Limit of Moderate Wave Action ---- 513 ·----Base Flood Elevation line and value; elevation in feet* (EL 987) Base Flood Elevation value where uniform within zone; elevation in feet* Referenced to the North American Vertical Datum of 1968 Cross section line Transect line Culvert, Flume, Penstock or Aqueduct Road or Railroad Bridge Geographic coordinates referenced to the North American 87°07'45", 32°22'30" Datum of 1983 (NAD 83), Western Hemisphere 2476000 N 1000-meter Universal Transverse Mercator grid values, zone 18 5000-foot grid values: New York State Plane coordinate system, Long Island zone (FIPSZONE 3104), Lambert Conformal Conic projection Bench mark (see explanation in Notes to Users section of this FIRM panel) MAP REPOSITORY
Refer to listing of Map Repositories on Map Index INITIAL NFIP MAP DATE June 28, 1974 FLOOD HAZARD BOUNDARY MAP REVISIONS June 11, 1976 FLOOD INSURANCE RATE MAP EFFECTIVE November 16, 1983 FLOOD INSURANCE RATE MAP REVISIONS For descriptions of revisions see Notice to Users page in the Flood Insurance Study To determine if flood insurance is available in this community, contact your Insurance agent or call the National Flood Insurance Program at 1-800-638-6620.

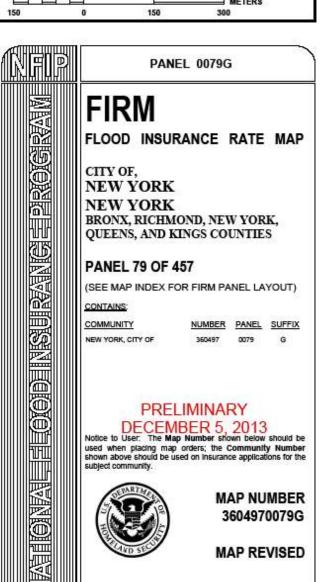

Federal Emergency Management Agency

MAP SCALE 1" = 500"

DOB APPROVAL STAMPS

515 Broadway, Albany, New York, 12207-2964
One Penn Plaza, 52 Floor, NY, NY 10119-0098
539 Franklin Street, Buffalo, NY 14202-1109
WWW.DASNY.ORG

THESE DOCUMENTS CONTAIN POTENTIALLY SENSITIVE INFORMATION AND SHALL BE
USED FOR THEIR INTENDED PURPOSE. ONCE THE INTENDED PURPOSE HAS CEASED,
THE DOCUMENTS SHALL BE DESTROYED IN A SECURE MANNER.

IT IS A VIOLATION OF STATE EDUCATION LAW FOR ANY PERSON, UNLESS UNDER THE
DIRECTION OF A LICENSED ARCHITECT / ENGINEER TO ALTER THIS DOCUMENT IN
ANY WAY. ALTERATIONS MUST HAVE THE SEAL AFFIXED ALONG WITH A DESCRIPTIO
OF THE ALTERATIONS, DATE AND ARCHITECT'S / ENGINEER'S SIGNATURE. COPYRIGH
© 2015.

CONSULTANTS

CURTIS + GINSBERG


Ginsberg FL 27
Architects NEW YORK, NEW YORK 10004
212.929.4417

Merritt Engineering

Curtis + ARCHITECTS
ONE BATTERY PARK PLAZA,

Merritt Engineering 28-08 Bayside Lane, Queens, NY 11358 (718) 767-0923

The LiRo Group
235 East Jericho Turnpike, Mineola, NY 11501
546 746 2350

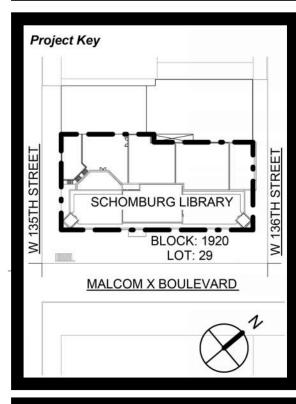

REVISIONS		
Rev No	Description	Date:
<u>1</u>		
<u>2</u>		
3		
4		
<u> </u>		
<u>6</u>		
<u> </u>		
<u>8</u>		
9		



PRE-LIM FIRM MAP (FOR REFERENCE ONLY)

90% CD SUBMISSION

Drawn By: Checked By: Date:

Seal & Signature:



FLOOD ZONE COMPLIANCE STATEMENT:

THIS PROPERTY IS NOT LOCATED IN A SPECIAL FLOOD HAZARD AREA (SFHA).

1. ALL ELEVATIONS REFER TO NAVD (19)88 DATUM.
2. SURVEY AND ALL INFORMATION INCLUDED WITHIN HAS BEEN PREPARED BY OTHERS AND HAS BEEN PROVIDED FOR REFERENCE PURPOSES ONLY. CURTIS + GINSBERG ARCHITECTS LLP ARE NOT RESPONSIBLE FOR THE ACCURACY OR COMPLETENESS OF INFORMATION CONTAINED WITHIN THIS SURVEY.

DEMOLITION NOTES

1. ALL DEMOLITION AND REMOVAL WORK SHALL BE COMPLETED AS INDICATED & NOTED ON THE DRAWINGS AND AS SPECIFIED. ALL DEMOLITION WORK SHALL COMPLY WITH THE NYC 2022 BUILDING CODE CHAPTER 33 - SAFEGUARDS DURING CONSTRUCTION OR DEMOLITION AND AS REFERENCED HEREIN.

2. BEFORE STARTING WORK, THE G.C. SHALL MAKE A THOROUGH EXAMINATION OF THOSE PORTIONS OF THE STRUCTURE IN WHICH THE WORK IS TO BE PERFORMED, CHECK ALL THE WORK ADJOINING OR AT UNDERLYING LOCATIONS. REPORT TO THE ARCHITECT ANY AND ALL CONDITIONS WHICH MAY INTERFERE WITH OR OTHERWISE AFFECT OR PREVENT THE PROPER EXECUTION AND COMPLETION OF THE WORK. NO WORK SHALL COMMENCE UNTIL SUCH CONDITIONS HAVE BEEN EXAMINED AND A COURSE OF ACTIONS MUTUALLY AGREED UPON.

3. PRIOR TO THE START OF DEMOLITION, THE CONTRACTOR SHALL CALL TO THE ATTENTION OF THE OWNER ANY DAMAGE, CRACKS OR OTHER IMPERFECTIONS IN THE WORK ADJACENT TO DEMOLITIONS AREAS.

4. BEFORE STARTING DEMOLITION OPERATIONS, G.C. SHALL PROVIDE THE NECESSARY PROTECTIVE DEVICES, WHERE REQUIRED, AND IN STRICT ACCORDANCE WITH OSHA RULES AND REGULATIONS. G.C. SHALL BE RESPONSIBLE FOR PROVIDING BRACING, SCOPE OF WORK, AND SEQUENCE OF DEMOLITION OPERATIONS FOR NYC DEPARTMENT OF BUILDINGS APPROVAL PRIOR TO OBTAINING WORK PERMIT FROM D.O.B. ENGINEER/ARCHITECT RETAINED BY OWNER SHALL FILE RELEVANT D.O.B. APPLICATIONS AS REQUIRED, INCLUDING UNDERPINNING, TEST PITS, SUBGRADE AND DEMOLITION.

5. EXECUTE THE DEMOLITION IN A CAREFUL AND ORDERLY MANNER WITH THE LEAST POSSIBLE DISTURBANCE TO THE PUBLIC, EGRESS OR THE FUNCTIONING OF THE EXISTING BUILDING.

6. TAKE NECESSARY PRECAUTIONS TO PREVENT DUST AND DIRT FROM RISING BY WETTING DEMOLISHED DEBRIS. EXCESSIVE USE OF WATER WILL NOT BE PERMITTED.

7. KEEP ALL ADJOINING PROPERTIES CLEAN AND FREE OF DEBRIS OR CONSTRUCTION MATERIALS DURING WORKING HOURS, AND MAKE AN EFFORT TO PROVIDE SAFE CONDITIONS FOR THE GENERAL PUBLIC AND WORKMEN.

8. DEMOLISHED MATERIALS, UNLESS OTHERWISE NOTED, SHALL BECOME THE PROPERTY OF THE CONTRACTOR AND SHALL BE DISPOSED OF OFF THE SITE, ON A REGULAR BASIS, IN A LEGAL

9. ERECT, MAINTAIN, AND WHEN NO LONGER NECESSARY, REMOVE PROTECTIVE BARRIERS, LIGHTING AND/OR SIGNAGE TO MAINTAIN LEGAL EGRESS FROM UNAFFECTED MALL AREAS AND TO PROTECT PUBLIC AND WORKMEN FROM CONSTRUCTION.

10. REPAIR AND/OR REPLACE EXISTING ITEMS NOT SCHEDULED OR NOTED TO BE DEMOLISHED, AND NOT SPECIFIED TO BE REMOVED, BUT WHICH BECOME DAMAGED DURING THE PROGRESS OF THE WORK. MAKE ANY AND ALL SUCH REPAIRS, REPLACEMENTS AND MODIFICATIONS TO RESTORE THE DAMAGED ITEMS TO THEIR ORIGINAL CONDITION AT THE TIME OF DAMAGE, TO THE SATISFACTION OF AND AT NO ADDITIONAL COST TO THE OWNER.

11. PATCH, FILL AND REPAIR ALL DISTURBED SURFACES (INTERIOR TO REMAIN) THAT WERE CUT, DAMAGED, IN NEED OF REPAIR OR REMOVAL WORK, AND AS REQUIRED TO PREPARE SURFACES TO RECEIVE MATERIALS AND ARRANGEMENTS.

12. THE GENERAL CONTRACTOR SHALL ASCERTAIN THAT THE AREA OF DEMOLITION HAS BEEN CLEARED BY OTHERS OF ALL FURNITURE AND MOVABLE EQUIPMENT IN ORDER TO ALLOW FOR DEMOLITION TO PROCEED. G.C. SHALL NOTIFY M.A.I. IMMEDIATELY OF ANY SUCH CONDITIONS PREVENTING HIS PROCEEDING WITH DEMOLITION.

13. G.C. TO PROVIDE ALL LABOR, MATERIAL, EQUIPMENT & SERVICES FOR ALL DEMOLITION OF WORK, INCLUDING REMOVAL FROM THE BUILDING AS NOTED AND INTENDED ON THE DRAWINGS.

14. TEMPORARY LIGHTING IS TO BE PROVIDED AS PER CODE.

15. DO NOT REMOVE ANY STRUCTURAL ELEMENTS WITHOUT PRIOR WRITTEN CONSULTATION BY STRUCTURAL ENGINEER. EXISTING STRUCTURAL ELEMENTS TO BE PROTECTED DURING DEMOLITION OPERATIONS.

16. G.C. TO PATCH ALL SURFACES AFFECTED BY DEMOLITION AND PREPARE TO RECEIVE FINISH.

17. COORDINATE ALL DEMOLITION WORK WITH OTHER CONTRACTS, INCLUDING BUT NOT LIMITED TO ROOFING AND WINDOW REPLACEMENT.

18. PROTECT AND SEAL AFFECTED INTERIOR SURFACES, INCLUDING BUT NOT LIMITED TO WINDOWS

PARTITIONS & DOORS:

19. REMOVE ALL PARTITIONS IN THEIR ENTIRETY, WHERE INDICATED, INCLUDING REBAR DOORS

20. A) REMOVE ALL DOORS, FRAMES AND RELATED HARDWARE, WHERE INDICATED TO PROVIDE CLEAR MASONRY OPENING.

B) COORDINATE WITH ARCHITECT FOR DOORS, FRAMES AND HARDWARE TO BE SALVAGED.

21. DEMOLITION CONTRACTOR SHALL NOT REMOVE BUILDING CORE DOORS INCLUDING FIRE EXIT DOORS AND ELEVATOR DOORS, UNLESS OTHERWISE NOTED.

ELECTRICAL/DATA/PHONE:

22. COORDINATE WITH ENGINEERING DRAWINGS. VERIFY QUANTITIES AND CONDITIONS IN FIELD.

23. ANY REQUIRED REMOVAL OF ELECTRICAL EQUIPMENT SHALL BE DONE IN SUCH A WAY AS TO ALLOW THE OPERATIONS OF ADJACENT FLOORS TO CONTINUE WITHOUT INTERRUPTION OF ANY SERVICE DURING DEMOLITION AND CONSTRUCTION. THE CONTRACTOR SHALL TAKE ALL NECESSARY PRECAUTIONS IN ORDER TO COMPLY WITH THIS ORDER.

20. THE CONTRACTOR SHALL PROBE ALL CABLES PRIOR TO REMOVAL TO INSURE THAT NO OPERATIONS ARE INADVERTENTLY INTERRUPTED.

21. G.C. SHALL HAVE AN ELECTRICIAN ON PREMISES DURING DEMOLITION AFFECTING ELECTRICAL LINES IN AREA OF WORK AND ADJACENT SPACES.

FIRE ALARM:

22. REFER TO ENGINEERING DRAWINGS.

23. FIRE AND SMOKE DETECTION SYSTEM (EXISTING): TO REMAIN IN OPERATION DURING DEMOLITION AND CONSTRUCTION INCLUDING ALL STROBES.

24. DO NOT REMOVE ANY BUILDING CLASS "E" FIRE PROTECTION SIGNALS OR EQUIPMENT, U.O.N. PROTECT ALL DEVICES AND CABLES AS REQUIRED FOR DURATION OF THE JOB.

25. WHERE DEMOLITION IS TO TAKE PLACE IN THE AREA OF THE BUILDING WHERE FIRE SAFETY EQUIPMENT SUCH AS ALARMS, SPEAKERS, SMOKE DETECTORS, FLOOR WARDEN STATIONS, ETC. ARE LOCATED, THE BUILDING MANAGER MUST BE NOTIFIED THREE (3) WORKING DAYS PRIOR TO START OF DEMOLITION SO EQUIPMENT CAN BE REMOVED OR PROTECTED.

DUCTWOR

26. REFER TO MECHANICAL DEMOLITION DRAWINGS.

27. PROTECT AND SEAL ALL BUILDING DUCTS, EQUIPMENT, VENTS AS REQUIRED DURING DEMOLITION AND CONSTRUCTION, U.O.N

CEILING

28. A) REMOVE CEILINGS ADJACENT TO WINDOW REPLACEMENTS ONLY AS REQUIRED.
B) PROTECT CEILINGS NOT IN SCOPE AS REQUIRED.

LIGHT FIXTURES:

29. REMOVE EXISTING LIGHT FIXTURES, RECESSED AND SURFACE MOUNTED, ALL EXIT LIGHTS AND SWITCHES IN "AREA OF WORK" SCHEDULED TO BE REPLACED, U.O.N. ELECTRICAL FEEDS / HOMERUNS TO REMAIN FOR RECIRCUITING. TEMPORARY LIGHTING AND EXIT SIGNAGE SHALL BE PROVIDED AS REQUIRED DURING CONSTRUCTION.

FINISHES:

30. WALLS: ON WALLS TO REMAIN, G.C. TO CAREFULLY REMOVE ALL EXISTING WALL FINISHES. PREPARE WALL SURFACE TO RECEIVE WALL FINISHES, AS APPLICABLE.

BASE:

31. G.C. TO REMOVE ALL EXISTING BASE, WHERE INDICATED, INCLUDING TERRAZZO, METAL AND VINYL BASES IN "AREA OF WORK."

THRESHOLDS:

32. DEMOLITION CONTRACTOR TO REMOVE ALL EXISTING THRESHOLDS AT PARTITIONS AND DOORS TO BE REMOVED.

ADJACENT BUILDING PROTECTION NOTES

THE CONTRACTOR IS HEREBY MADE AWARE TO COMPLY WITH SITE PROTECTION AS PER CHAPTER 3300 OF THE 2022 NYCBC INCLUDING BUT NOT

LIMITED TO THE FOLLOWING:

- BC 3309.10 - PROTECTION OF ADJACENT ROOFS - BC 3309.11 - PROTECTION OF TREES

- BC 3309.12 - PROTECTION OF CHIMNEYS - BC 3309.13 - PROTECTION OF ADJOINING EQUIPMENT

AND SPACES - BC 3309.14 - PROTECTION OF WINDOWS



515 Broadway, Albany, New York, 12207-2964 One Penn Plaza, 52 Floor, NY, NY 10119-0098

539 Franklin Street, Buffalo, NY 14202-1109
WWW.DASNY.ORG

THESE DOCUMENTS CONTAIN POTENTIALLY SENSITIVE INFORMATION AND SHALL B
USED FOR THEIR INTENDED PURPOSE. ONCE THE INTENDED PURPOSE HAS CEASED,
THE DOCUMENTS SHALL BE DESTROYED IN A SECURE MANNER.

IT IS A VIOLATION OF STATE EDUCATION LAW FOR ANY PERSON. UNLESS UNDER TH

DIRECTION OF A LICENSED ARCHITECT / ENGINEER TO ALTER THIS DOCUMENT IN ANY WAY. ALTERATIONS MUST HAVE THE SEAL AFFIXED ALONG WITH A DESCRIPTIO OF THE ALTERATIONS, DATE AND ARCHITECT'S / ENGINEER'S SIGNATURE. COPYRIGH © 2015.


Consultants

CURTIS + GINSBERG

Curtis + ARCHITECTS
ONE BATTERY PARK PLAZA,
Ginsberg FL 27
Architects NEW YORK, NEW YORK 10004
212.929.4417

Merritt Engineering
28-08 Bayside Lane, Queens, NY 11358

The LiRo Group
235 East Jericho Turnpike, Mineola, NY 11501

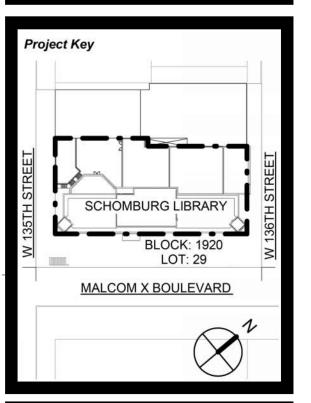

REVISIONS		
Rev No	Description	Date:
<u> </u>		
<u>2</u>		
3		
4		
<u>/5</u>		
<u>6</u>		
<u> </u>		
<u>8</u>		
<u> \(\sqrt{ 9} \) \</u>		

476 FIFTH AVENUE
NEW YORK, NY 10018


Project Title
NYPL SCHOMBURG
ENVELOPE RESTORATION
515 MALCOLM X BLVD
NEW YORK, NY 10037


Drawing Title
DEMOLITION
NOTES

Phase
90% CD SUBMISSION


Drawn By: Checked By: Date:


Seal & Signature:

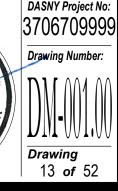

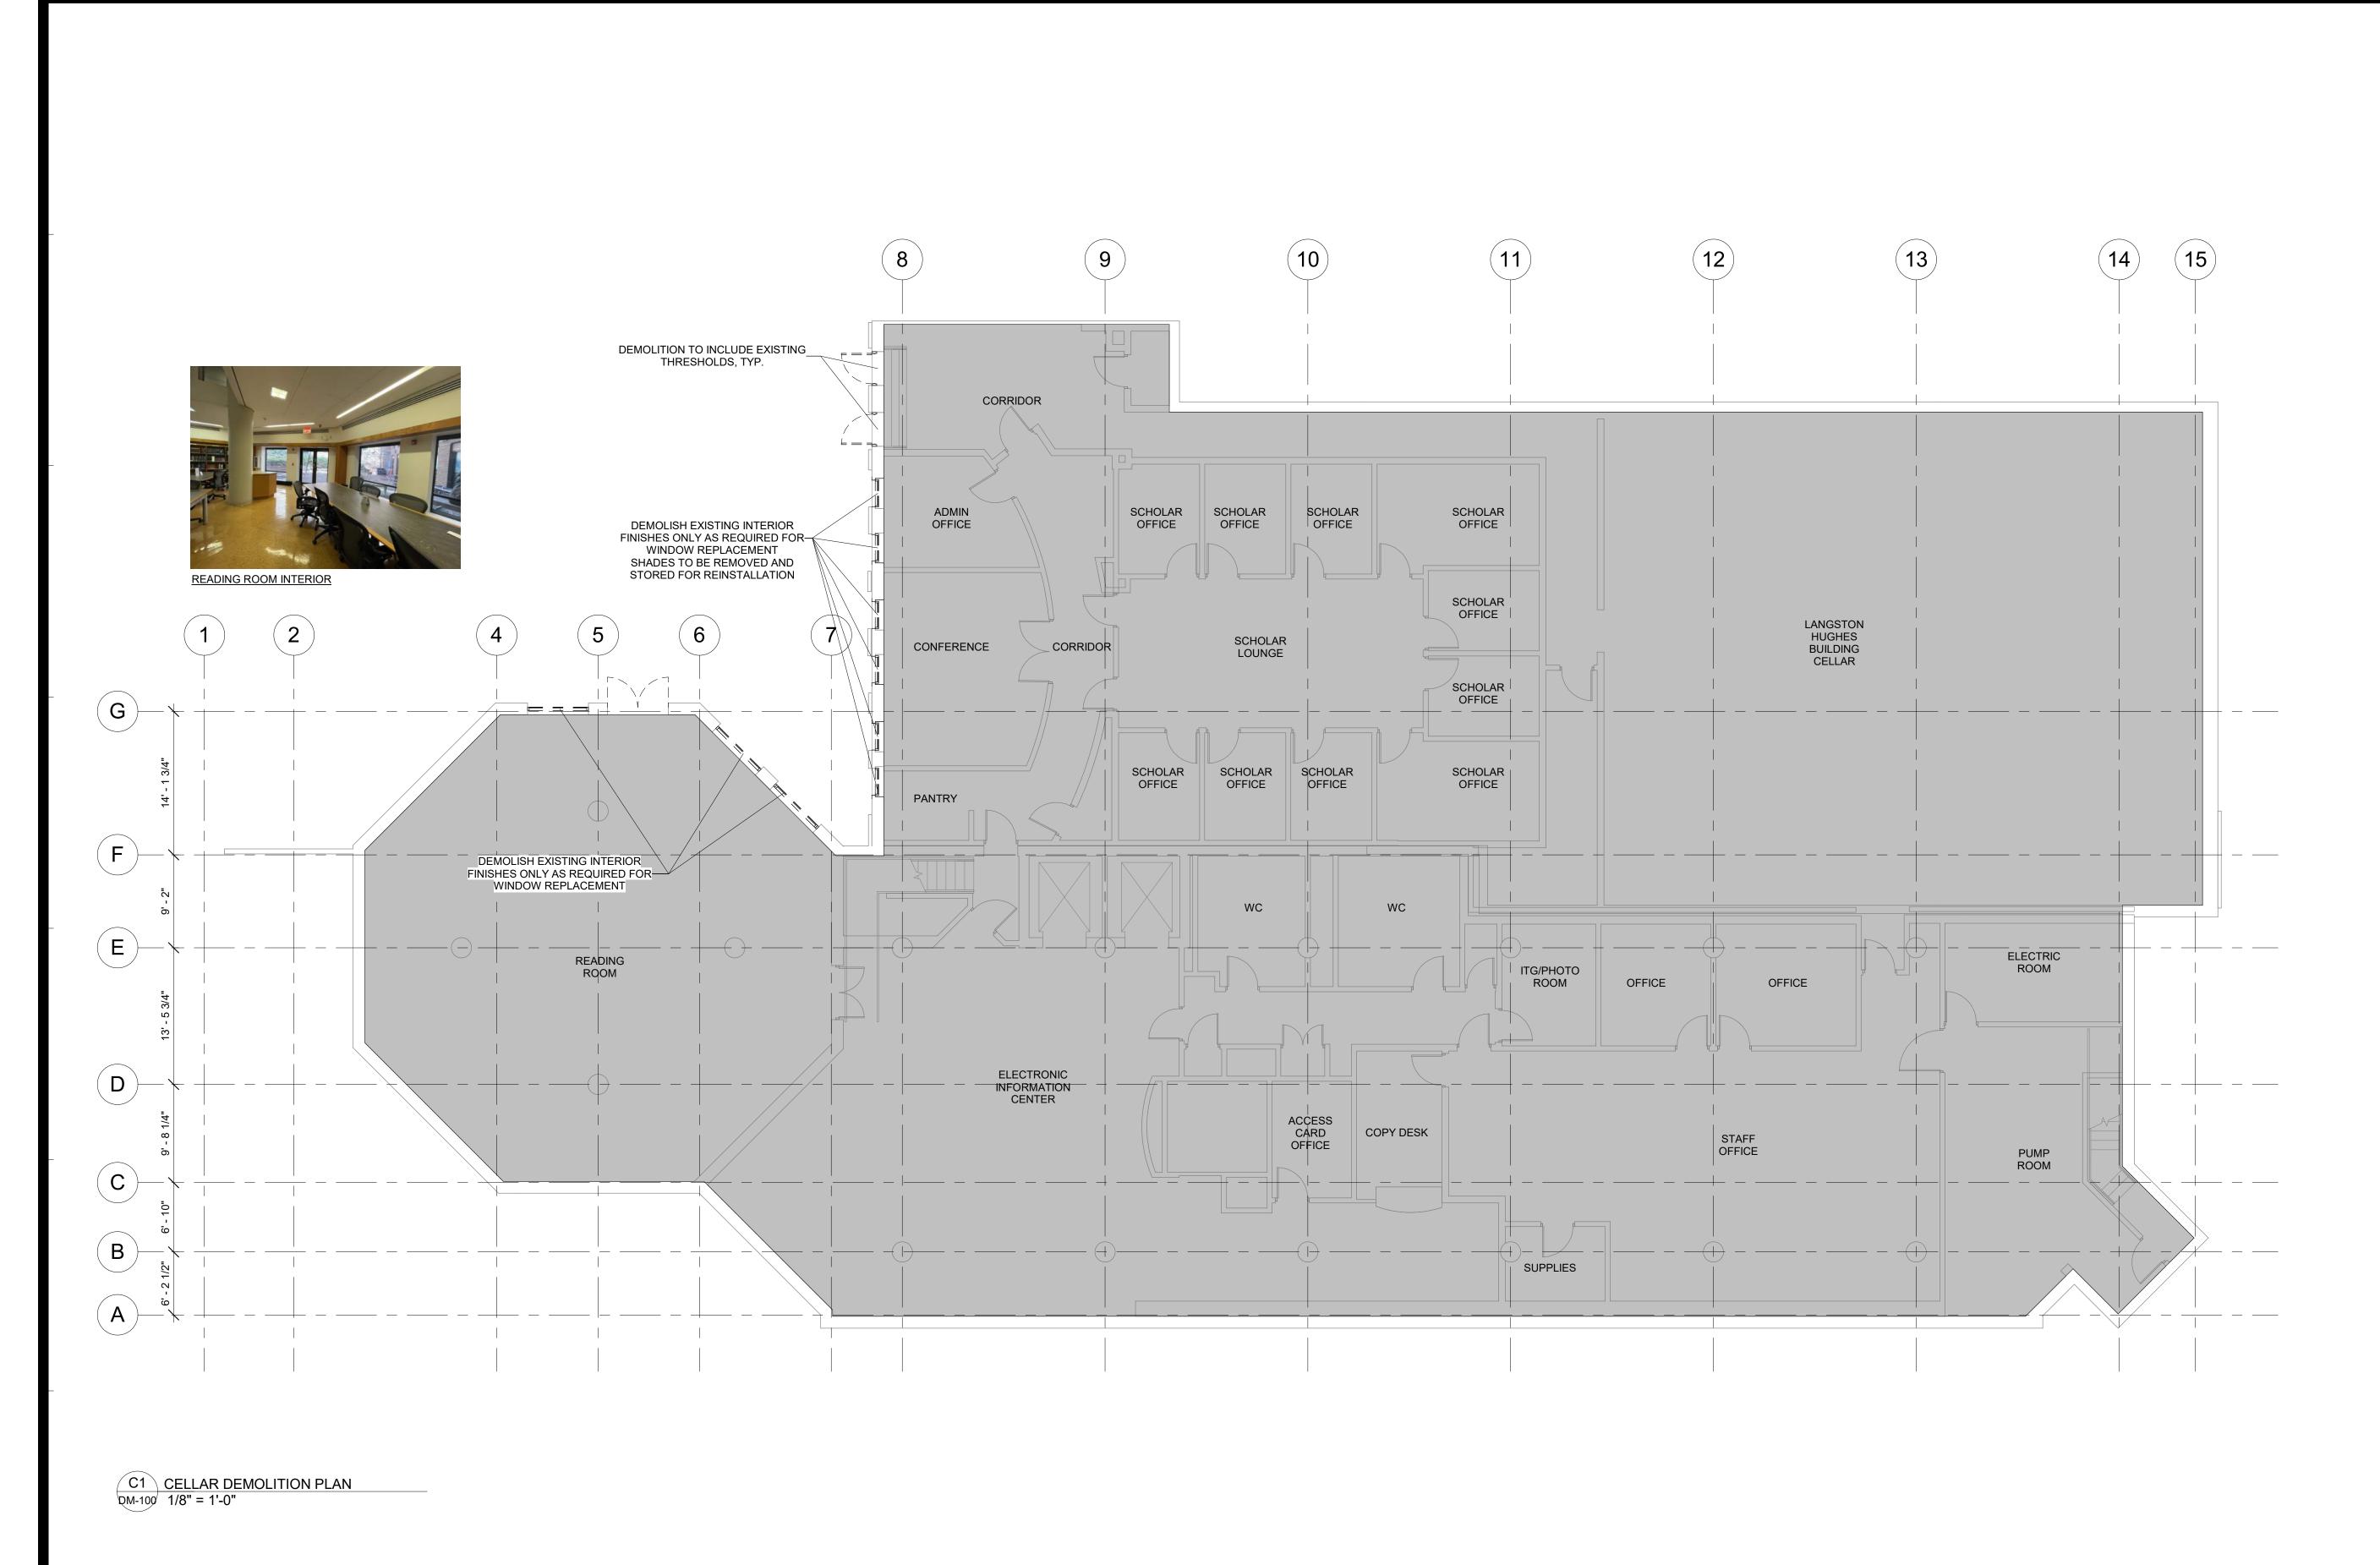

MOLITION GENERAL NOTES:	DEMOLITION LEGEND:	DOB AP	B APPROVAL STAM
ELEMENTS SHOWN TO BE REMOVED ARE ASSUMED TO BE NON BEARING. STRUCTURAL NEER TO CONFIRM PRIOR TO REMOVAL OPERATIONS.	EXISTING CONSTRUCTION TO BE DEMOLISHED		
STING ELEMENTS NOT SHOWN TO BE REMOVED, INCLUDING, BUT NOT LIMITED TO, COLUMNS, RING WALLS, SLABS, CHASE WALLS, AND MECHANICAL SHAFTS TO BE THOROUGHLY PROTECTED ING REMOVAL OPERATIONS.	EXISTING DOOR TO BE REMOVED		
O NOTIFY STRUCTURAL ENGINEER IF ANY EXISTING STEEL STRUCTURAL BEAMS AND COLUMNS SED DURING CONSTRUCTION ARE FOUND IN POOR CONDITIONBEARING MASONRY WALLS TO REMAIN ARE TO BE TEMPORARILY SUPPORTED FOLLOWING	EXISTING WALL TO REMAIN		
VAL OF ADJACENT WALLS UNTIL PERMANENT SUPPORT IS INSTALLED. CH AND REPAIR SURROUNDING WALLS, CEILINGS, AND FLOORS WHERE DAMAGED BY LITION OPERATIONS, TO MATCH EXISTING.	EXISTING DOOR TO REMAIN		
NG COLUMN AND BEAM FIREPROOFING DAMAGED DURING REMOVAL OPERATIONS TO BE RED AND RESTORED TO MEET REQUIRED RATINGS BY THE GC AT NO ADDITIONAL COST.	PROPERTY LINE		
	EXISTING ROOFING MEMBRANE AND INSULATION TO BE REMOVED	SCALE: NTS	
	N.I.C. TYP.	PLANS REFLECT EXISTING CONDITIONS UNLESS OTHERWISE NOTED. ALL DIMENSIONS TO BE VERIFIED IN FIELD.	

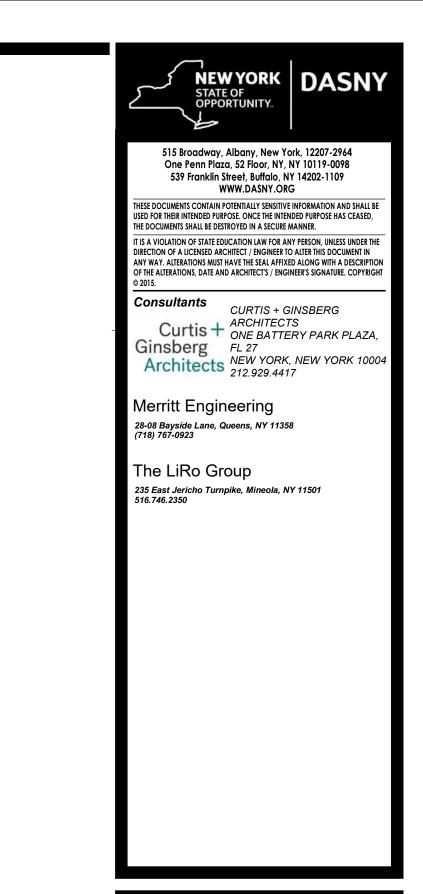


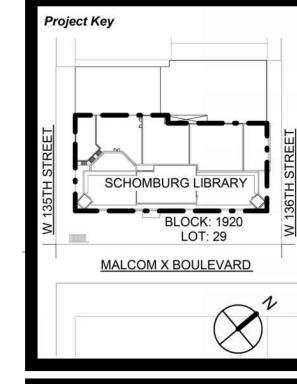

Rev No	Description	Date:
<u>1</u>		
${2}$		
<u>3</u>		
4		
<u> </u>		
6		
<u> </u>		
<u>8</u>		
${9}$		





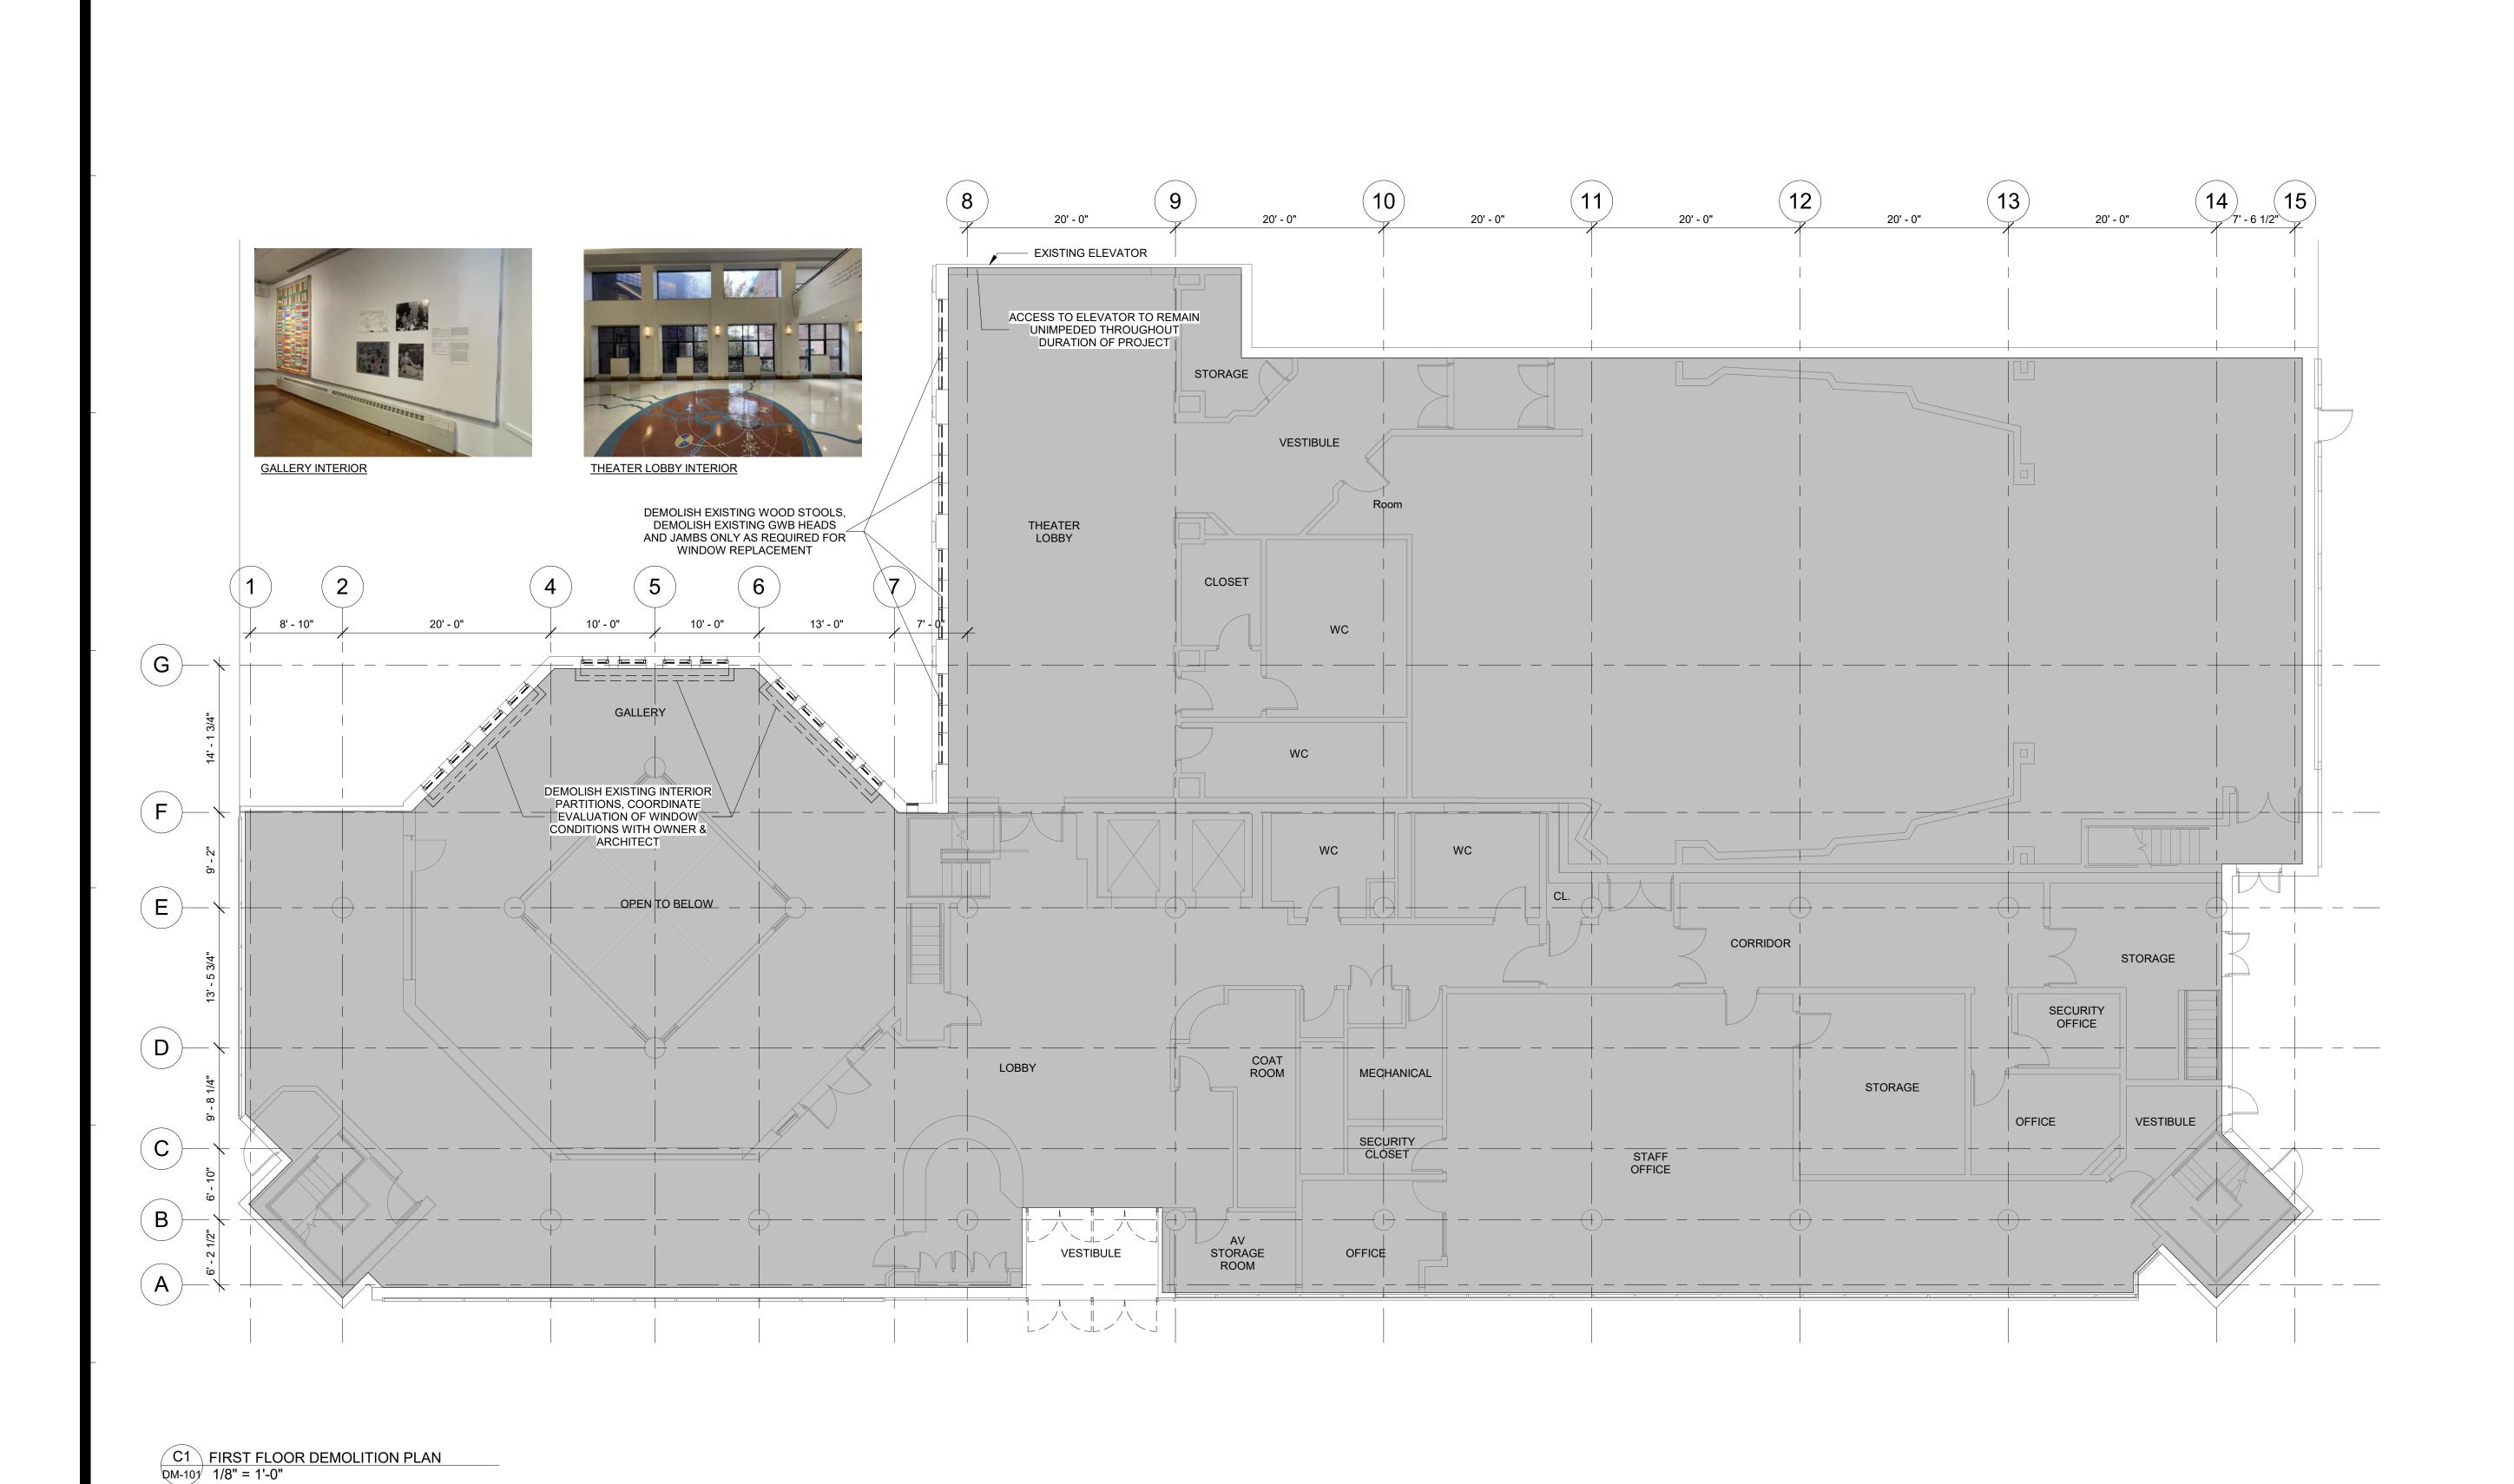



DEMOLITION GENERAL NOTES: DEMOLITION LEGEND: . ALL ELEMENTS SHOWN TO BE REMOVED ARE ASSUMED TO BE NON BEARING. STRUCTURAL ENGINEER TO CONFIRM PRIOR TO REMOVAL OPERATIONS. 2. EXISTING ELEMENTS NOT SHOWN TO BE REMOVED, INCLUDING, BUT NOT LIMITED TO, COLUMNS, BEARING WALLS, SLABS, CHASE WALLS, AND MECHANICAL SHAFTS TO BE THOROUGHLY PROTECTED DURING REMOVAL OPERATIONS. 3. GC TO NOTIFY STRUCTURAL ENGINEER IF ANY EXISTING STEEL STRUCTURAL BEAMS AND COLUMNS

EXPOSED DURING CONSTRUCTION ARE FOUND IN POOR CONDITION. 4. NON-BEARING MASONRY WALLS TO REMAIN ARE TO BE TEMPORARILY SUPPORTED FOLLOWING REMOVAL OF ADJACENT WALLS UNTIL PERMANENT SUPPORT IS INSTALLED. 5. PATCH AND REPAIR SURROUNDING WALLS, CEILINGS, AND FLOORS WHERE DAMAGED BY DEMOLITION OPERATIONS, TO MATCH EXISTING.


6. EXISTING COLUMN AND BEAM FIREPROOFING DAMAGED DURING REMOVAL OPERATIONS TO BE REPAIRED AND RESTORED TO MEET REQUIRED RATINGS BY THE GC AT NO ADDITIONAL COST.

	EXISTING CONSTRUCTION TO BE DEMOLISHED	
¶	EXISTING DOOR TO BE REMOVED	
	EXISTING WALL TO REMAIN	
	EXISTING DOOR TO REMAIN	
	PROPERTY LINE	
	EXISTING ROOFING MEMBRANE AND INSULATION TO BE REMOVED	SCALE:
	N.I.C. TYP.	PLANS REFLECT EXISTING CONDITIONS UNLESS OTHERWISE NOTED. ALL DIMENSIONS TO BE VERIFIED IN FIELD.

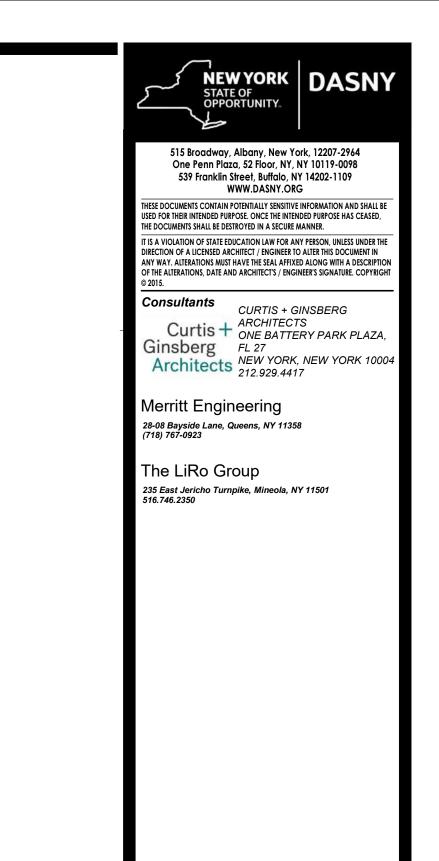


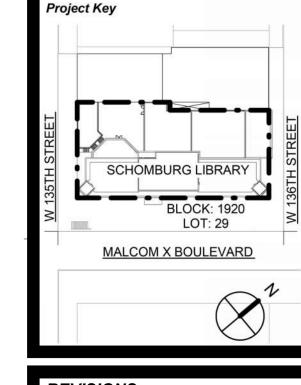


REVISIONS		
Rev No	Description	Date:
1		
2		
<u>3</u>		
<u>4</u>		
<u></u> <u>5</u>		
<u>6</u>		
<u> </u>		
<u>8</u>		
<u> \lambda </u>		

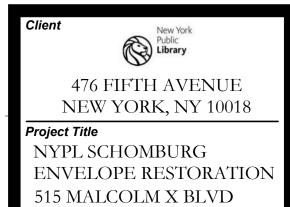


NEW YORK, NY 10037

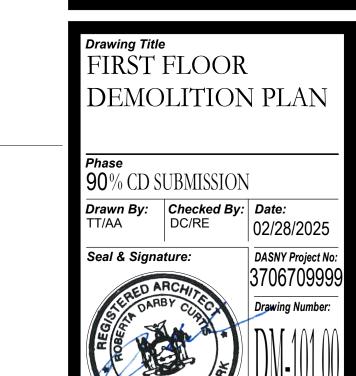


SCALE: NTS

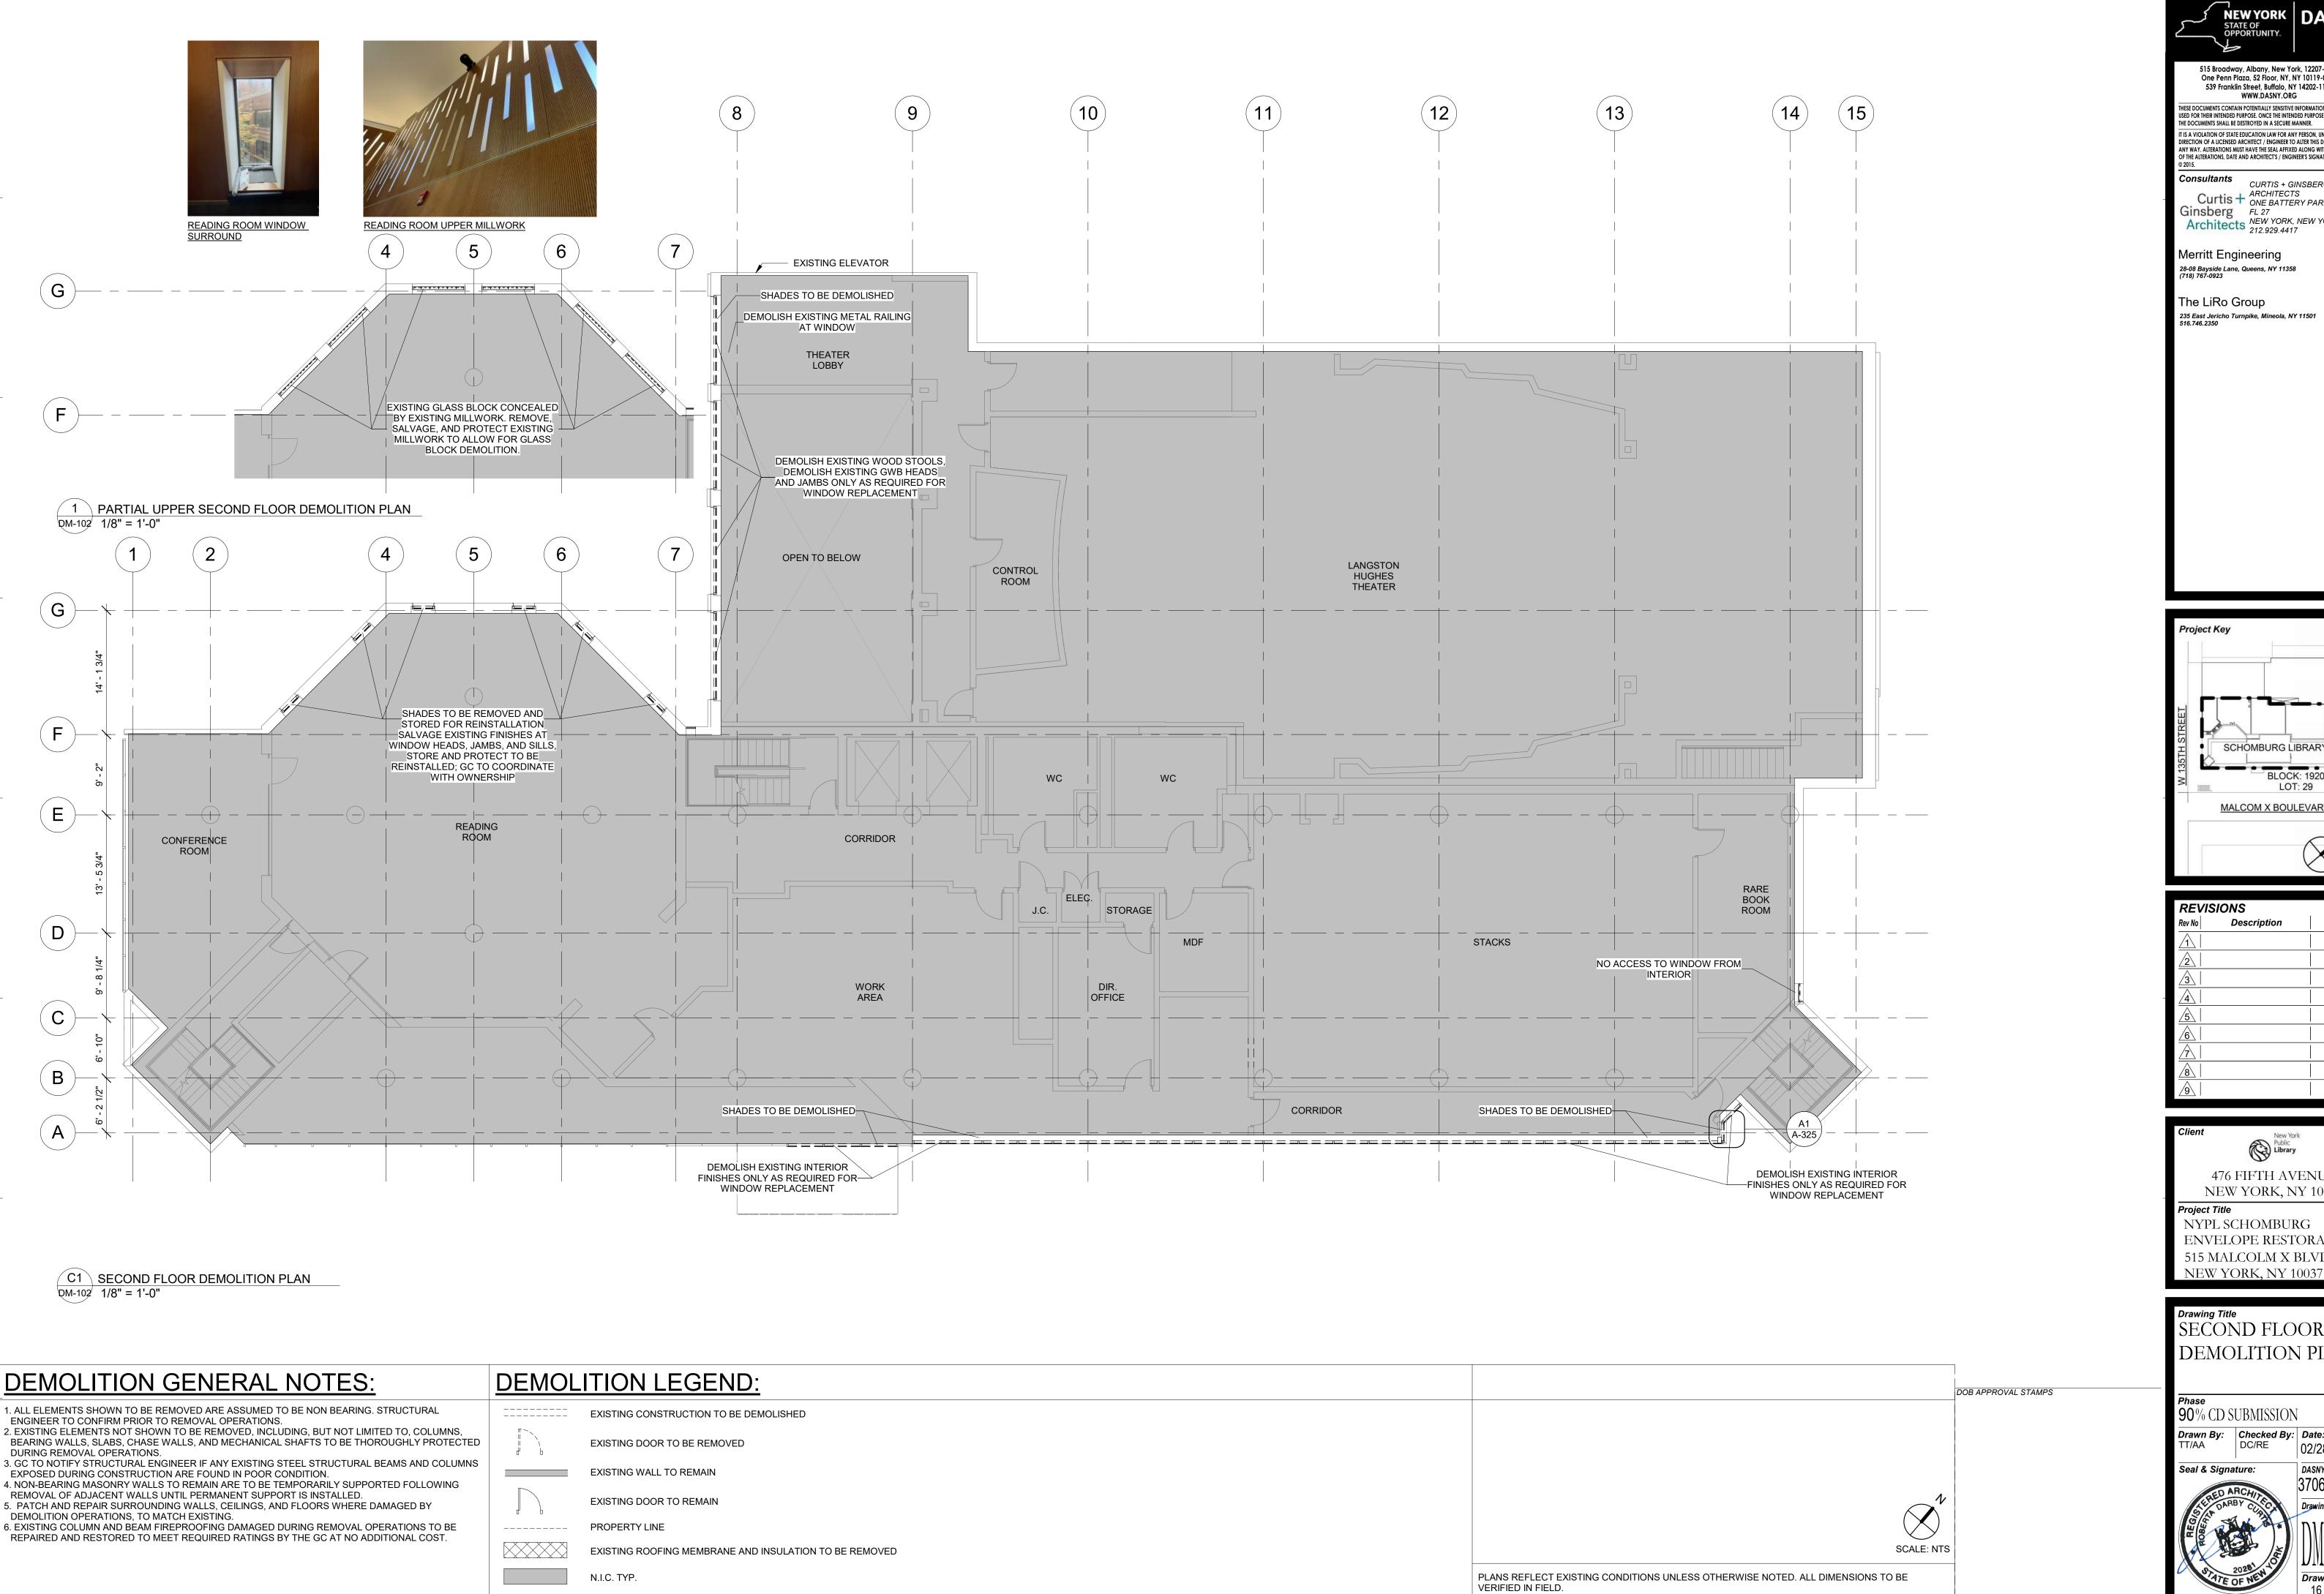

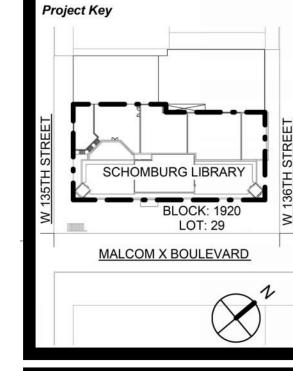


REVISIONS		
Rev No	Description	Date:
<u> </u>		
2		
<u>3</u>		
<u>4</u>		
<u></u> <u>5</u>		
<u>6</u>		
<u> </u>		
<u>8</u>		
<u>\\ \\ \</u>		

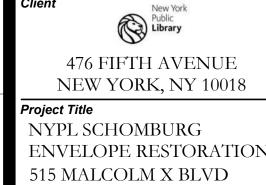



Seal & Signature:

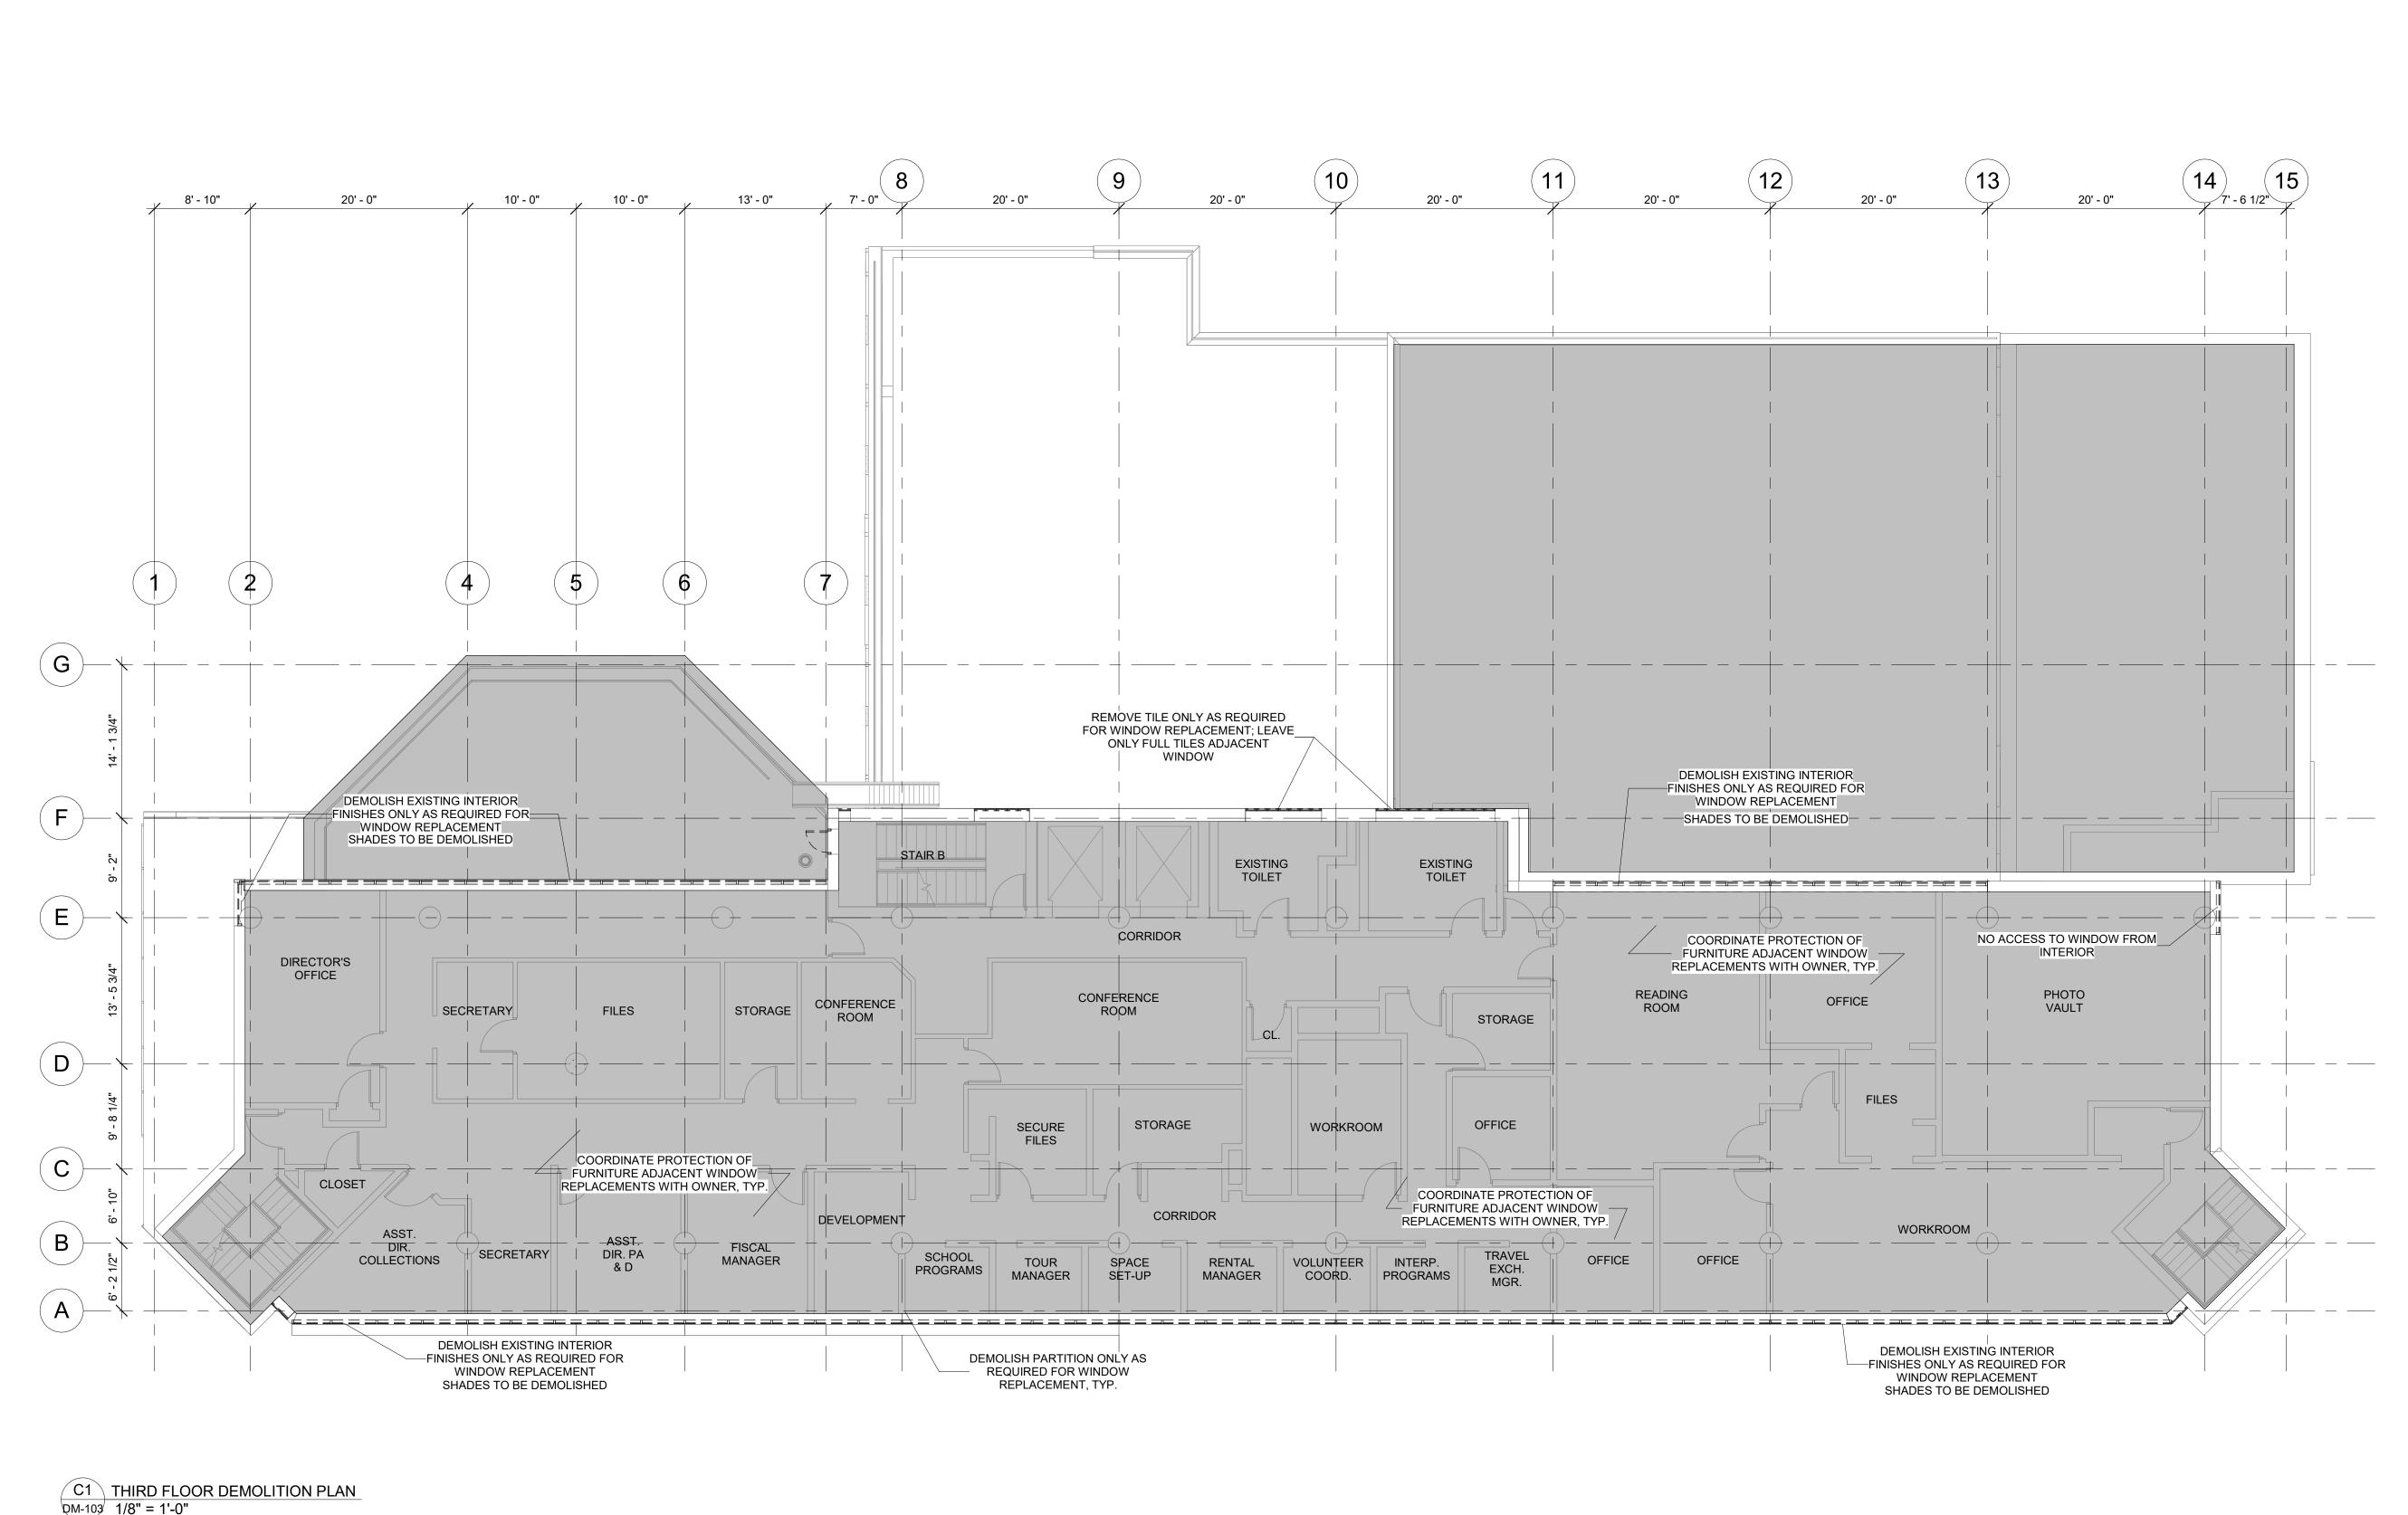

QM-103 1/8" = 1'-0"

DEMOLITION GENERAL NOTES:	<u>DEMC</u>
1. ALL ELEMENTS SHOWN TO BE REMOVED ARE ASSUMED TO BE NON BEARING. STRUCTURAL ENGINEER TO CONFIRM PRIOR TO REMOVAL OPERATIONS. 2. EXISTING ELEMENTS NOT SHOWN TO BE REMOVED, INCLUDING, BUT NOT LIMITED TO, COLUMNS, BEARING WALLS, SLABS, CHASE WALLS, AND MECHANICAL SHAFTS TO BE THOROUGHLY PROTECTED DURING REMOVAL OPERATIONS. 3. GC TO NOTIFY STRUCTURAL ENGINEER IF ANY EXISTING STEEL STRUCTURAL BEAMS AND COLUMNS EXPOSED DURING CONSTRUCTION ARE FOUND IN POOR CONDITION.	

. NON-BEARING MASONRY WALLS TO REMAIN ARE TO BE TEMPORARILY SUPPORTED FOLLOWING REMOVAL OF ADJACENT WALLS UNTIL PERMANENT SUPPORT IS INSTALLED. 5. PATCH AND REPAIR SURROUNDING WALLS, CEILINGS, AND FLOORS WHERE DAMAGED BY DEMOLITION OPERATIONS, TO MATCH EXISTING. 6. EXISTING COLUMN AND BEAM FIREPROOFING DAMAGED DURING REMOVAL OPERATIONS TO BE


REPAIRED AND RESTORED TO MEET REQUIRED RATINGS BY THE GC AT NO ADDITIONAL COST.

DEMOLITION LEGEND: EXISTING CONSTRUCTION TO BE DEMOLISHED EXISTING DOOR TO BE REMOVED EXISTING WALL TO REMAIN


EXISTING DOOR TO REMAIN PROPERTY LINE

EXISTING ROOFING MEMBRANE AND INSULATION TO BE REMOVED PLANS REFLECT EXISTING CONDITIONS UNLESS OTHERWISE NOTED. ALL DIMENSIONS TO BE VERIFIED IN FIELD. N.I.C. TYP.



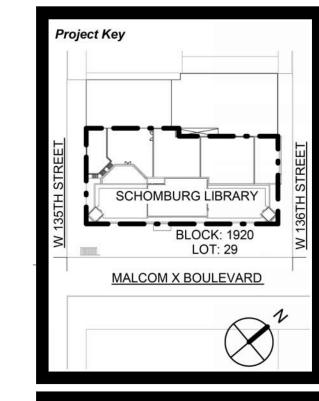


REVISIONS		
Rev No	Description	Date:
1		
<u>2</u>		
<u>3</u>		
4		
<u>\(\frac{1}{5} \) \</u>		
<u>6</u>		
<u> </u>		
<u>8</u>		
<u> \underset{9}\ </u>		

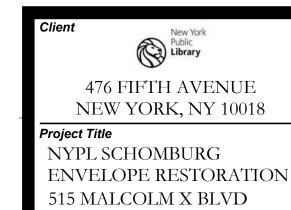





SCALE: NTS

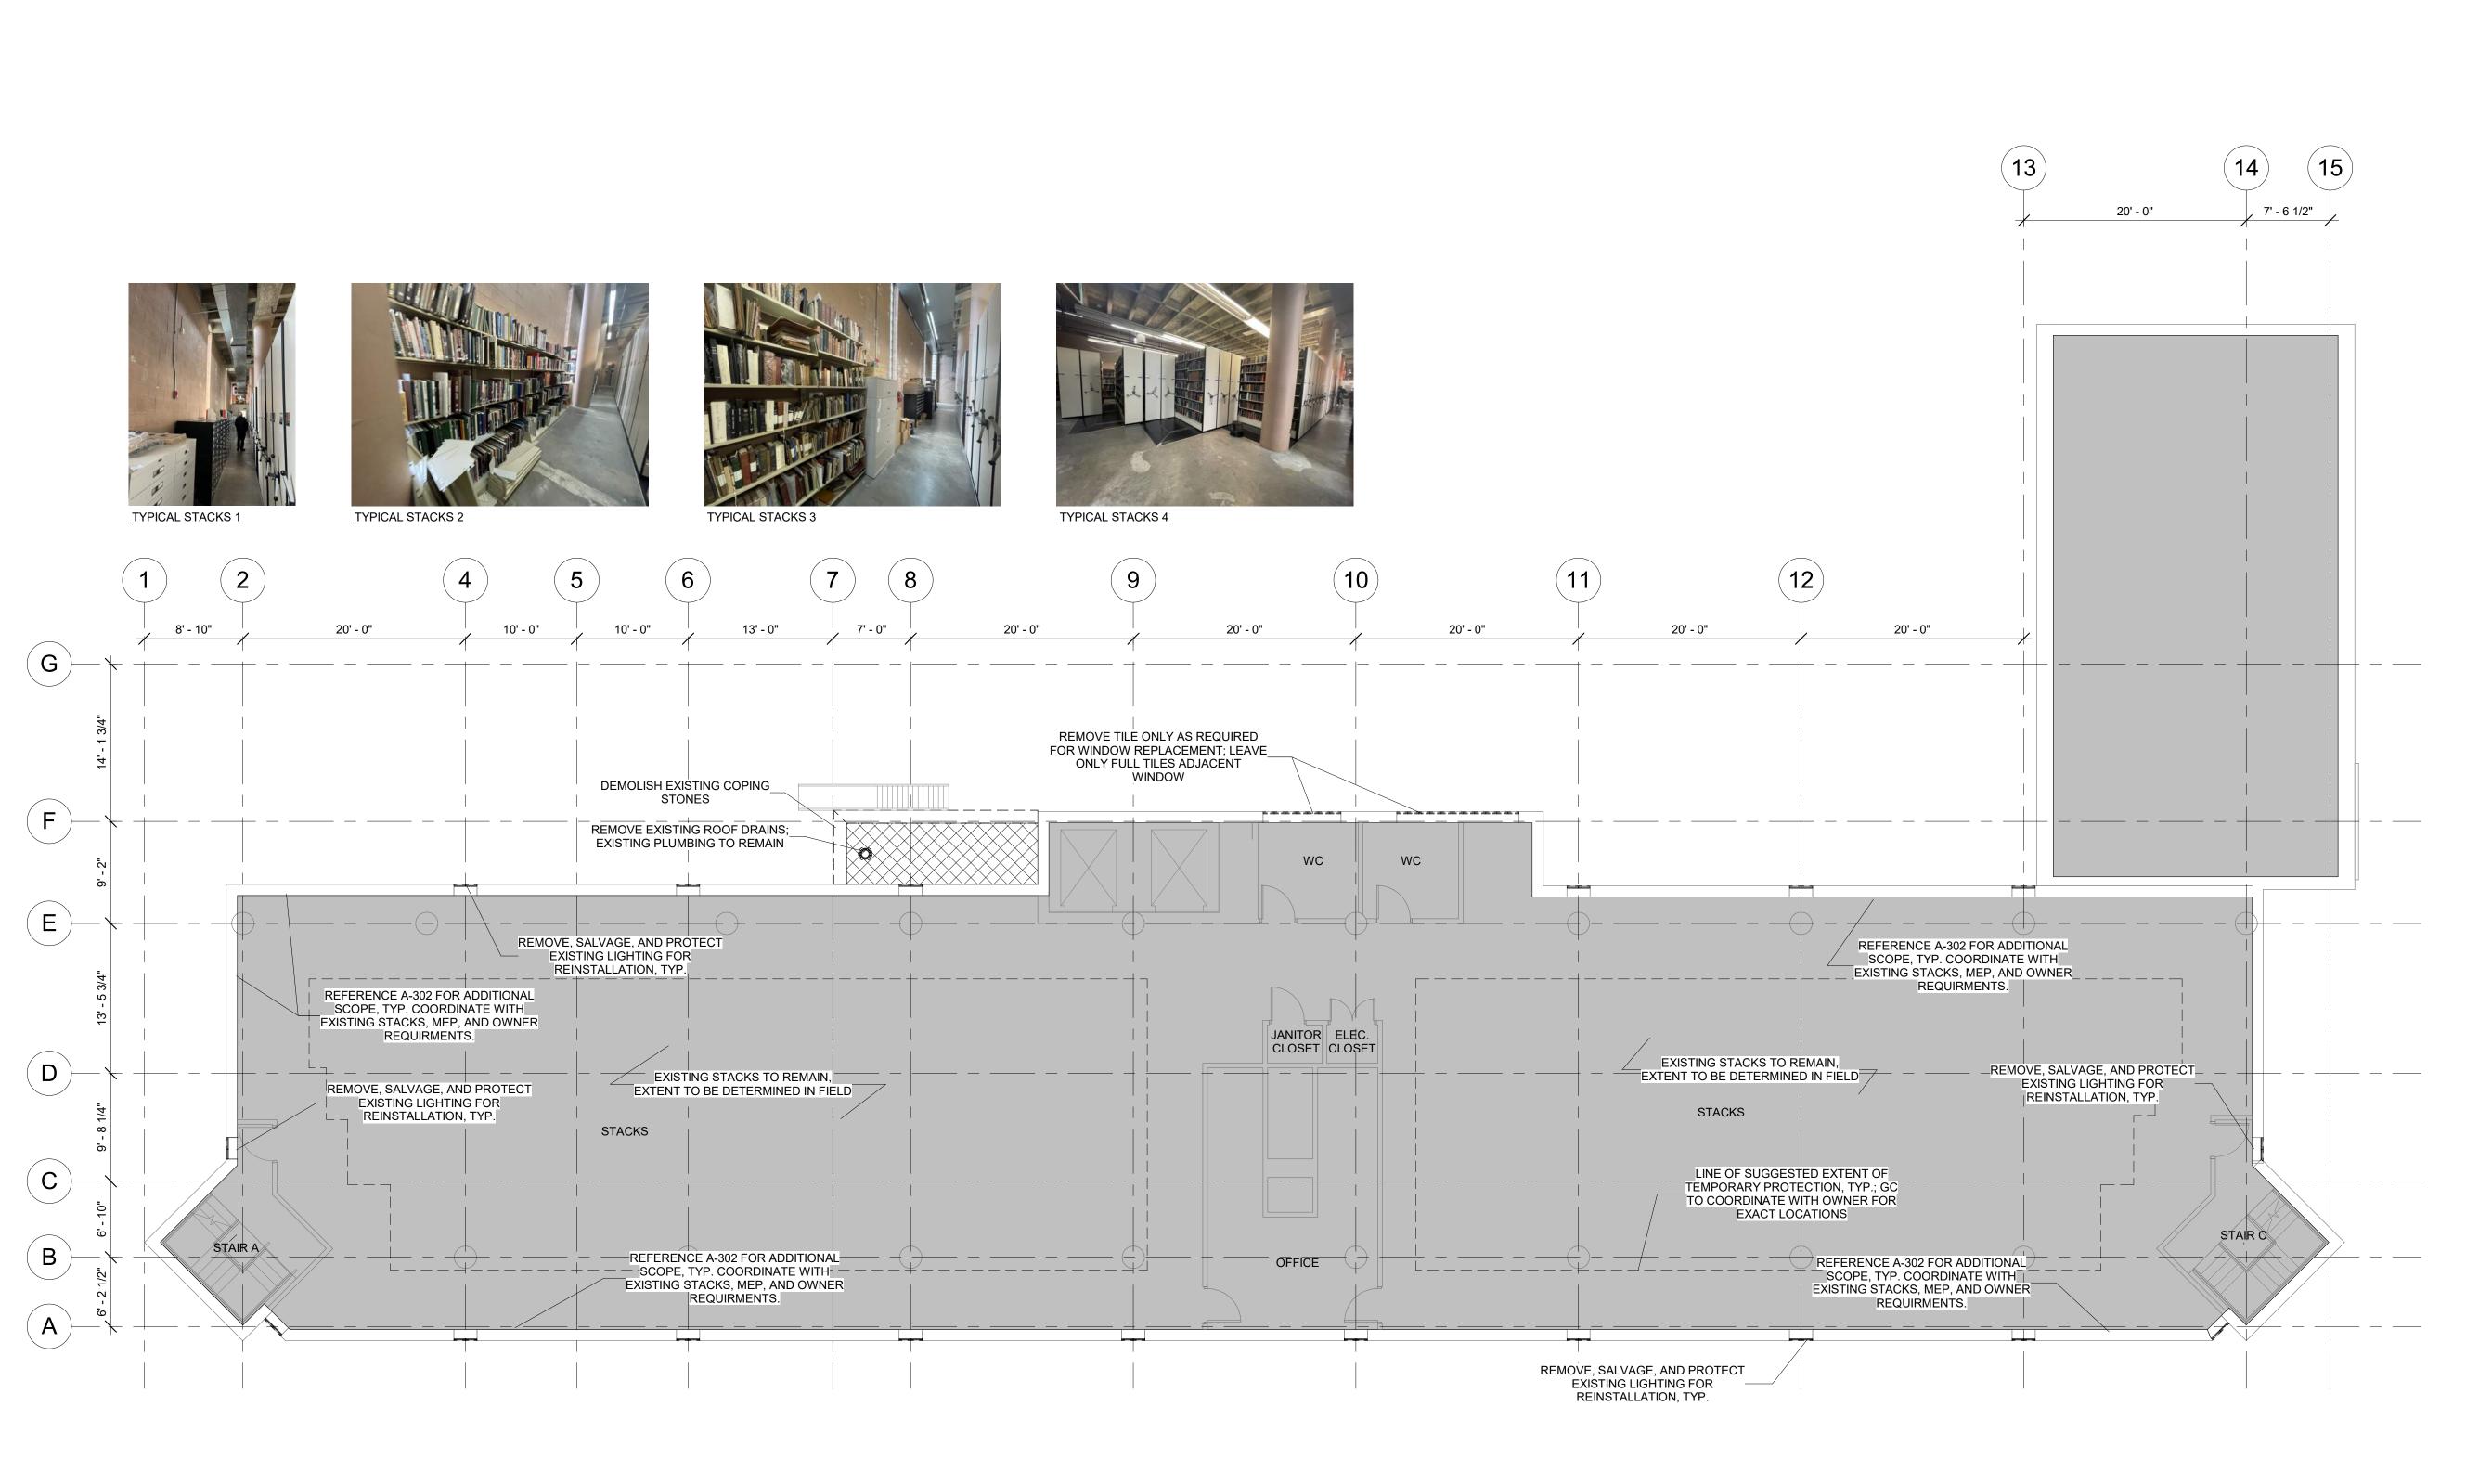



C1 FOURTH FLOOR DEMOLITION PLAN


DEMOLITION GENERAL NOTES: DEMOLITION LEGEND: DOB APPROVAL STAMPS . ALL ELEMENTS SHOWN TO BE REMOVED ARE ASSUMED TO BE NON BEARING. STRUCTURAL EXISTING CONSTRUCTION TO BE DEMOLISHED ENGINEER TO CONFIRM PRIOR TO REMOVAL OPERATIONS. 2. EXISTING ELEMENTS NOT SHOWN TO BE REMOVED, INCLUDING, BUT NOT LIMITED TO, COLUMNS, BEARING WALLS, SLABS, CHASE WALLS, AND MECHANICAL SHAFTS TO BE THOROUGHLY PROTECTED EXISTING DOOR TO BE REMOVED DURING REMOVAL OPERATIONS. 3. GC TO NOTIFY STRUCTURAL ENGINEER IF ANY EXISTING STEEL STRUCTURAL BEAMS AND COLUMNS EXISTING WALL TO REMAIN EXPOSED DURING CONSTRUCTION ARE FOUND IN POOR CONDITION. 4. NON-BEARING MASONRY WALLS TO REMAIN ARE TO BE TEMPORARILY SUPPORTED FOLLOWING REMOVAL OF ADJACENT WALLS UNTIL PERMANENT SUPPORT IS INSTALLED. EXISTING DOOR TO REMAIN 5. PATCH AND REPAIR SURROUNDING WALLS, CEILINGS, AND FLOORS WHERE DAMAGED BY DEMOLITION OPERATIONS, TO MATCH EXISTING. 6. EXISTING COLUMN AND BEAM FIREPROOFING DAMAGED DURING REMOVAL OPERATIONS TO BE PROPERTY LINE REPAIRED AND RESTORED TO MEET REQUIRED RATINGS BY THE GC AT NO ADDITIONAL COST. SCALE: NTS EXISTING ROOFING MEMBRANE AND INSULATION TO BE REMOVED PLANS REFLECT EXISTING CONDITIONS UNLESS OTHERWISE NOTED. ALL DIMENSIONS TO BE

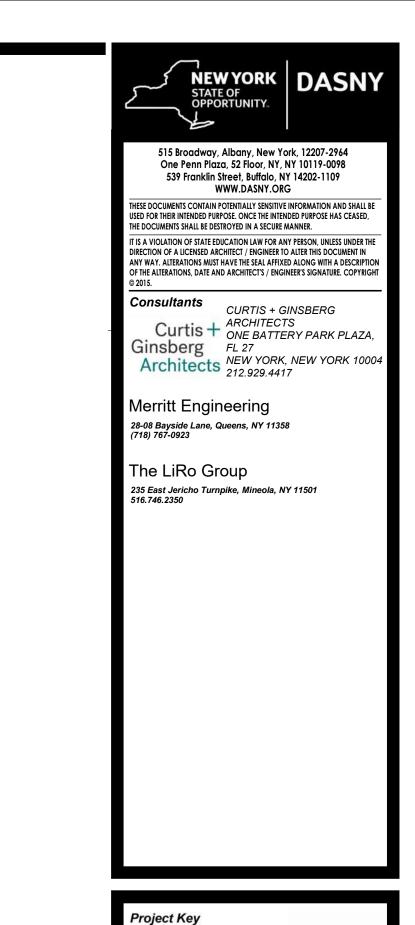

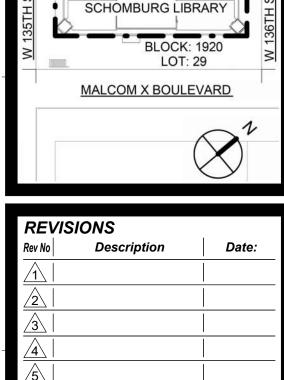


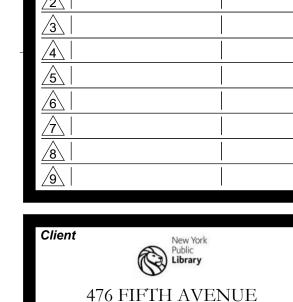

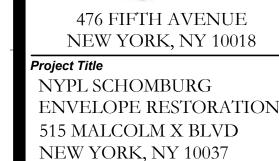

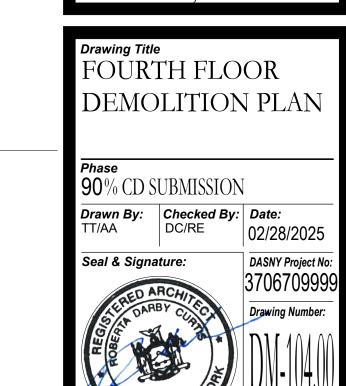

VERIFIED IN FIELD.

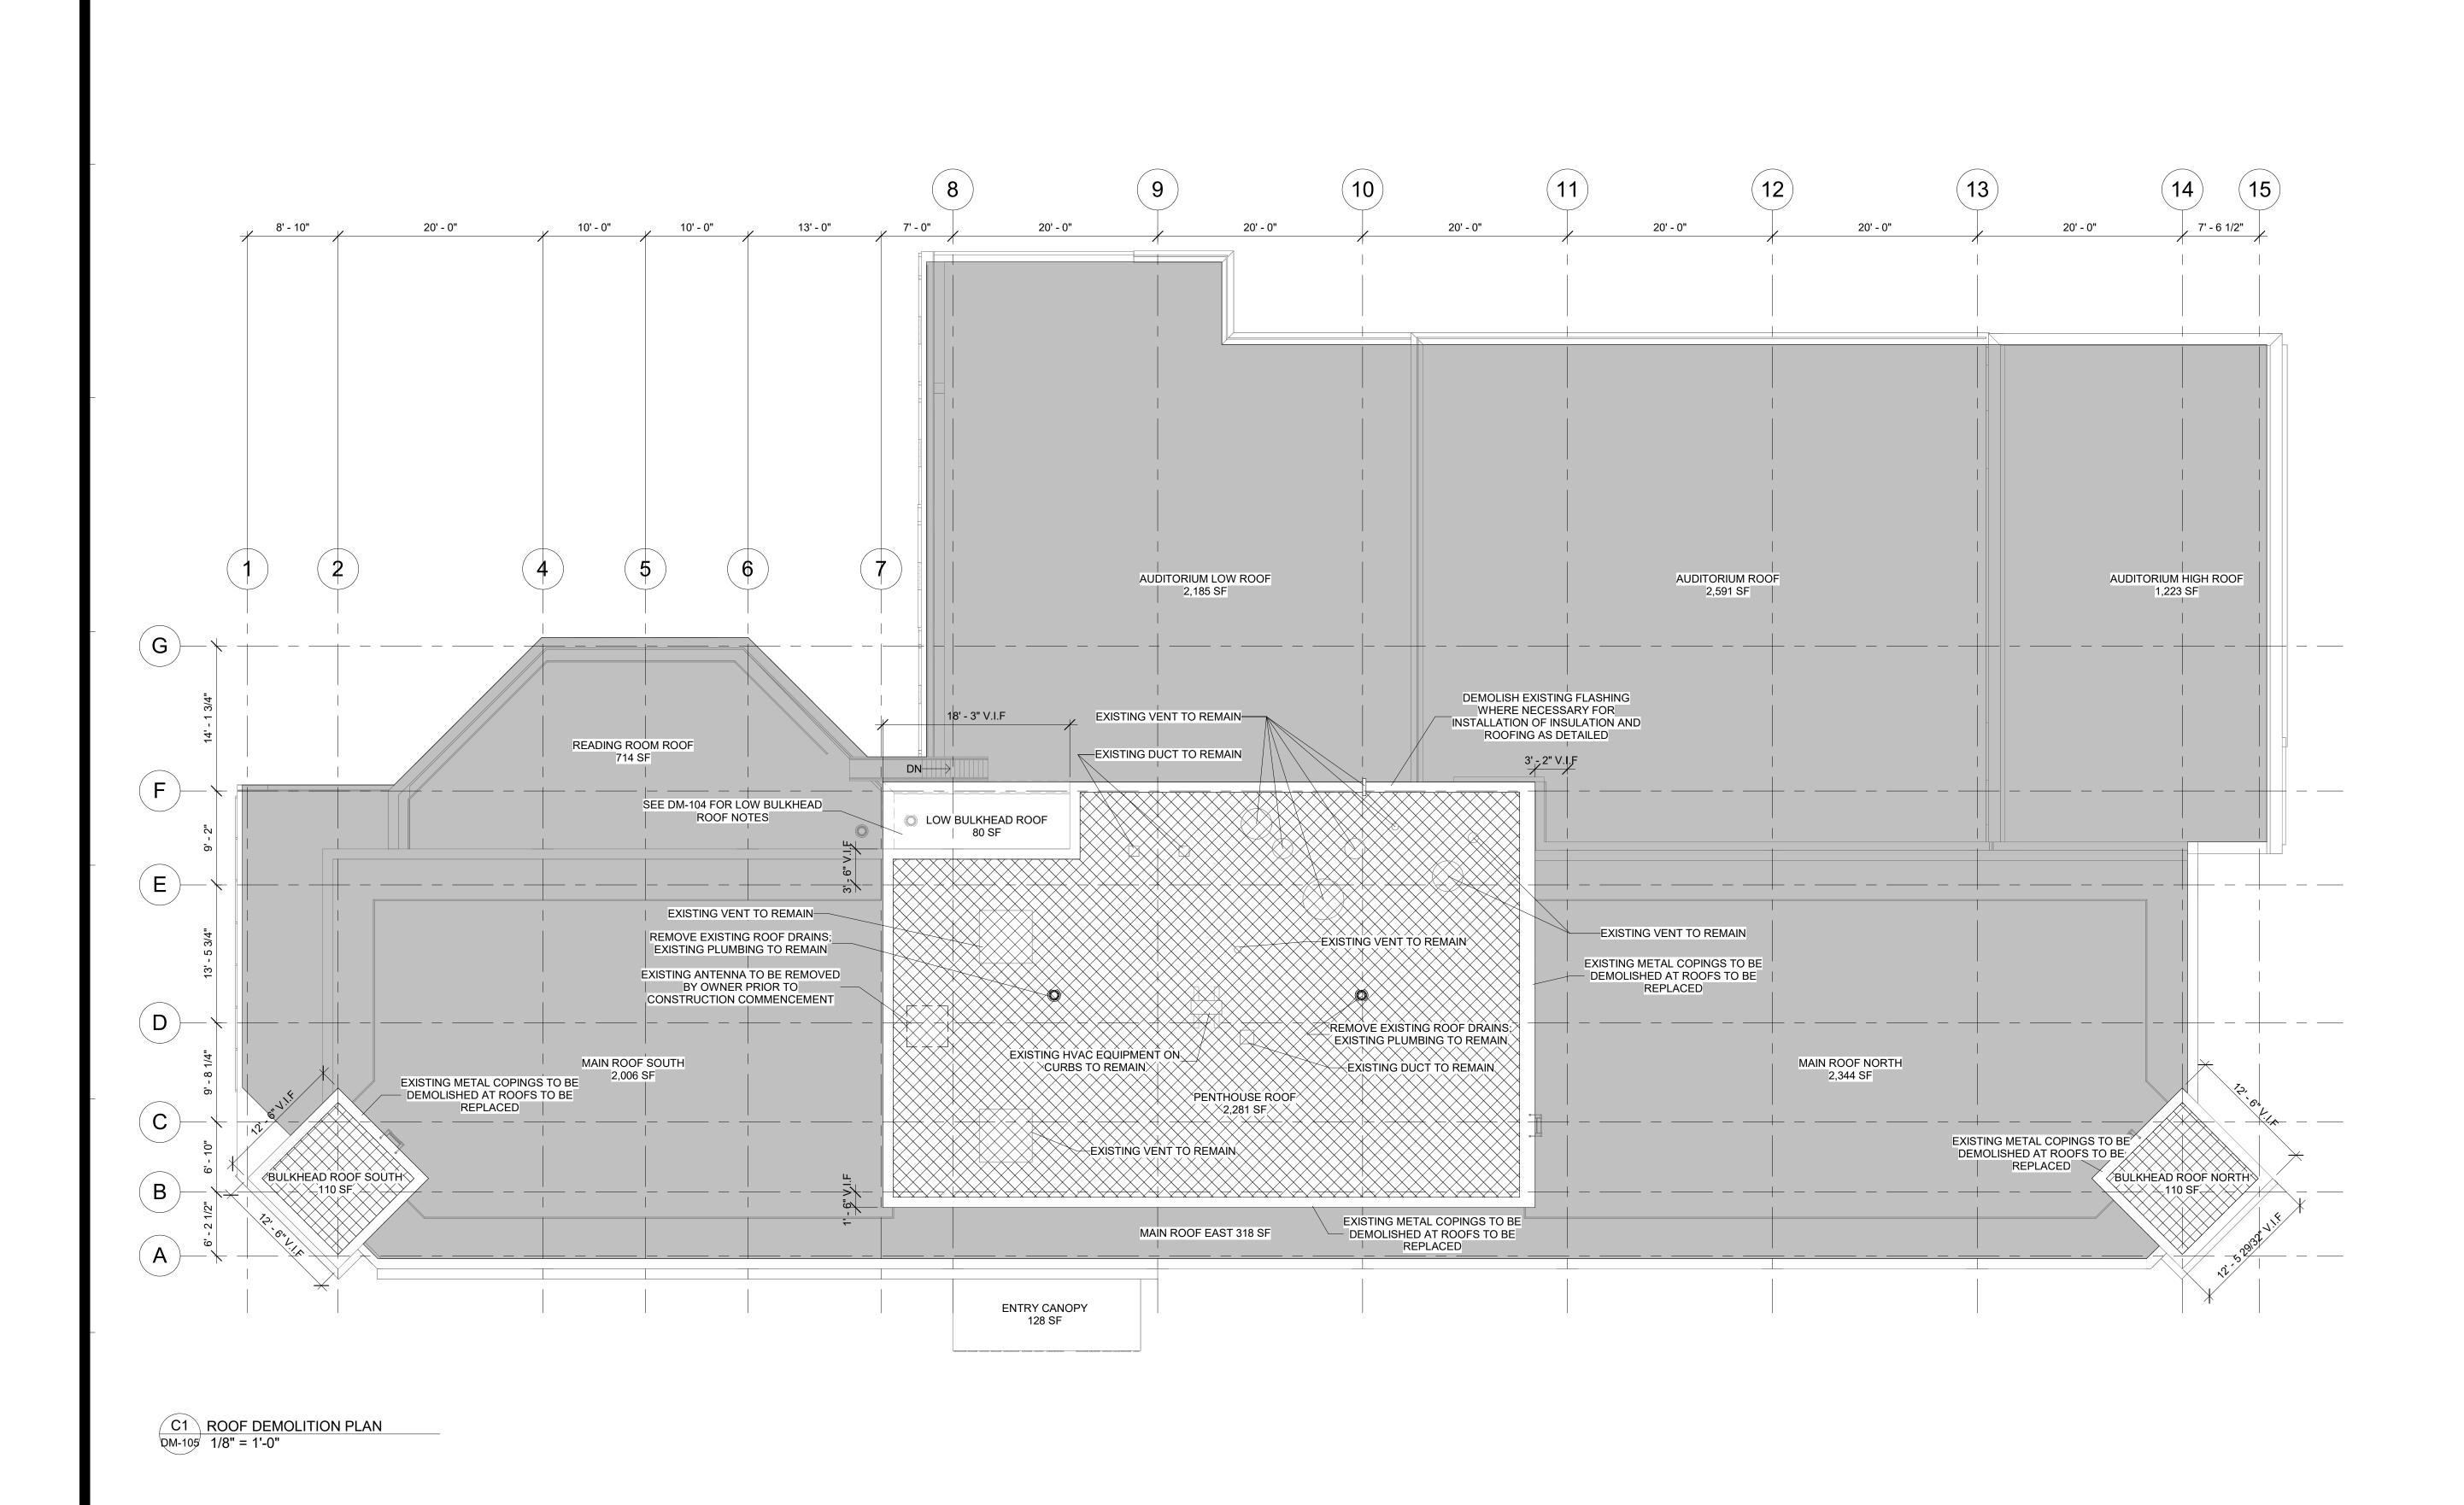


515 Broadway, Albany, New York, 12207-2964 One Penn Plaza, 52 Floor, NY, NY 10119-0098 539 Franklin Street, Buffalo, NY 14202-1109 WWW.DASNY.ORG IESE DOCUMENTS CONTAIN POTENTIALLY SENSITIVE INFORMATION AND SHALL BE USED FOR THEIR INTENDED PURPOSE. ONCE THE INTENDED PURPOSE HAS CEASED, THE DOCUMENTS SHALL BE DESTROYED IN A SECURE MANNER. IT IS A VIOLATION OF STATE EDUCATION LAW FOR ANY PERSON, UNLESS UNDER THE DIRECTION OF A LICENSED ARCHITECT / ENGINEER TO ALTER THIS DOCUMENT IN ANY WAY, ALTERATIONS MUST HAVE THE SEAL AFFIXED ALONG WITH A DESCRIPTION OF THE ALTERATIONS, DATE AND ARCHITECT'S / ENGINEER'S SIGNATURE. COPYRIGH Consultants CURTIS + GINSBERG Curtis + ARCHITECTS
ONE BATTERY PARK PLAZA, Ginsberg FL 27 Architects NEW YORK, NEW YORK 10004 Merritt Engineering 28-08 Bayside Lane, Queens, NY 11358 (718) 767-0923 The LiRo Group 235 East Jericho Turnpike, Mineola, NY 11501 516.746.2350 Project Key

REVIS		1
Rev No	Description	Date:
1		
2		
3\		
4		
<u></u> 5		
6		
<u> </u>		
8		
9\		

SCHOMBURG LIBRARY

MALCOM X BOULEVARD

BLOCK: 1920 LOT: 29

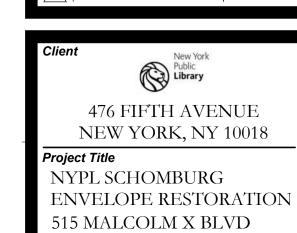

NEW YORK, NY 10037




ALL ELEMENTS SHOWN TO BE REMOVED ARE ASSUMED TO BE NON BEARING. STRUCTURAL ENGINEER TO CONFIRM PRIOR TO REMOVAL OPERATIONS.
 EXISTING ELEMENTS NOT SHOWN TO BE REMOVED, INCLUDING, BUT NOT LIMITED TO, COLUMNS, BEARING WALLS, SLABS, CHASE WALLS, AND MECHANICAL SHAFTS TO BE THOROUGHLY PROTECTED DURING REMOVAL OPERATIONS.
 GC TO NOTIFY STRUCTURAL ENGINEER IF ANY EXISTING STEEL STRUCTURAL BEAMS AND COLUMNS

DEMOLITION GENERAL NOTES:


GC TO NOTIFY STRUCTURAL ENGINEER IF ANY EXISTING STEEL STRUCTURAL BEAMS AND COLUMN
EXPOSED DURING CONSTRUCTION ARE FOUND IN POOR CONDITION.
 NON-BEARING MASONRY WALLS TO REMAIN ARE TO BE TEMPORARILY SUPPORTED FOLLOWING
REMOVAL OF ADJACENT WALLS UNTIL PERMANENT SUPPORT IS INSTALLED.
 PATCH AND REPAIR SURROUNDING WALLS, CEILINGS, AND FLOORS WHERE DAMAGED BY

DEMOLITION OPERATIONS, TO MATCH EXISTING.
6. EXISTING COLUMN AND BEAM FIREPROOFING DAMAGED DURING REMOVAL OPERATIONS TO BE REPAIRED AND RESTORED TO MEET REQUIRED RATINGS BY THE GC AT NO ADDITIONAL COST.

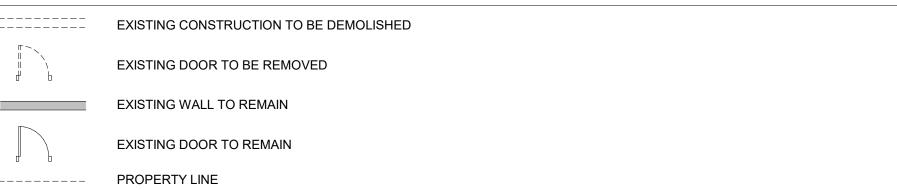

EXISTING ROOFING MEMBRANE AND INSULATION TO BE REMOVED

SCALE, NIS		SCALE: NTS
------------	--	------------

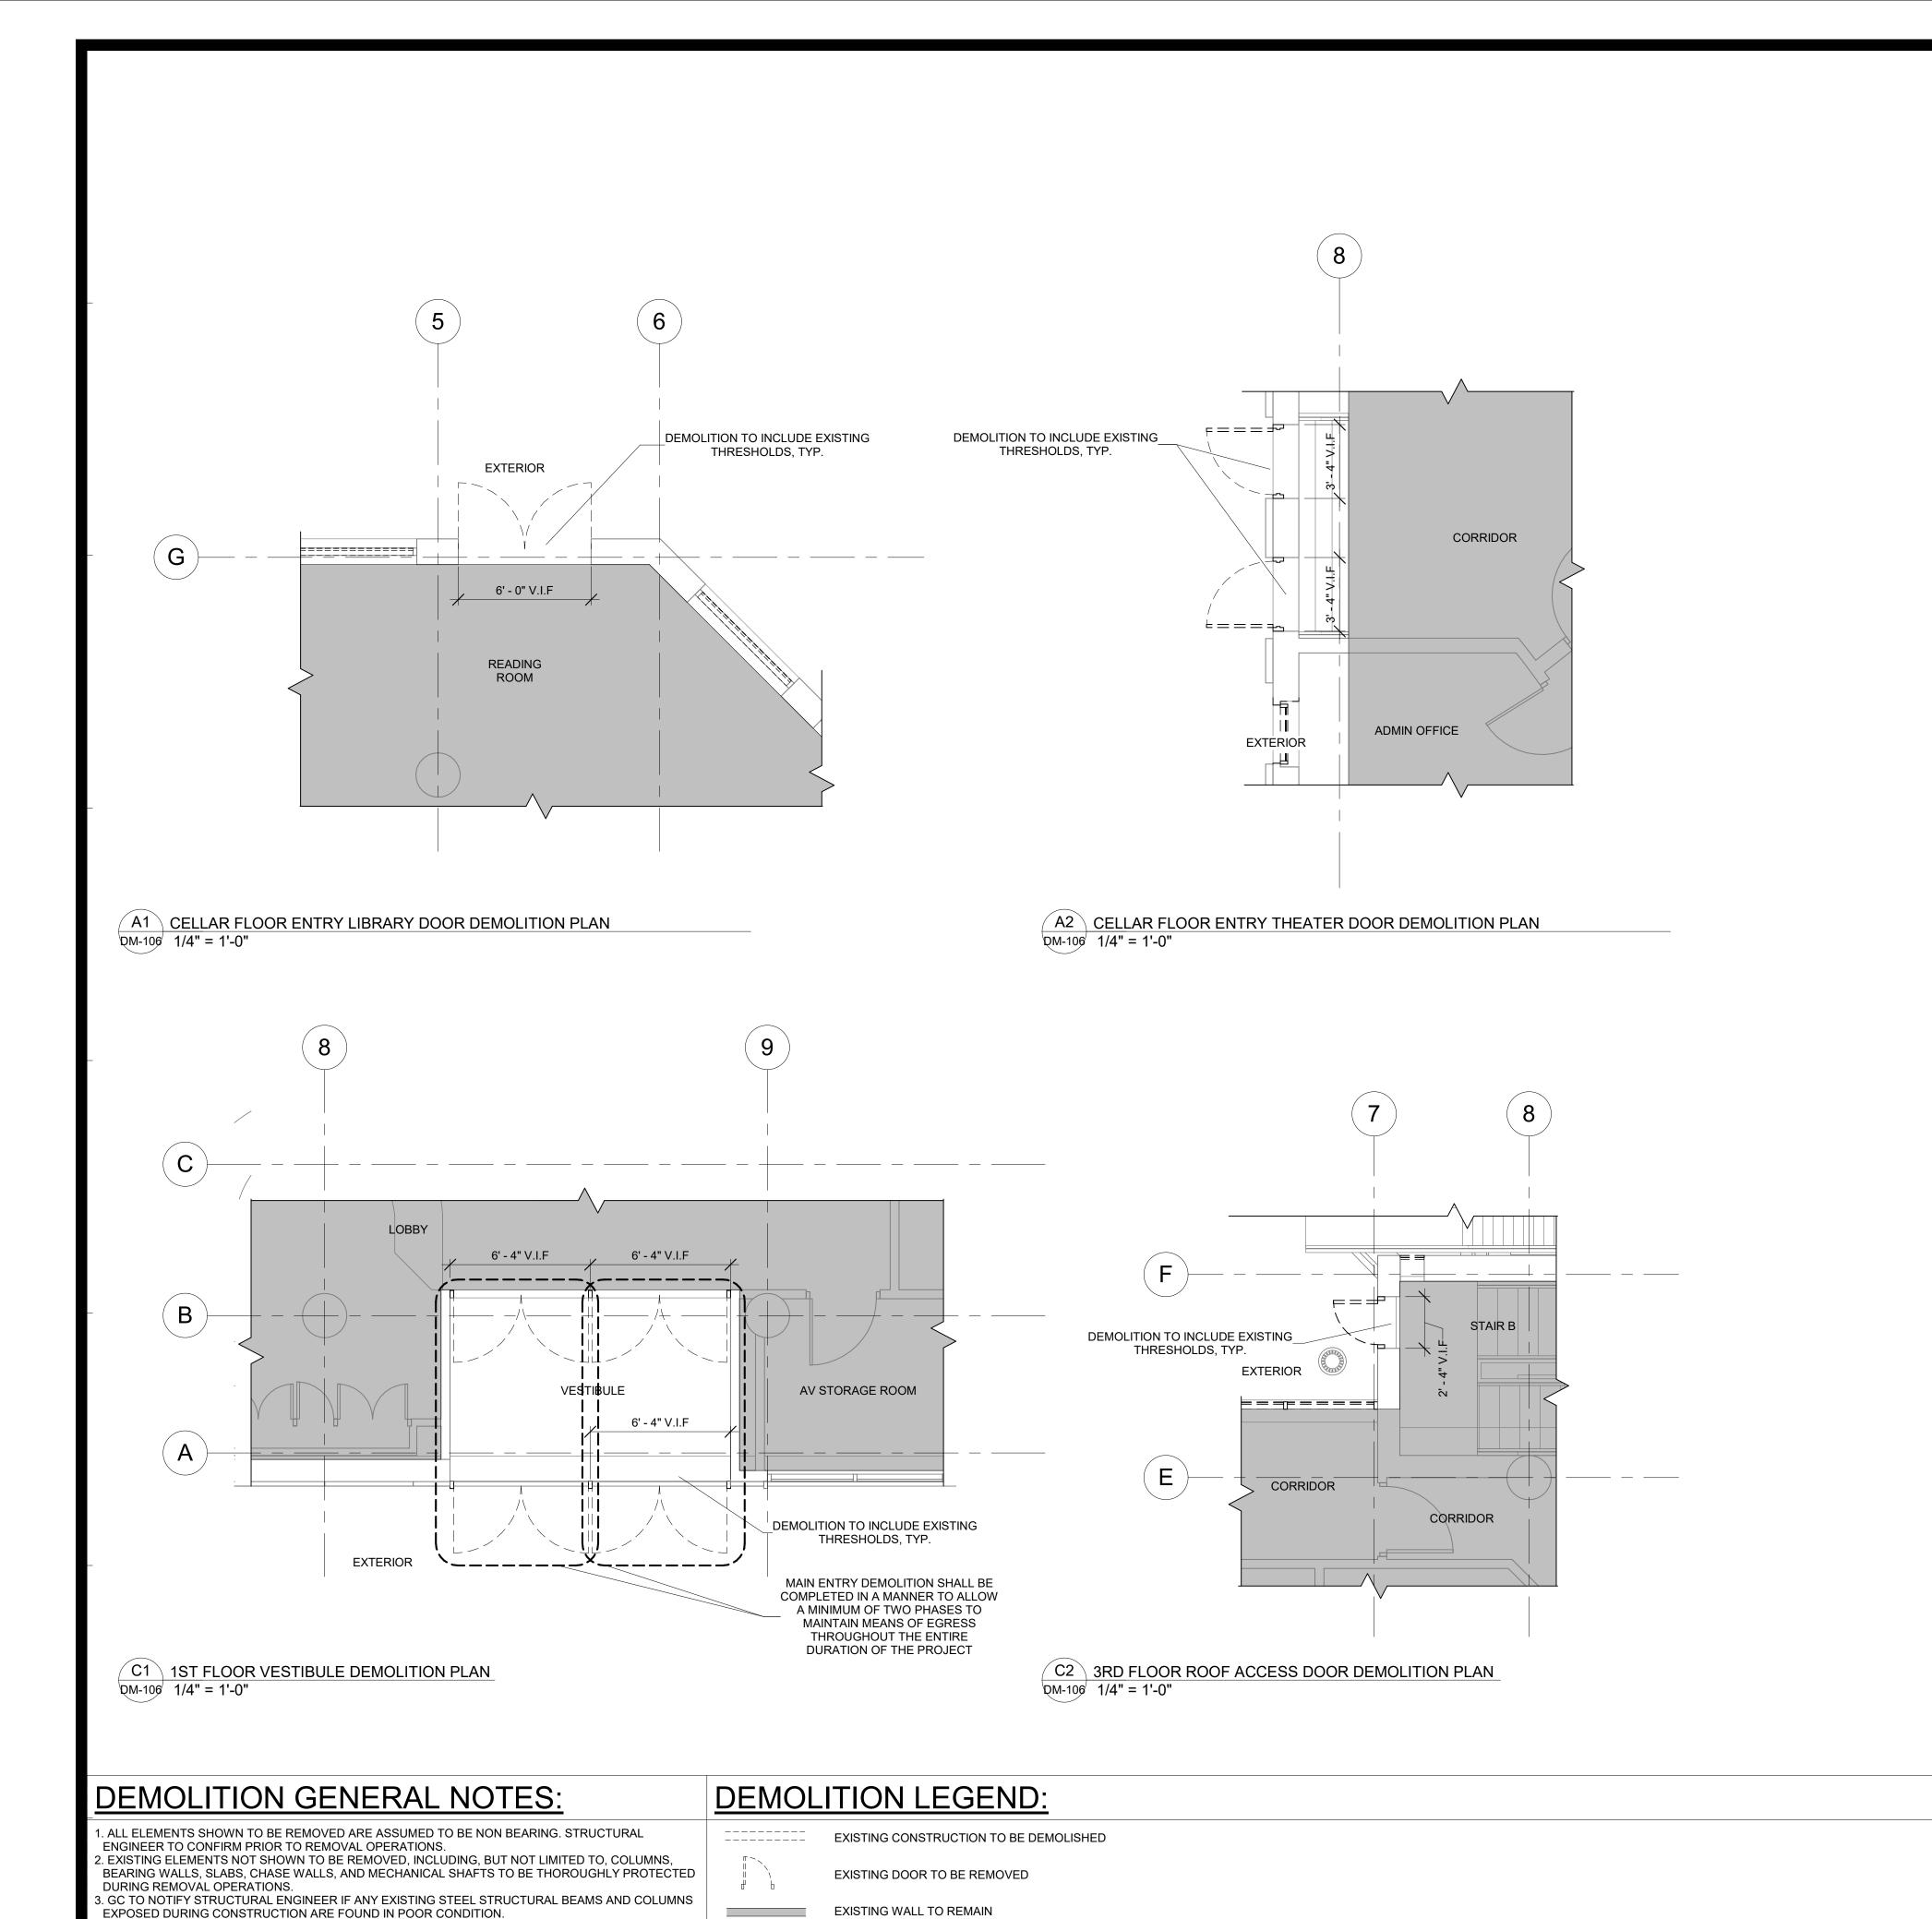

EXISTING DOOR TO REMAIN

EXISTING ROOFING MEMBRANE AND INSULATION TO BE REMOVED

PROPERTY LINE

4. NON-BEARING MASONRY WALLS TO REMAIN ARE TO BE TEMPORARILY SUPPORTED FOLLOWING


6. EXISTING COLUMN AND BEAM FIREPROOFING DAMAGED DURING REMOVAL OPERATIONS TO BE


REPAIRED AND RESTORED TO MEET REQUIRED RATINGS BY THE GC AT NO ADDITIONAL COST.

5. PATCH AND REPAIR SURROUNDING WALLS, CEILINGS, AND FLOORS WHERE DAMAGED BY

REMOVAL OF ADJACENT WALLS UNTIL PERMANENT SUPPORT IS INSTALLED.

DEMOLITION OPERATIONS, TO MATCH EXISTING.

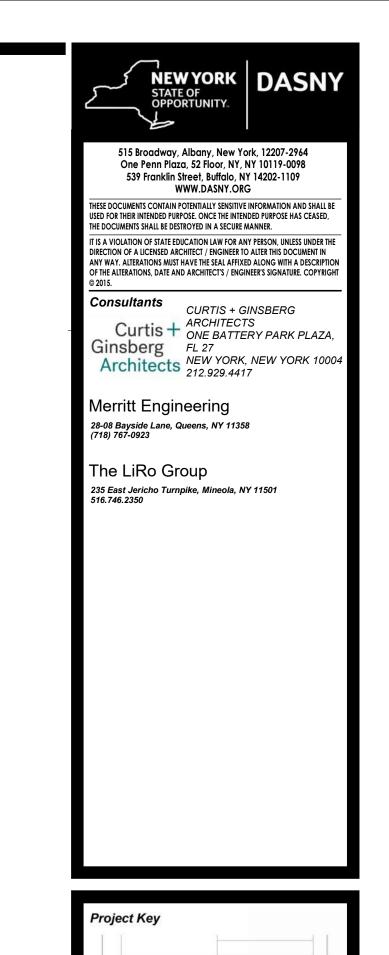


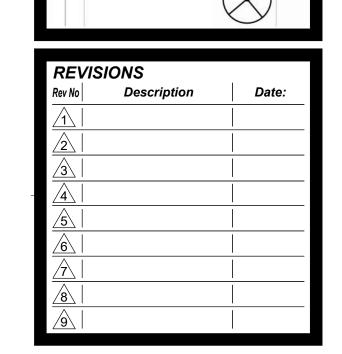


SCHOMBURG LIBRARY


MALCOM X BOULEVARD

LOT: 29

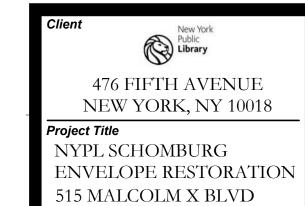

NEW YORK, NY 10037

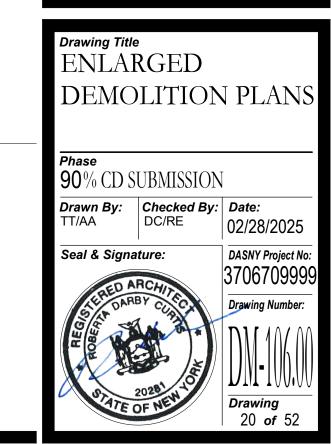

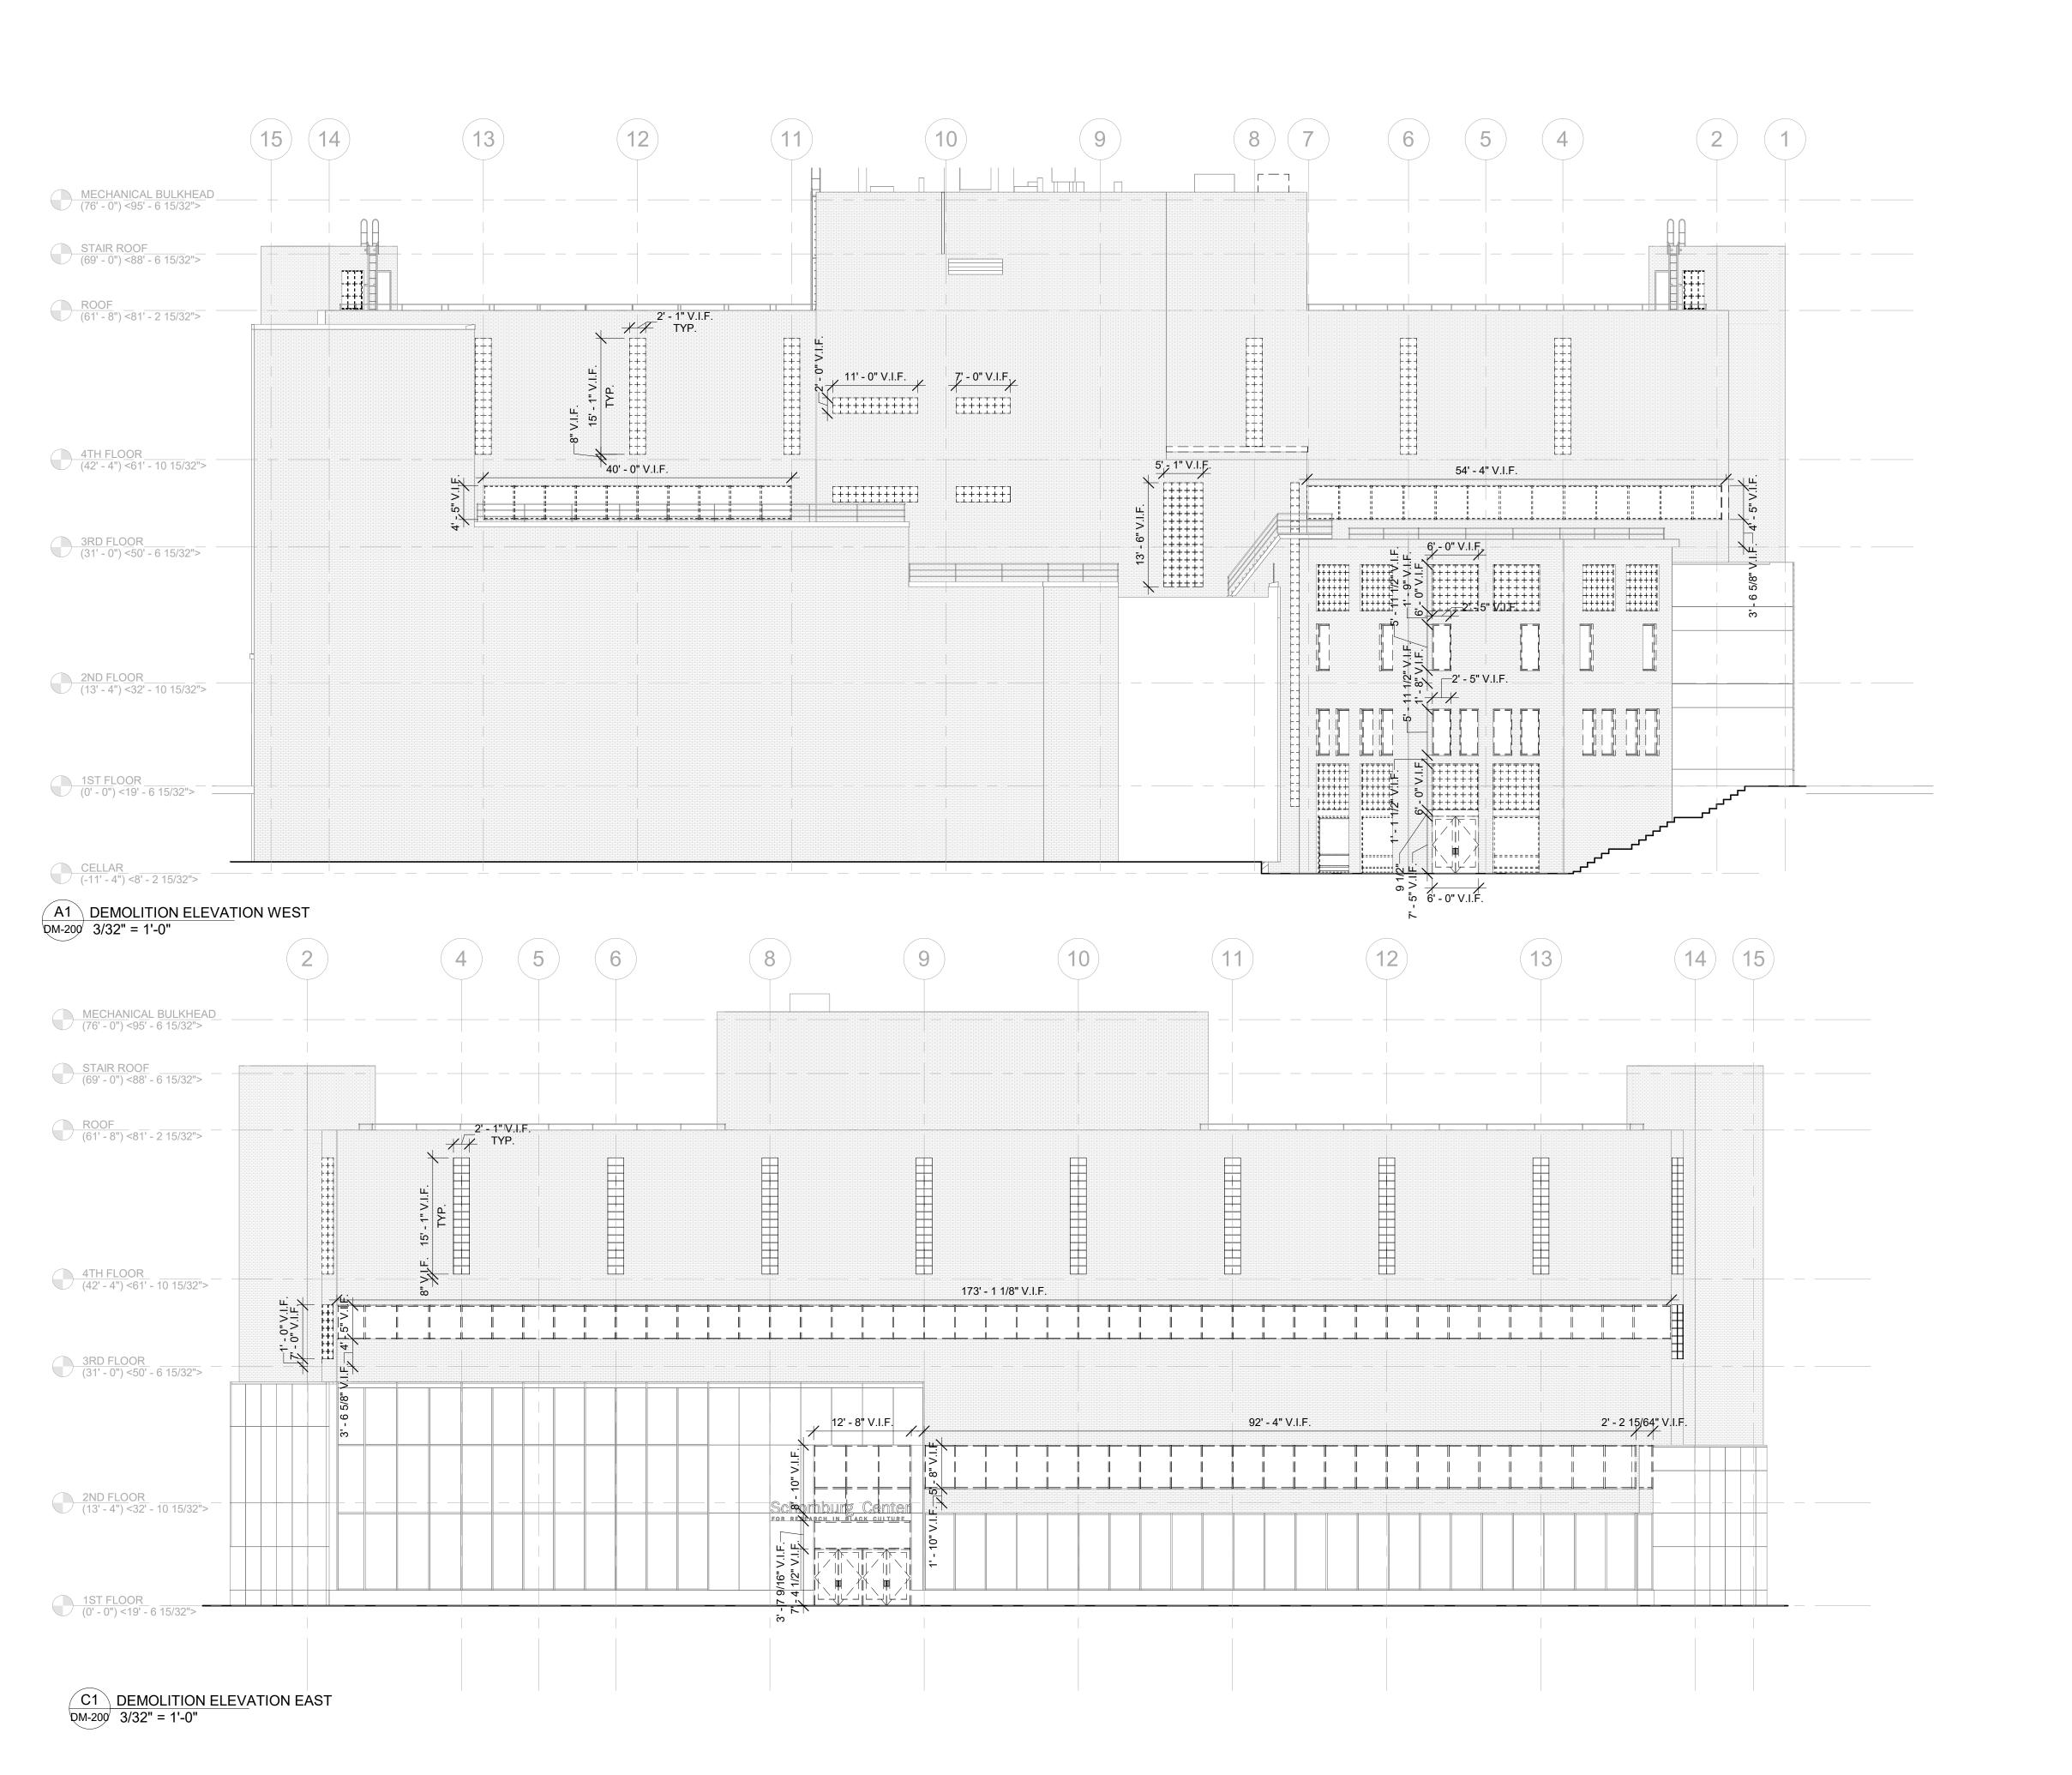

DEMOLITION GENERAL NOTES:

1. ALL ELEMENTS SHOWN TO BE REMOVED ARE ASSUMED TO BE NON BEARING. STRUCTURAL ENGINEER TO CONFIRM PRIOR TO REMOVAL OPERATIONS.

2. EXISTING ELEMENTS NOT SHOWN TO BE REMOVED, INCLUDING, BUT NOT LIMITED TO, COLUMNS, BEARING WALLS, SLABS, CHASE WALLS, AND MECHANICAL SHAFTS TO BE THOROUGHLY PROTECTED DURING REMOVAL OPERATIONS.

3. WINDOW SHADES TO BE CAREFULLY REMOVED AND STORED FOR REINSTALLATION FOLLOWING WINDOW REPLACEMENT WHERE POSSIBLE.



515 Broadway, Albany, New York, 12207-2964 One Penn Plaza, 52 Floor, NY, NY 10119-0098 539 Franklin Street, Buffalo, NY 14202-1109 WWW.DASNY.ORG

SE DOCUMENTS CONTAIN POTENTIALLY SENSITIVE INFORMATION AND SHALL BE USED FOR THEIR INTENDED PURPOSE. ONCE THE INTENDED PURPOSE HAS CEASED, THE DOCUMENTS SHALL BE DESTROYED IN A SECURE MANNER. IS A VIOLATION OF STATE EDUCATION LAW FOR ANY PERSON, UNLESS UNDER THE

DIRECTION OF A LICENSED ARCHITECT / ENGINEER TO ALTER THIS DOCUMENT IN ANY WAY. ALTERATIONS MUST HAVE THE SEAL AFFIXED ALONG WITH A DESCRIPTION OF THE ALTERATIONS, DATE AND ARCHITECT'S / ENGINEER'S SIGNATURE. COPYRIGHT

Consultants
CURTIS + GINSBERG
ARCHITECTS
ONE BATTERY PARK PLAZA,
Ginsberg
FL 27
Architects
NEW YORK, NEW YORK 10004
212.929.4417

Merritt Engineering 28-08 Bayside Lane, Queens, NY 11358 (718) 767-0923


The LiRo Group


235 East Jericho Turnpike, Mineola, NY 11501 516.746.2350

DEMOLITION LEGEND:

EXISTING NON-BEARING WALL TO BE REMOVE


EXISTING WINDOW TO BE REMOVED

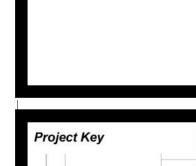

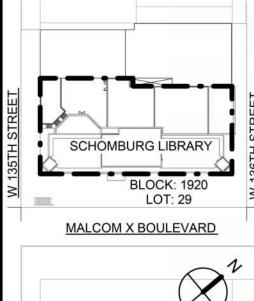

REVIS	REVISIONS		
Rev No	Description	Date:	
1			
2			
3\			
4			
<u></u> 5			
<u>6</u>			
<u> </u>			
8			
${\sqrt{9}}$			

DEMOLITION KEYPLAN:

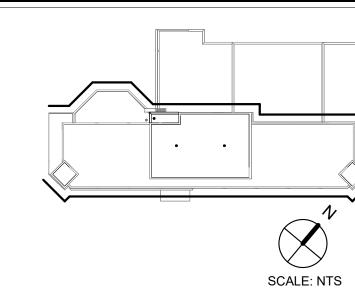

ELEVATIONS REFLECT EXISTING CONDITIONS UNLESS OTHERWISE NOTED. ALL DIMENSIONS TO BE VERIFIED IN

DOB APPROVAL STAMPS

New York Public **Library** 476 FIFTH AVENUE NEW YORK, NY 10018

NYPL SCHOMBURG


ENVELOPE RESTORATION 515 MALCOLM X BLVD NEW YORK, NY 10037


Drawing Title
EXTERIOR **DEMOLITION** ELEVATIONS I

Phase 90% CD SUBMISSION

 Drawn By:
 Checked By:
 Date:

 TT/AA
 DC/RE
 02/28/2025

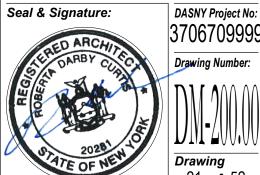

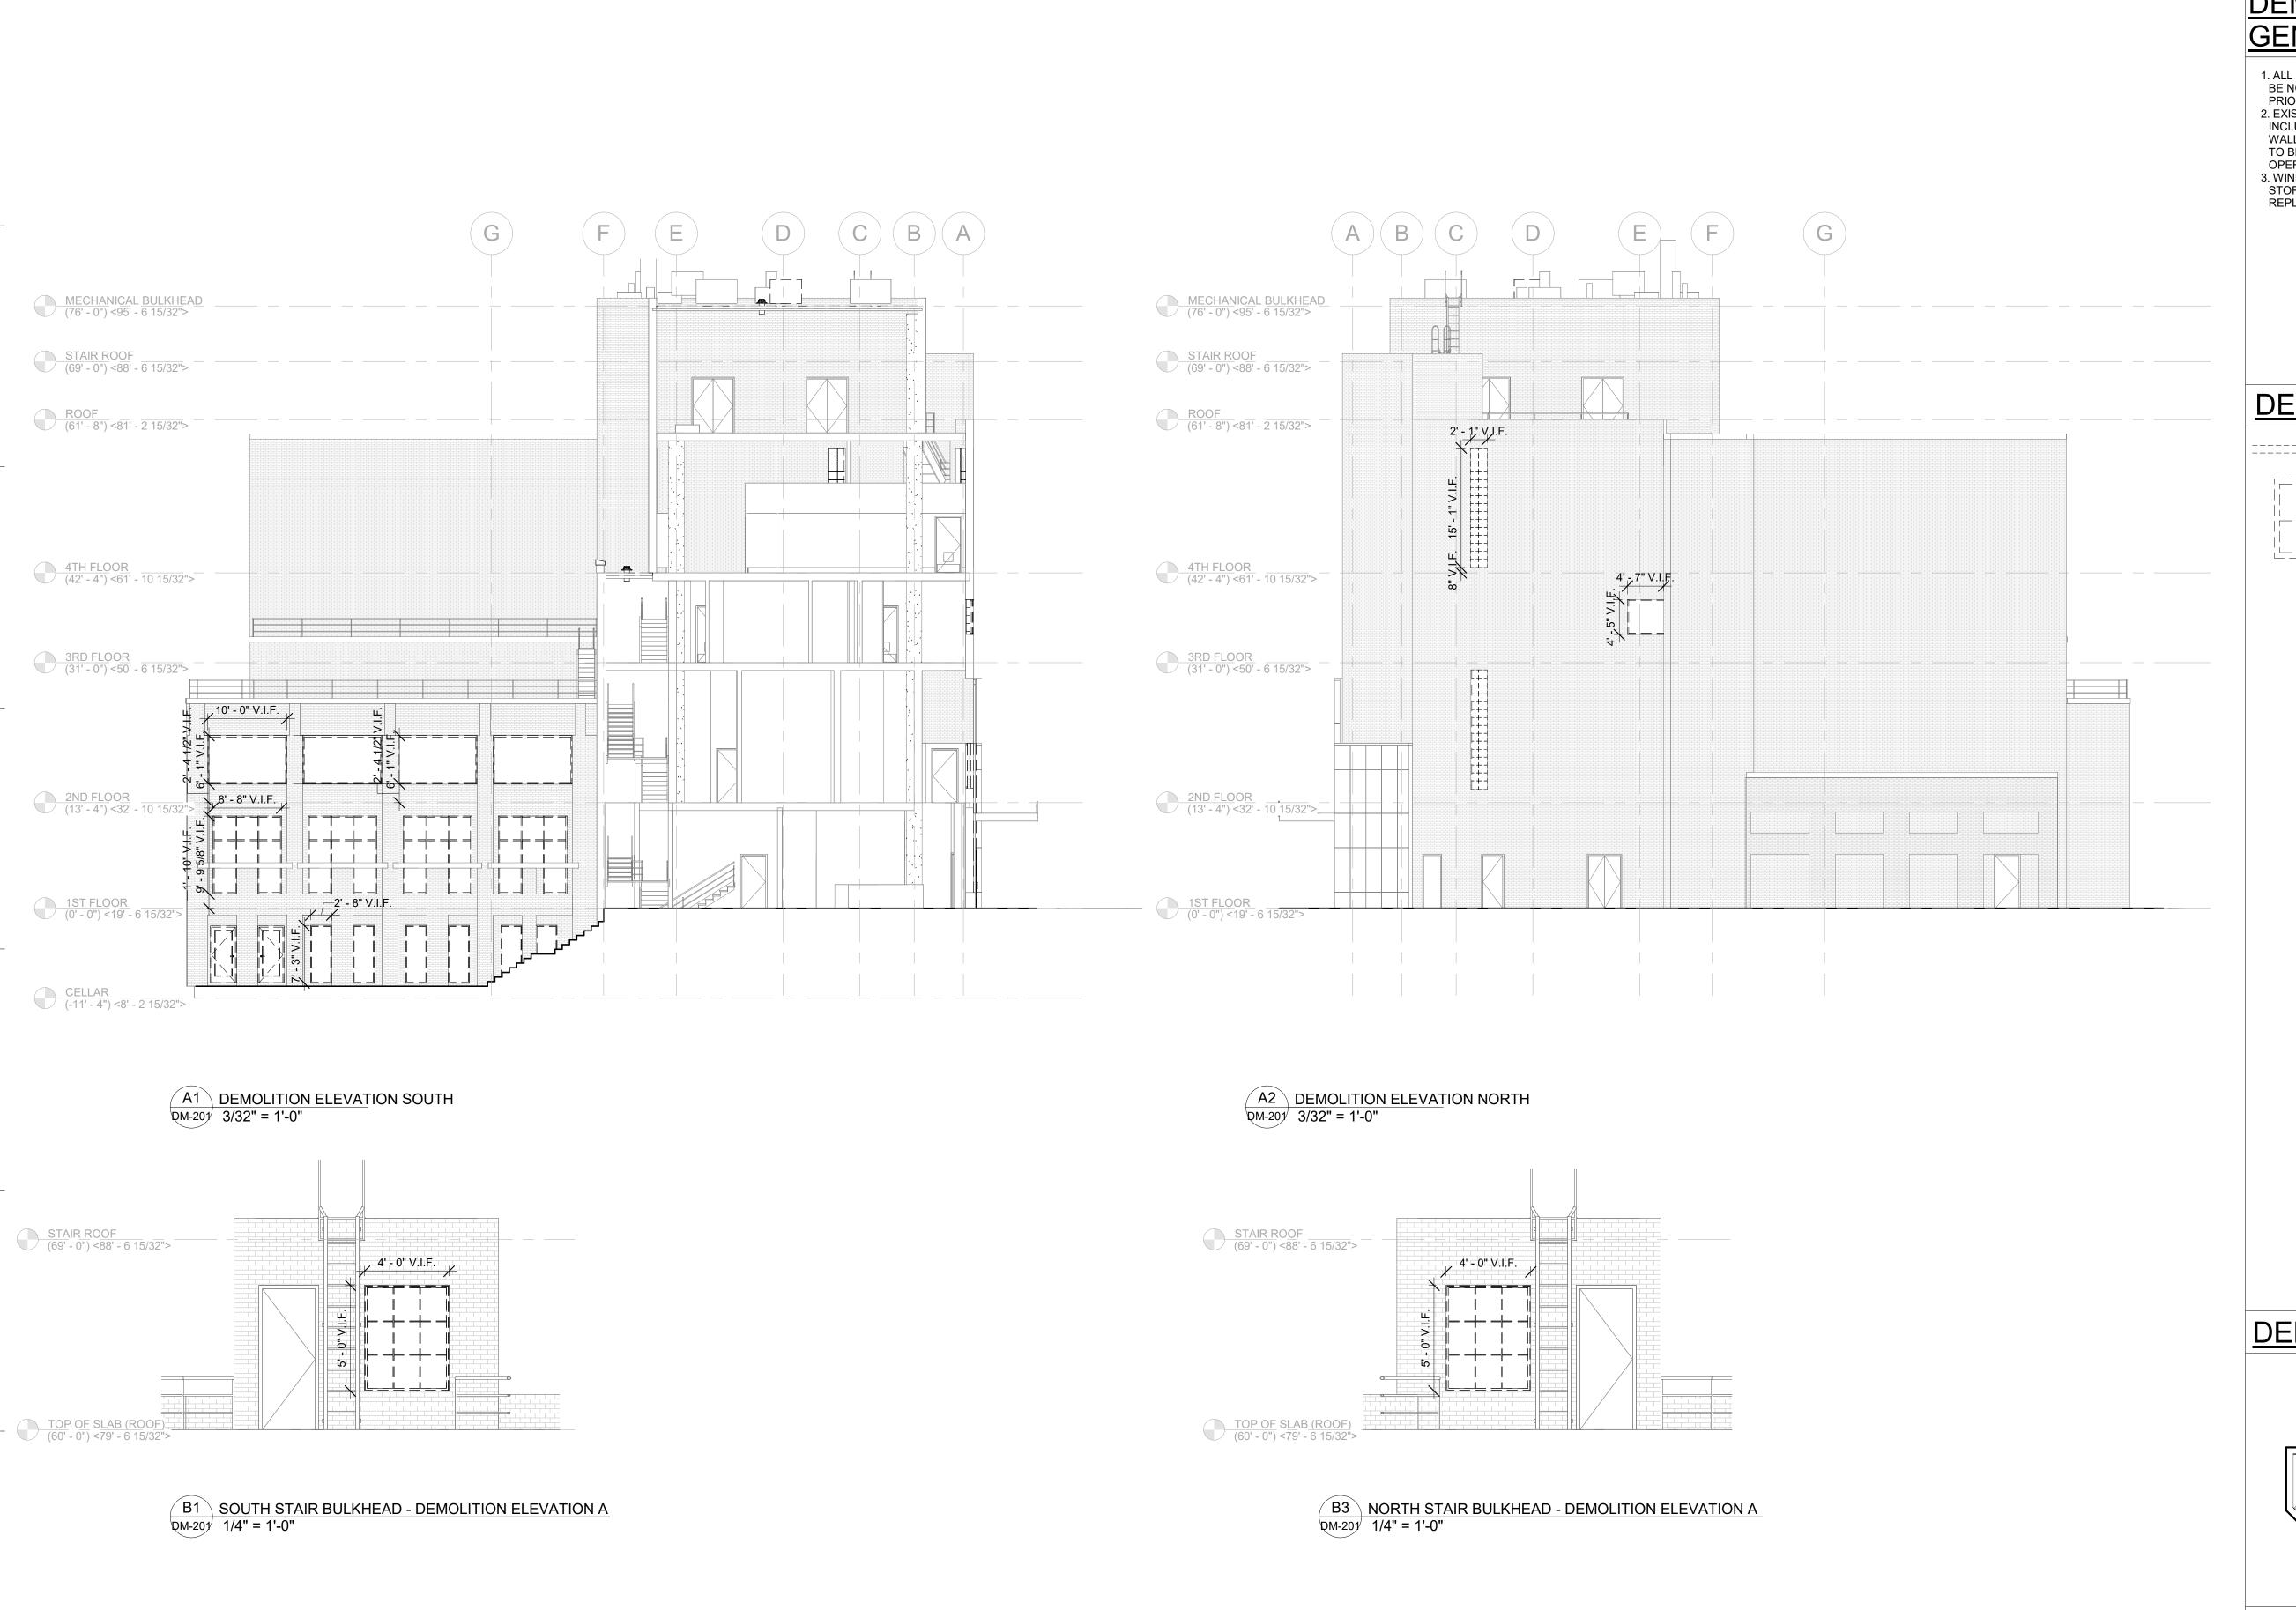

DEMOLITION GENERAL NOTES:

- 1. ALL ELEMENTS SHOWN TO BE REMOVED ARE ASSUMED TO BE NON BEARING. STRUCTURAL ENGINEER TO CONFIRM
- PRIOR TO REMOVAL OPERATIONS. 2. EXISTING ELEMENTS NOT SHOWN TO BE REMOVED, INCLUDING, BUT NOT LIMITED TO, COLUMNS, BEARING WALLS, SLABS, CHASE WALLS, AND MECHANICAL SHAFTS TO BE THOROUGHLY PROTECTED DURING REMOVAL
- OPERATIONS. 3. WINDOW SHADES TO BE CAREFULLY REMOVED AND STORED FOR REINSTALLATION FOLLOWING WINDOW REPLACEMENT WHERE POSSIBLE.



One Penn Plaza, 52 Floor, NY, NY 10119-0098 539 Franklin Street, Buffalo, NY 14202-1109 WWW.DASNY.ORG

THESE DOCUMENTS CONTAIN POTENTIALLY SENSITIVE INFORMATION AND SHALL BE USED FOR THEIR INTENDED PURPOSE. ONCE THE INTENDED PURPOSE HAS CEASED, THE DOCUMENTS SHALL BE DESTROYED IN A SECURE MANNER. IS A VIOLATION OF STATE EDUCATION LAW FOR ANY PERSON, UNLESS UNDER THE DIRECTION OF A LICENSED ARCHITECT / ENGINEER TO ALTER THIS DOCUMENT IN ANY WAY. ALTERATIONS MUST HAVE THE SEAL AFFIXED ALONG WITH A DESCRIPTION OF THE ALTERATIONS, DATE AND ARCHITECT'S / ENGINEER'S SIGNATURE. COPYRIGHT

Consultants CURTIS + GINSBERG Curtis + ARCHITECTS
ONE BATTERY PARK PLAZA, Ginsberg FL 27
Architects NEW YORK, NEW YORK 10004
212.929.4417

Merritt Engineering 28-08 Bayside Lane, Queens, NY 11358 (718) 767-0923


The LiRo Group

235 East Jericho Turnpike, Mineola, NY 11501 516.746.2350

DEMOLITION LEGEND:


EXISTING NON-BEARING WALL TO BE REMOVE

EXISTING WINDOW TO BE REMOVED

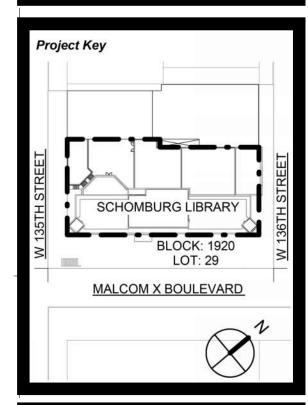

	REVIS	SIONS	
	Rev No	Description	Date:
	1		
	<u>2</u>		
	<u>3</u>		
-	<u>4</u>		
	<u>/</u> 5		
	<u>6</u>		
	<u> </u>		
	<u>8</u>		
	<u> \(\delta \) </u>		

DEMOLITION KEYPLAN:

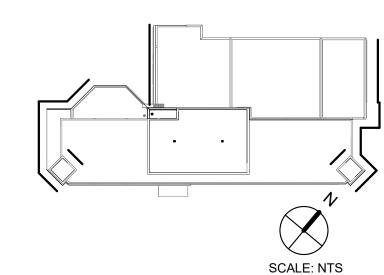

ELEVATIONS REFLECT EXISTING CONDITIONS UNLESS OTHERWISE NOTED. ALL DIMENSIONS TO BE VERIFIED IN FIELD.


DOB APPROVAL STAMPS


New York Public **Library** 476 FIFTH AVENUE NEW YORK, NY 10018 NYPL SCHOMBURG ENVELOPE RESTORATION 515 MALCOLM X BLVD NEW YORK, NY 10037

Drawing Title
EXTERIOR DEMOLITION ELEVATIONS II


Phase 90% CD SUBMISSION


Drawn By:Checked By:Date:TT/AADC/RE02/28/2025

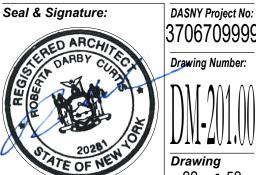

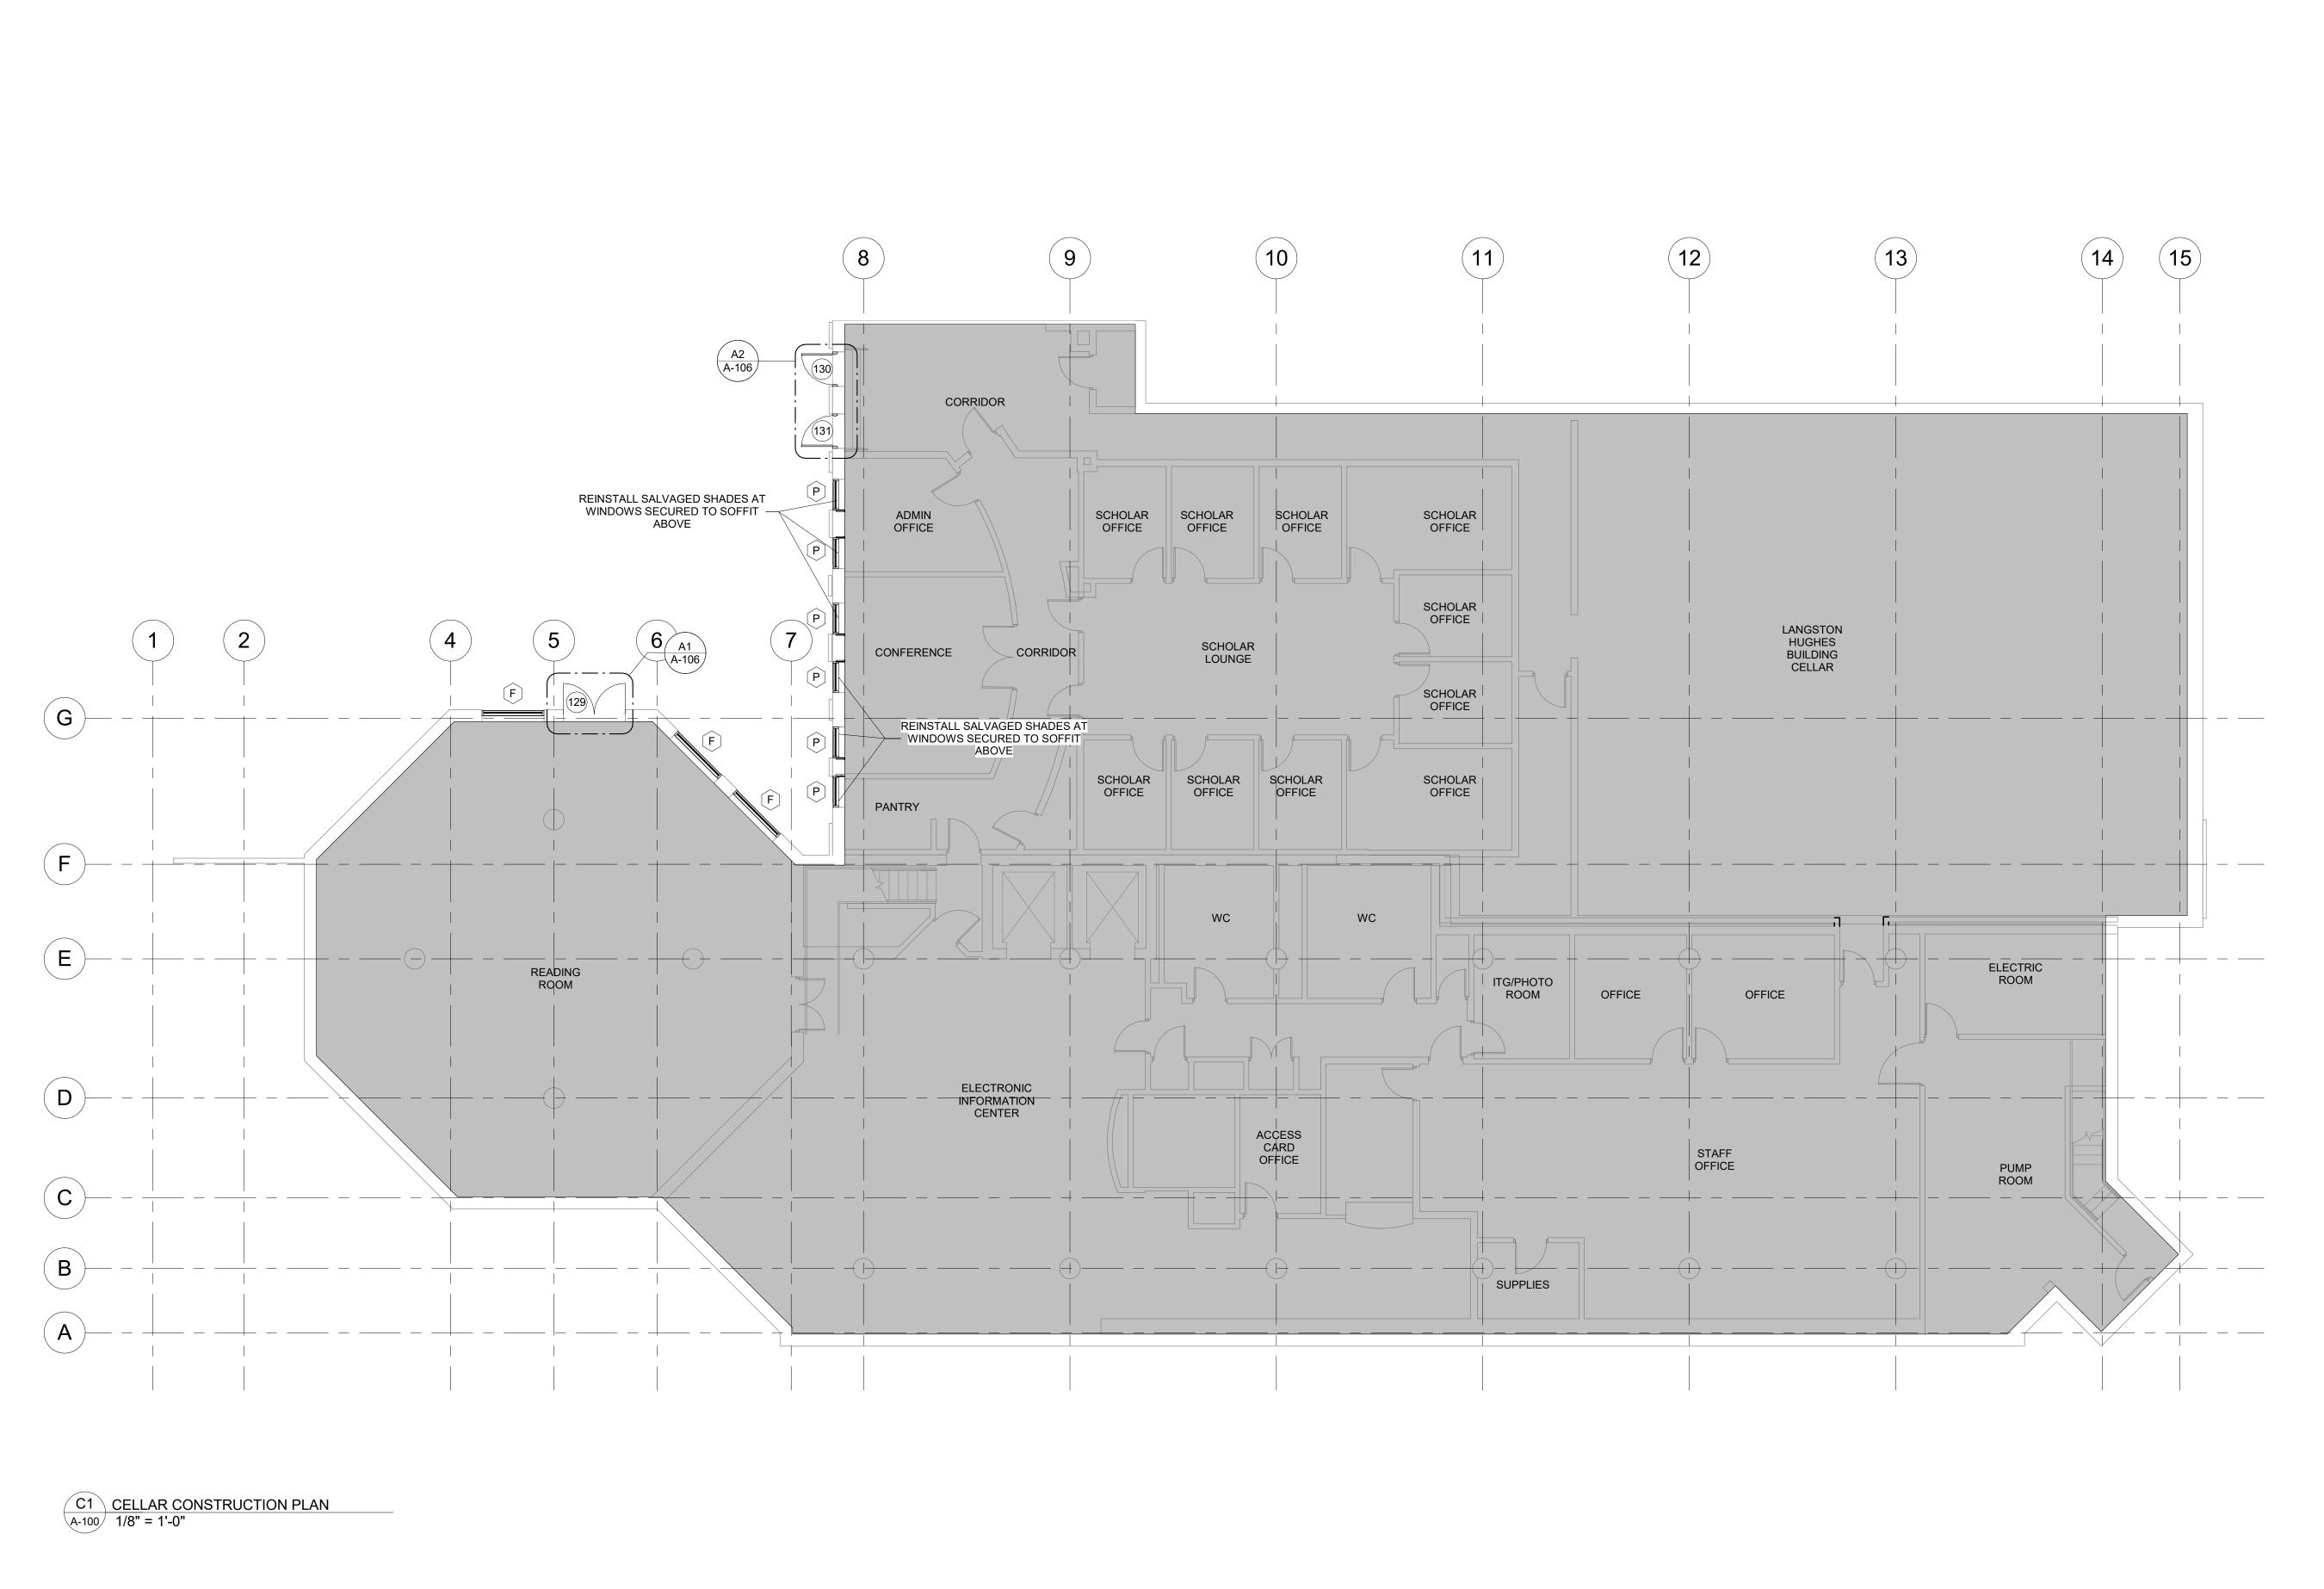


GENERAL NOTES: LEGEND: DOB APPROVAL STAMPS SEE A-610 FOR DOOR SCHEDULE.
 SEE A-611 FOR EXTERIOR DOOR HEAD AND JAMB DETAILS.
 TEMPORARY PROTECTION MEANS AND METHODS BY G.C. COORDINATE WITH OWNERSHIP ON EXTENTS AND PHASING.
 SEE A-320 FOR WINDOW SCHEDULE N.I.C. TYP. SCALE: NTS PLANS REFLECT EXISTING CONDITIONS UNLESS OTHERWISE NOTED. ALL DIMENSIONS TO BE VERIFIED IN FIELD.

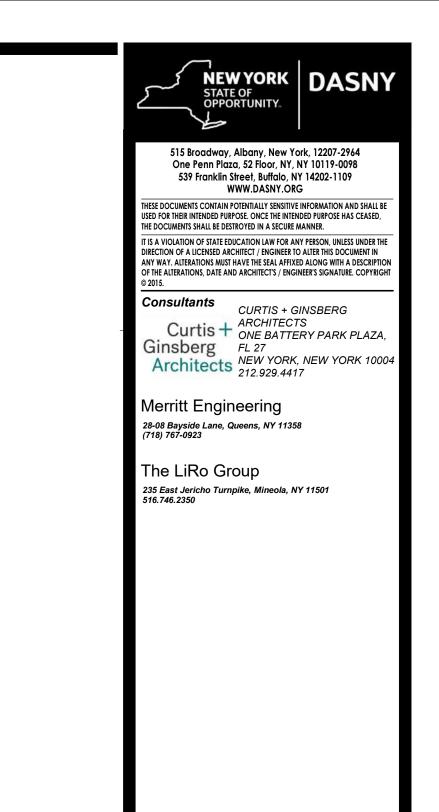

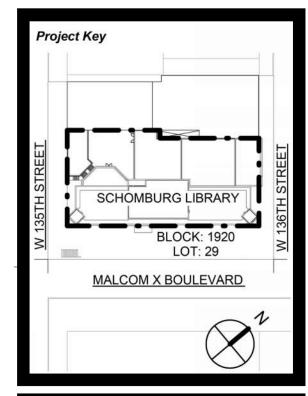


REVIS Rev No	Description	Date:
	·	<u> </u>
$\frac{2}{2}$		<u>'</u>
3		Ì
${4}$		İ
5		1
<u></u>		
7		
8		
9\		

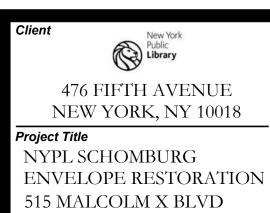

	Drawing Title CELLA CONST PLAN		ON
Phase 90% CD SUB		UBMISSION	
	Drawn By: TT/AA	Checked By: Checker	Date: 02/28/2025
	Seal & Signa		DASNY Project N 370670999 Drawing Number


NEW YORK, NY 10037

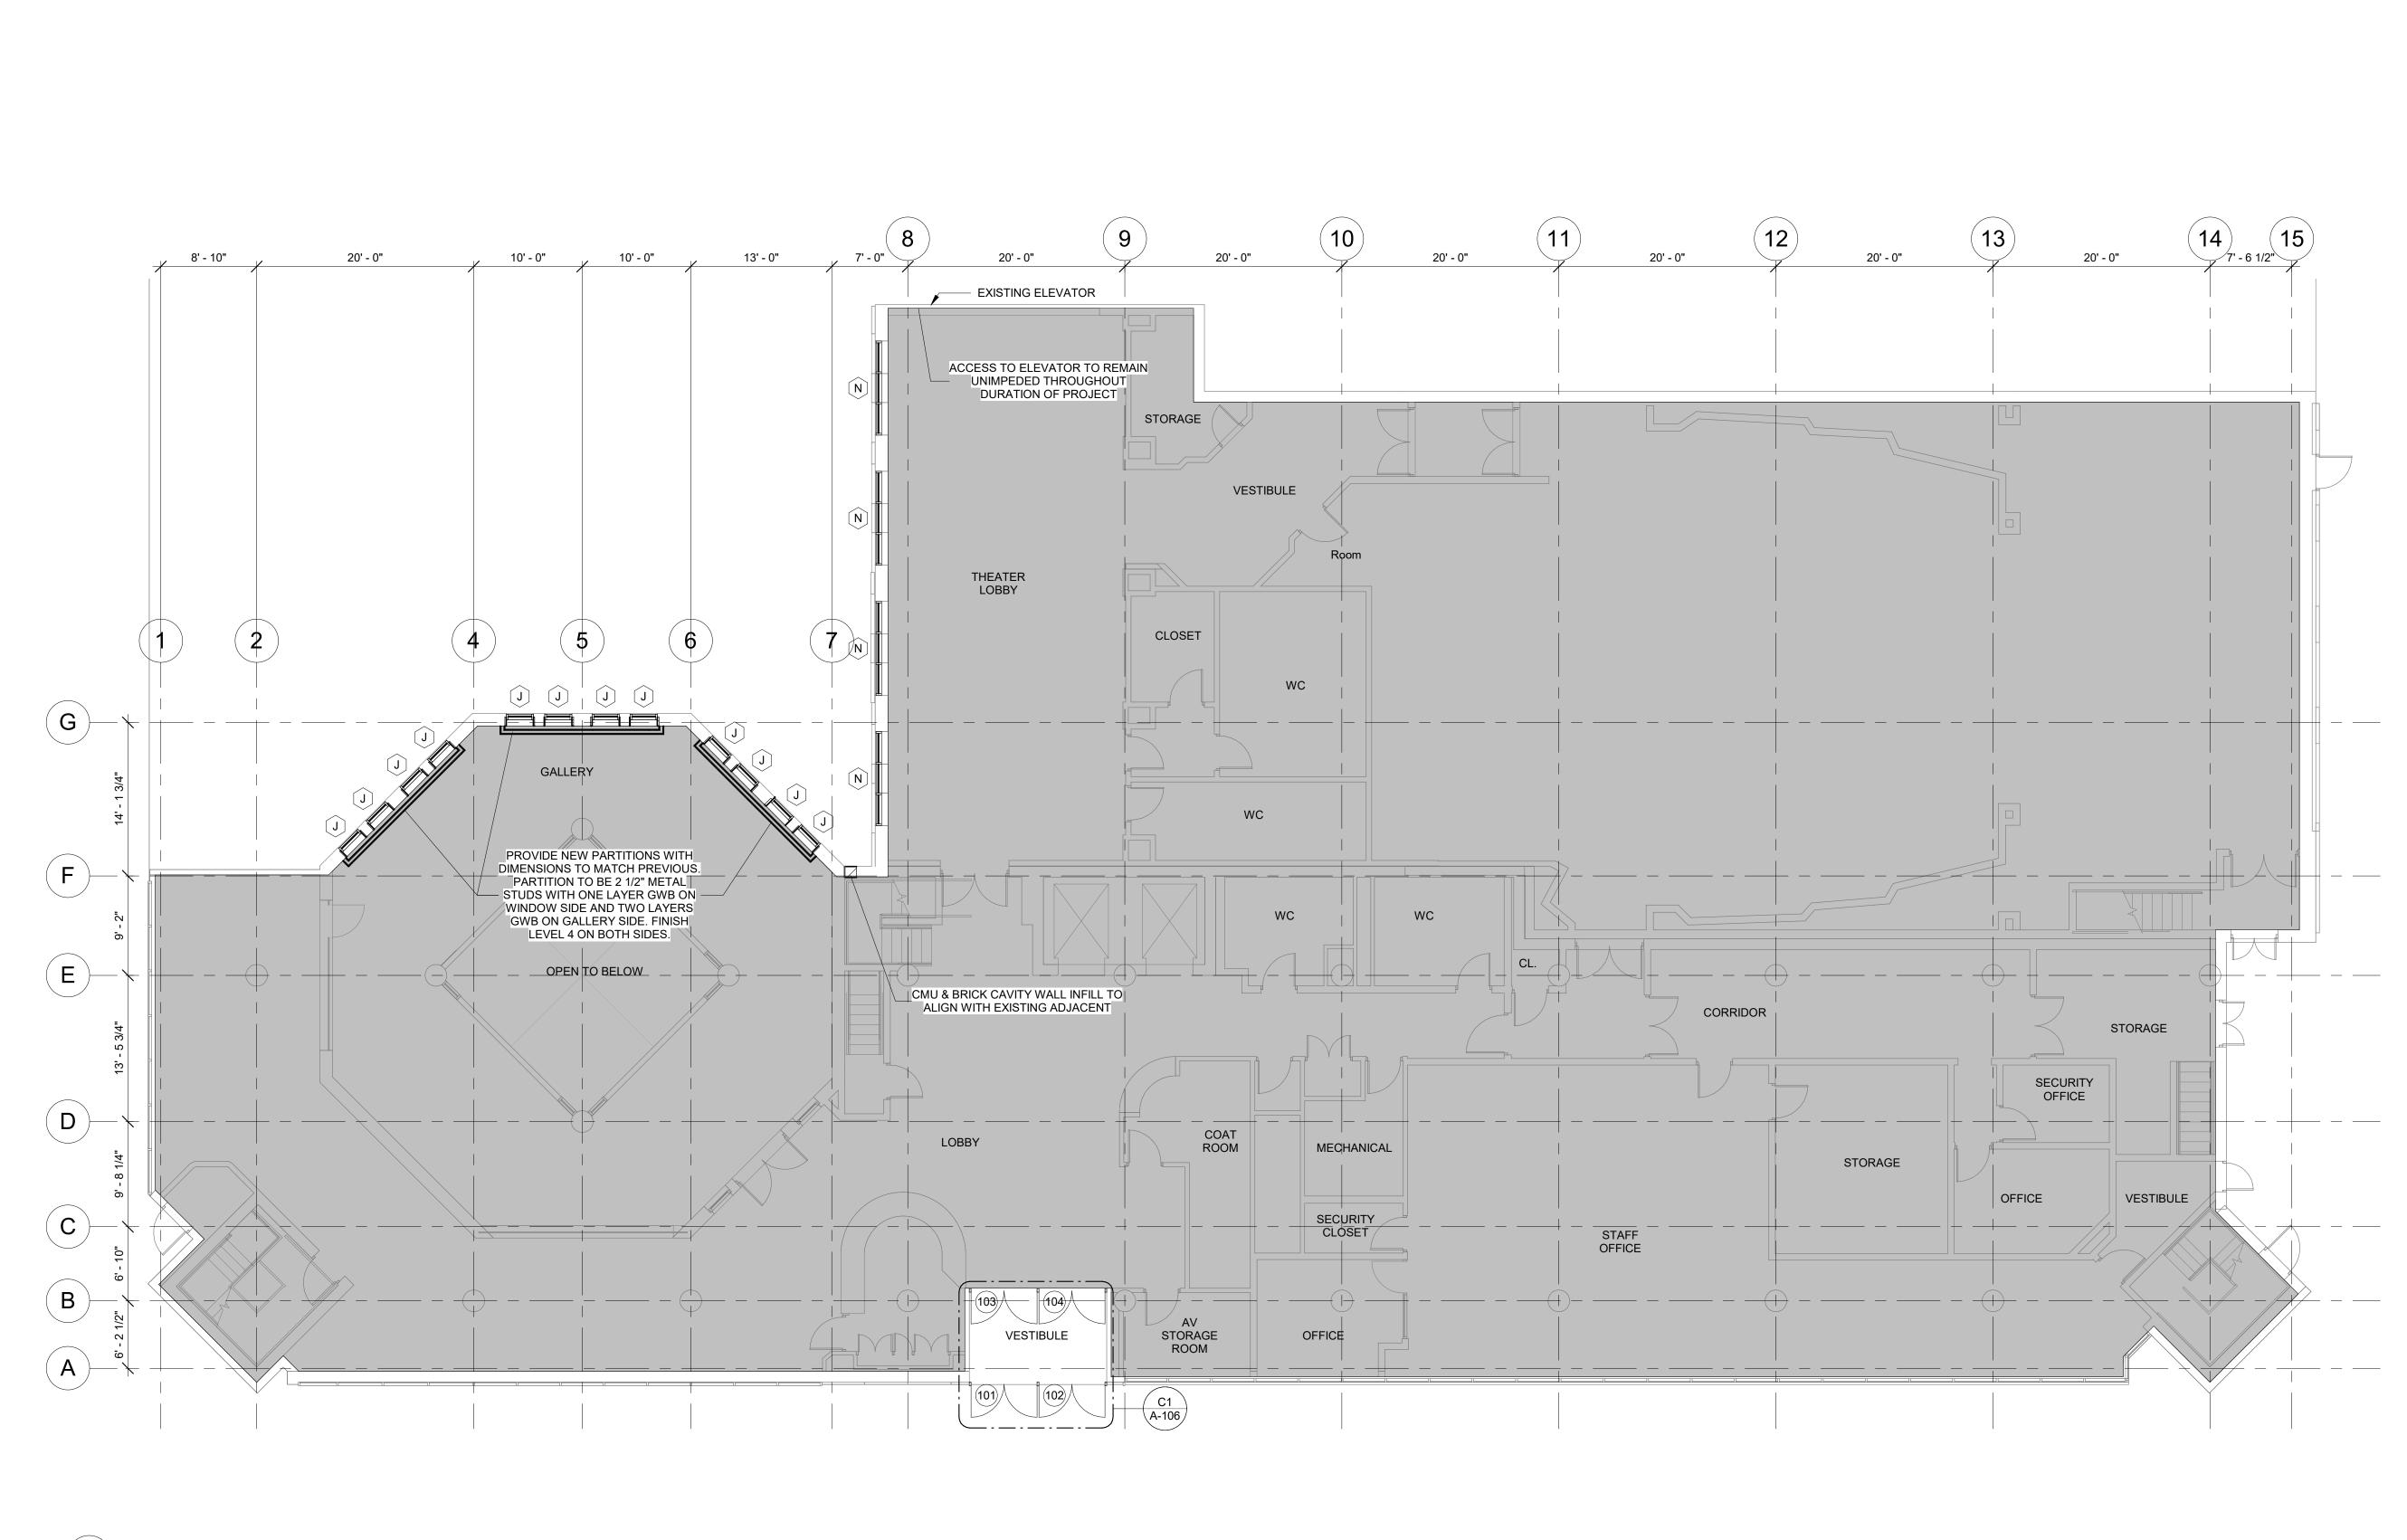


C1 FIRST FLOOR CONSTRUCTION PLAN
A-101 1/8" = 1'-0"


SENERAL NOTES:	LEGEND:	 DOB APP
SEE A-610 FOR DOOR SCHEDULE. SEE A-611 FOR EXTERIOR DOOR HEAD AND JAMB DETAILS. TEMPORARY PROTECTION MEANS AND METHODS BY G.C. OORDINATE WITH OWNERSHIP ON EXTENTS AND PHASING. SEE A-320 FOR WINDOW SCHEDULE	N.I.C. TYP.	
		SCALE: NTS



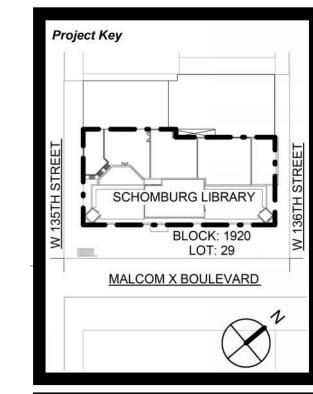


REVISIONS		
Rev No	Description	Date:
1		
2		
<u>3</u>		
4		
<u>/</u> 5		
<u>6</u>		
<u> </u>		
<u>8</u>		
9		

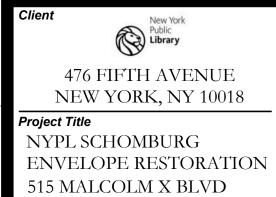

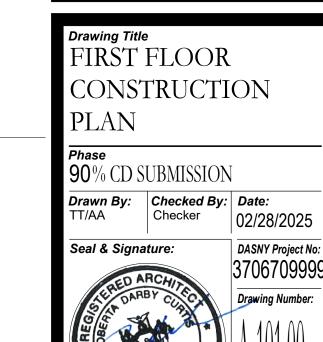

NEW YORK, NY 10037

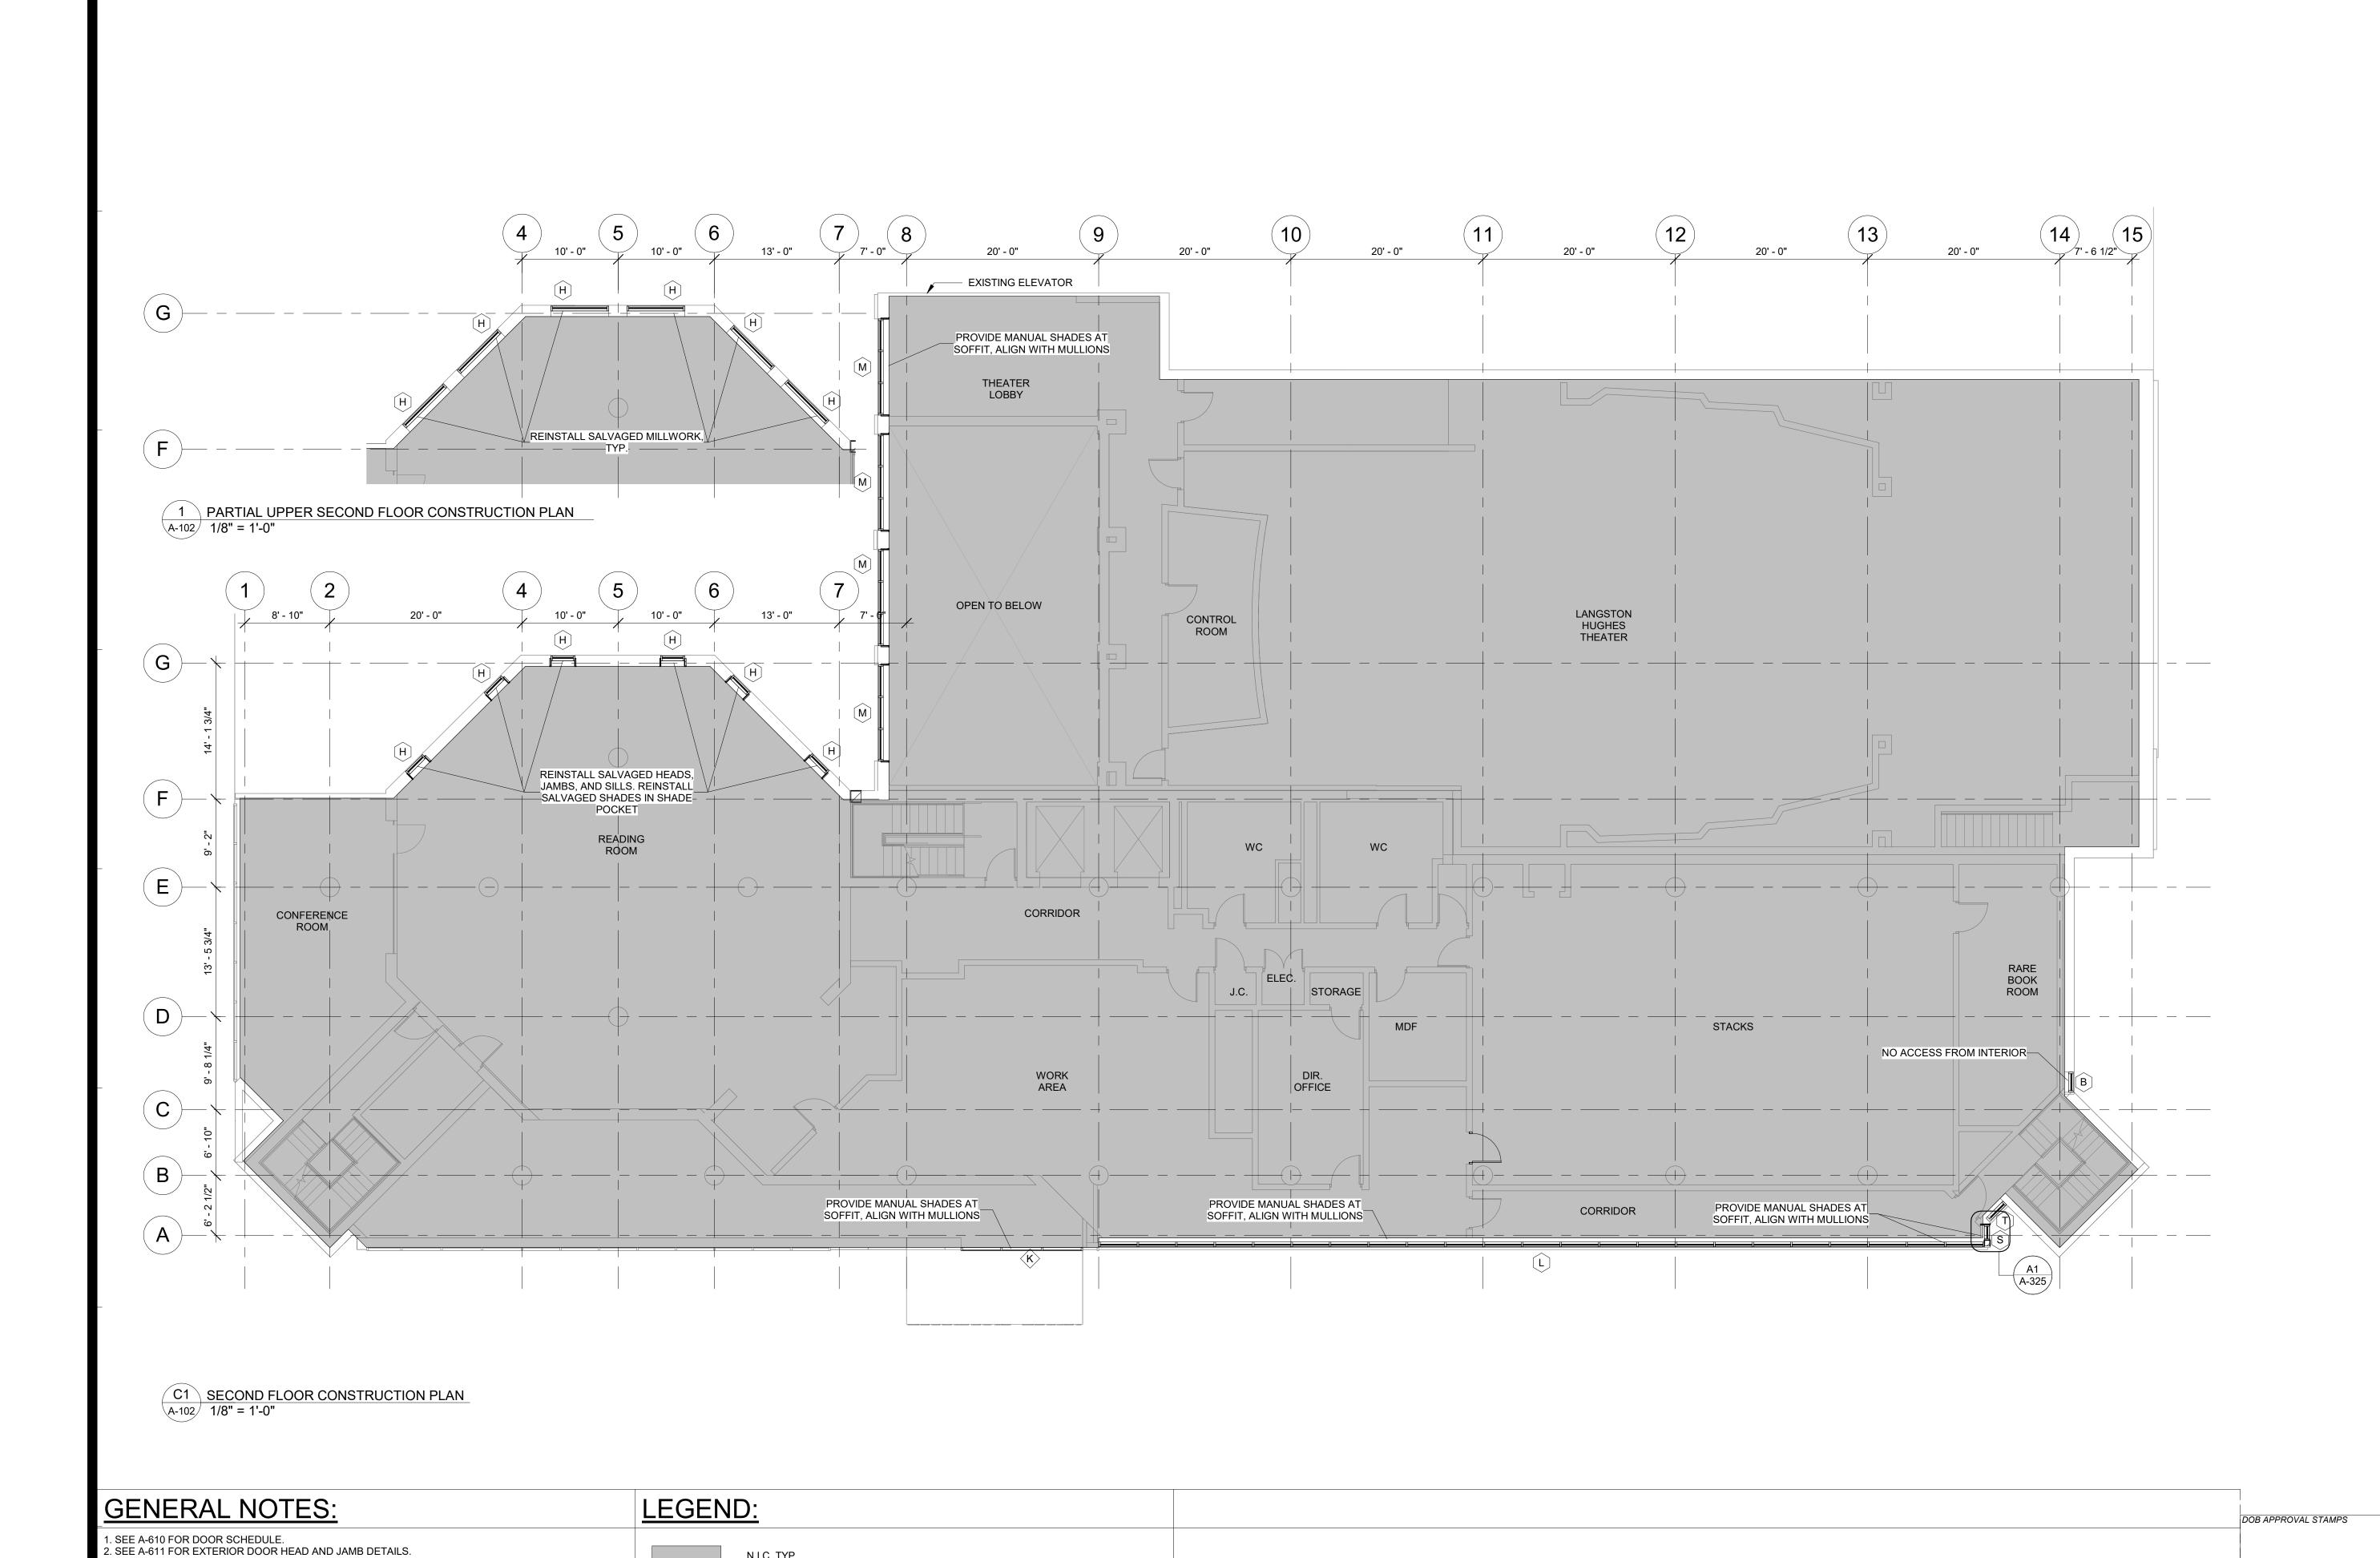


N.I.C. TYP.

3. TEMPORARY PROTECTION MEANS AND METHODS BY G.C.

COORDINATE WITH OWNERSHIP ON EXTENTS AND PHASING. 4. SEE A-320 FOR WINDOW SCHEDULE

NEW YORK STATE OF OPPORTUNITY. DASNY 515 Broadway, Albany, New York, 12207-2964 One Penn Plaza, 52 Floor, NY, NY 10119-0098 539 Franklin Street, Buffalo, NY 14202-1109 WWW.DASNY.ORG THESE DOCUMENTS CONTAIN POTENTIALLY SENSITIVE INFORMATION AND SHALL BE USED FOR THEIR INTENDED PURPOSE. ONCE THE INTENDED PURPOSE HAS CEASED, THE DOCUMENTS SHALL BE DESTROYED IN A SECURE MANNER. IT IS A VIOLATION OF STATE EDUCATION LAW FOR ANY PERSON, UNLESS UNDER THE DIRECTION OF A LICENSED ARCHITECT / ENGINEER TO ALTER THIS DOCUMENT IN ANY WAY. ALTERATIONS MUST HAVE THE SEAL AFFIXED ALONG WITH A DESCRIPTION OF THE ALTERATIONS, DATE AND ARCHITECT'S / ENGINEER'S SIGNATURE. COPYRIGHT Consultants Curtis + GINSBERG
ARCHITECTS
ONE BATTERY PARK PLAZA, Ginsberg FL 27
Architects NEW YORK, NEW YORK 10004
212.929.4417 Merritt Engineering 28-08 Bayside Lane, Queens, NY 11358 (718) 767-0923 The LiRo Group 235 East Jericho Turnpike, Mineola, NY 11501 516.746.2350

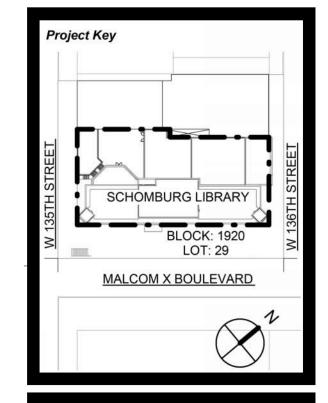

	REVISIONS		
Rev No	Description	Date:	
1			
<u>2</u>			
<u>3</u>			
<u>4</u>			
<u>/</u> 5			
<u>6</u>			
<u> </u>			
<u>8</u>			
<u> \lambda </u>			



NYPL SCHOMBURG ENVELOPE RESTORATION 515 MALCOLM X BLVD NEW YORK, NY 10037



90% CD SUBMISSION


Drawn By: Checked By: Date: TT/AA Checker 02/28/

Seal & Signature:

DASNY Project No: 3706709999


SCALE: NTS

PLANS REFLECT EXISTING CONDITIONS UNLESS OTHERWISE NOTED. ALL DIMENSIONS TO BE VERIFIED IN FIELD.

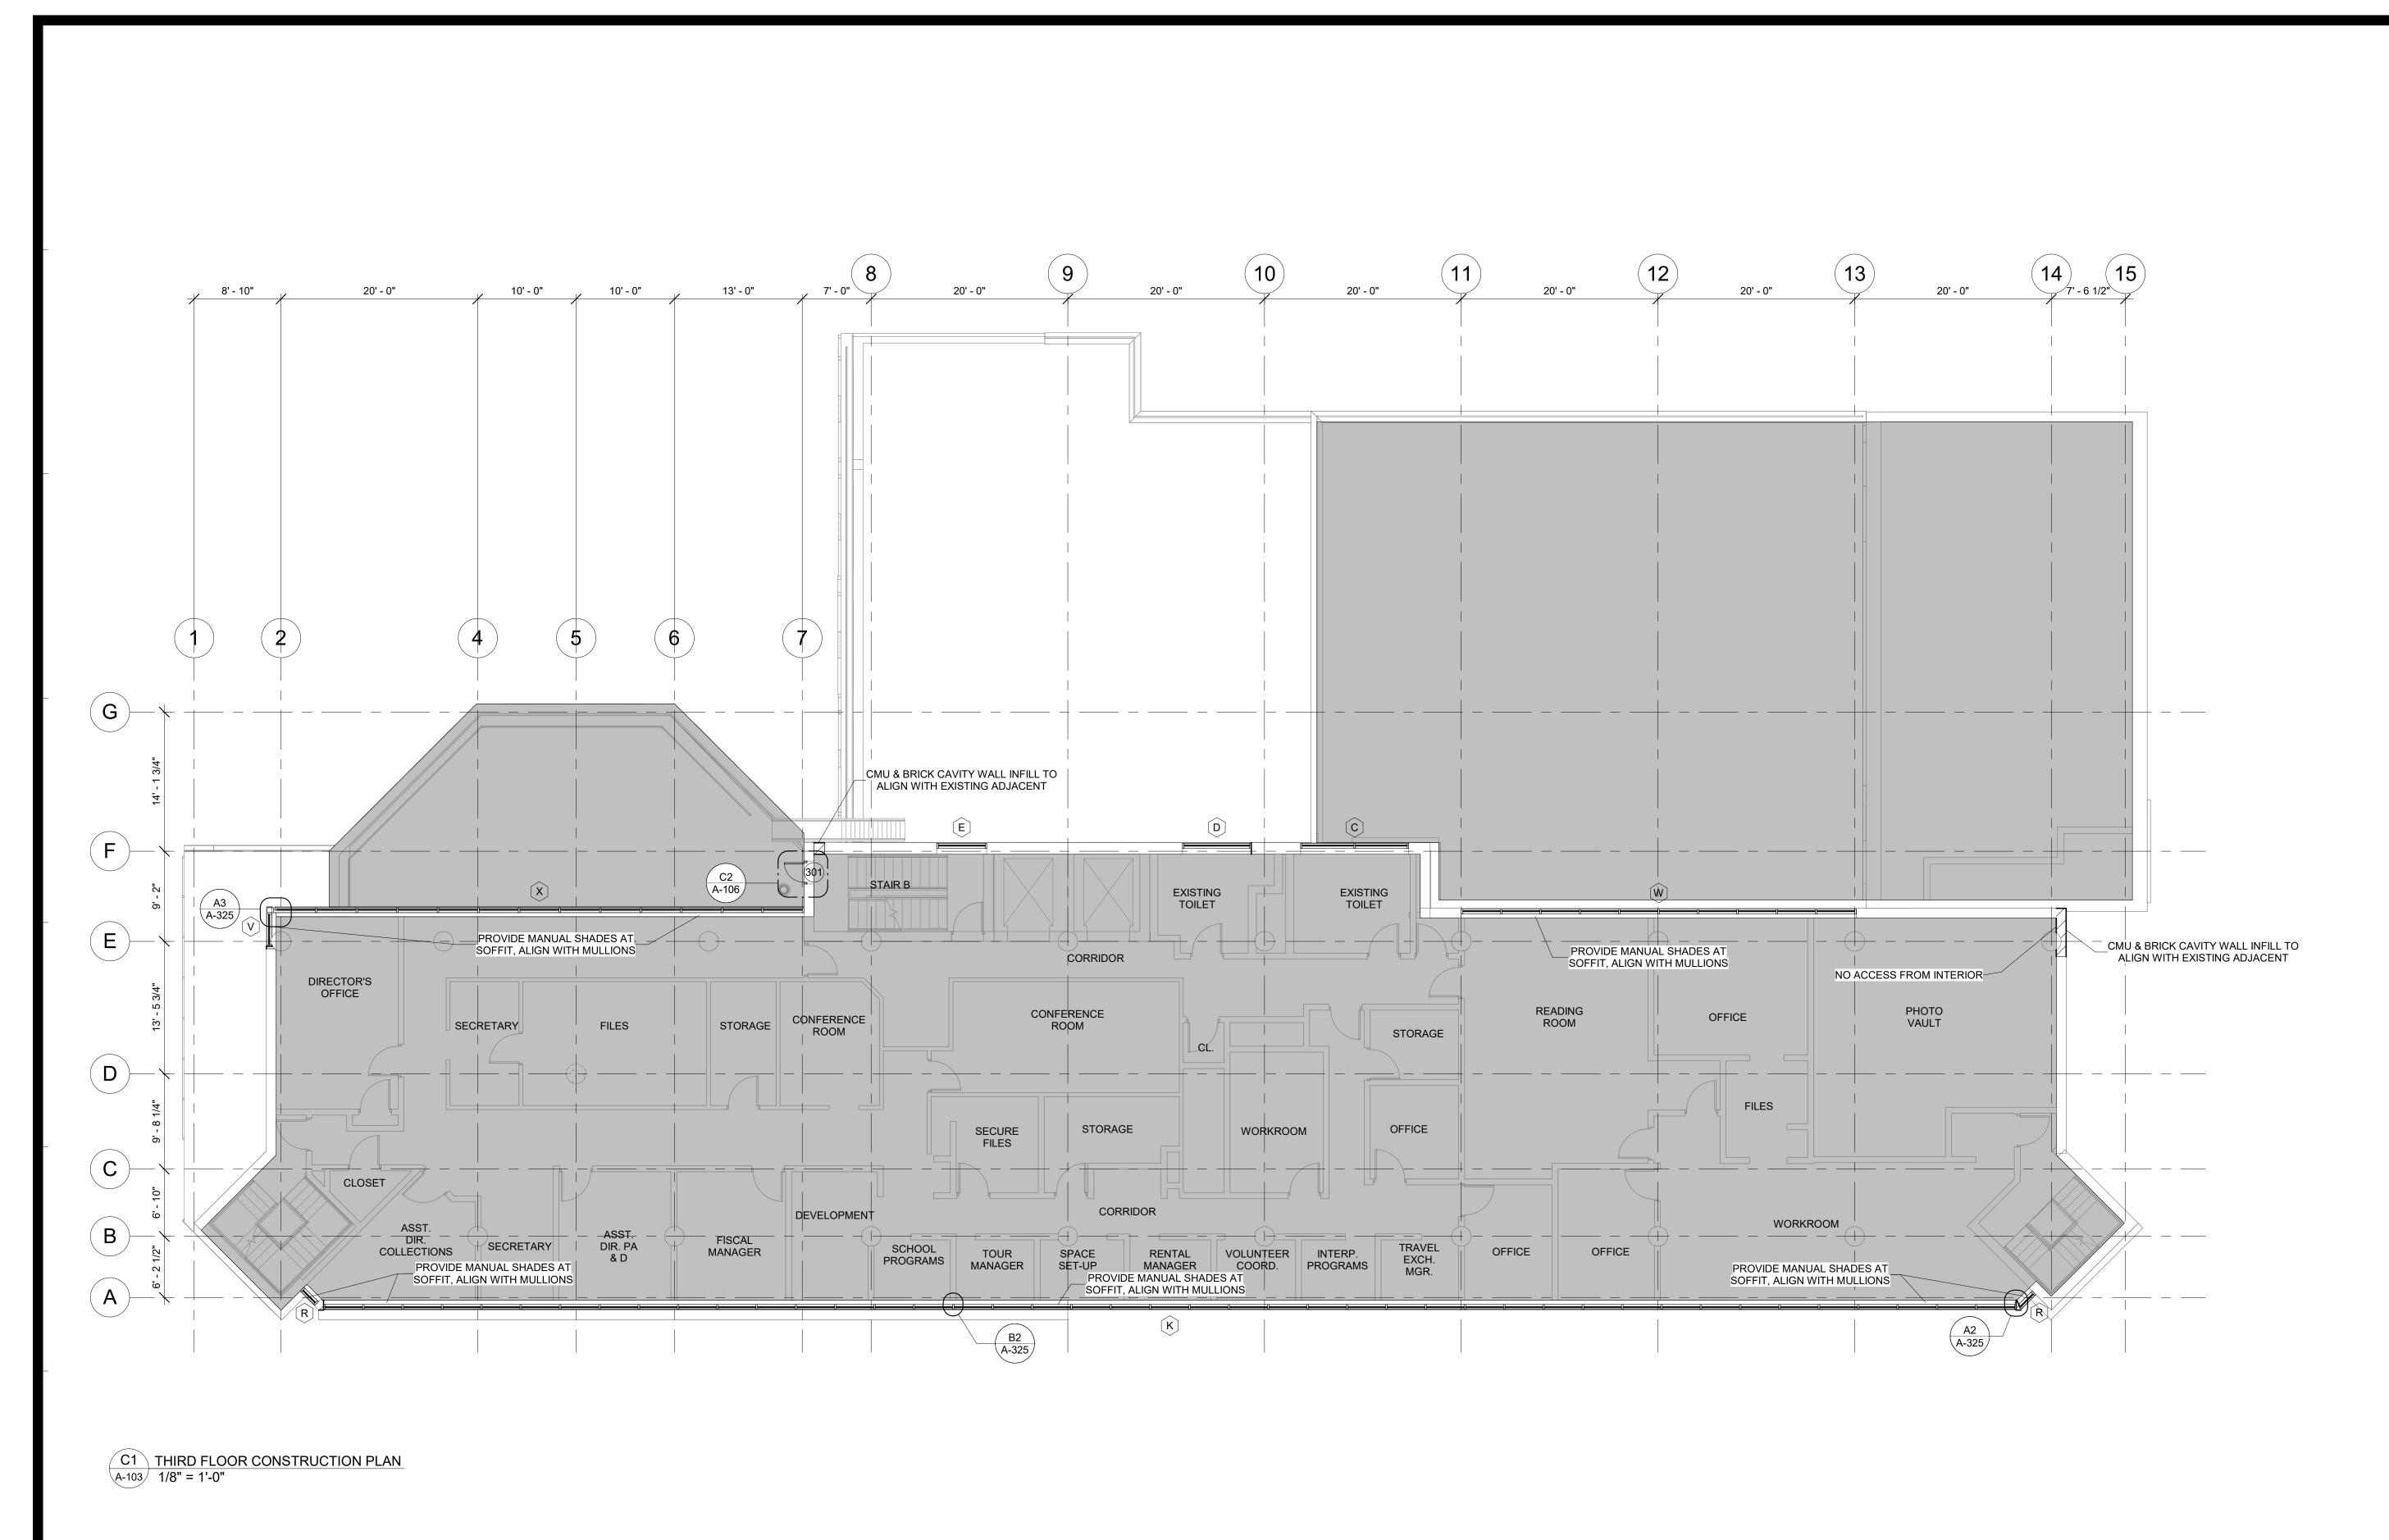


GENERAL NOTES:	LEGEND:	DOB APPROV
1. SEE A-610 FOR DOOR SCHEDULE. 2. SEE A-611 FOR EXTERIOR DOOR HEAD AND JAMB DETAILS. 3. TEMPORARY PROTECTION MEANS AND METHODS BY G.C. COORDINATE WITH OWNERSHIP ON EXTENTS AND PHASING. 4. SEE A-320 FOR WINDOW SCHEDULE	N.I.C. TYP.	
		SCALE: NTS
		PLANS REFLECT EXISTING CONDITIONS UNLESS OTHERWISE NOTED. ALL DIMENSIONS TO BE VERIFIED IN FIELD.



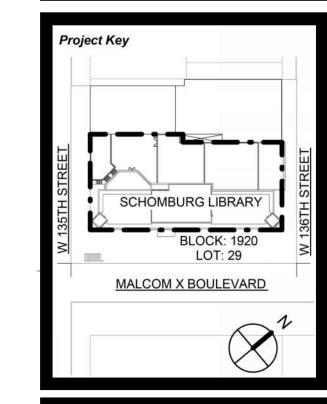

tion Date:
ı

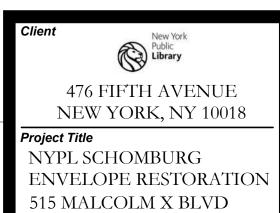





NEW YORK, NY 10037

Phase 90% CD SUBMISSION

Drawn By: Checked By:

Drawn By: Checked By: Date: 02/28/

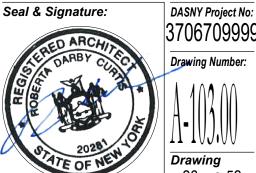

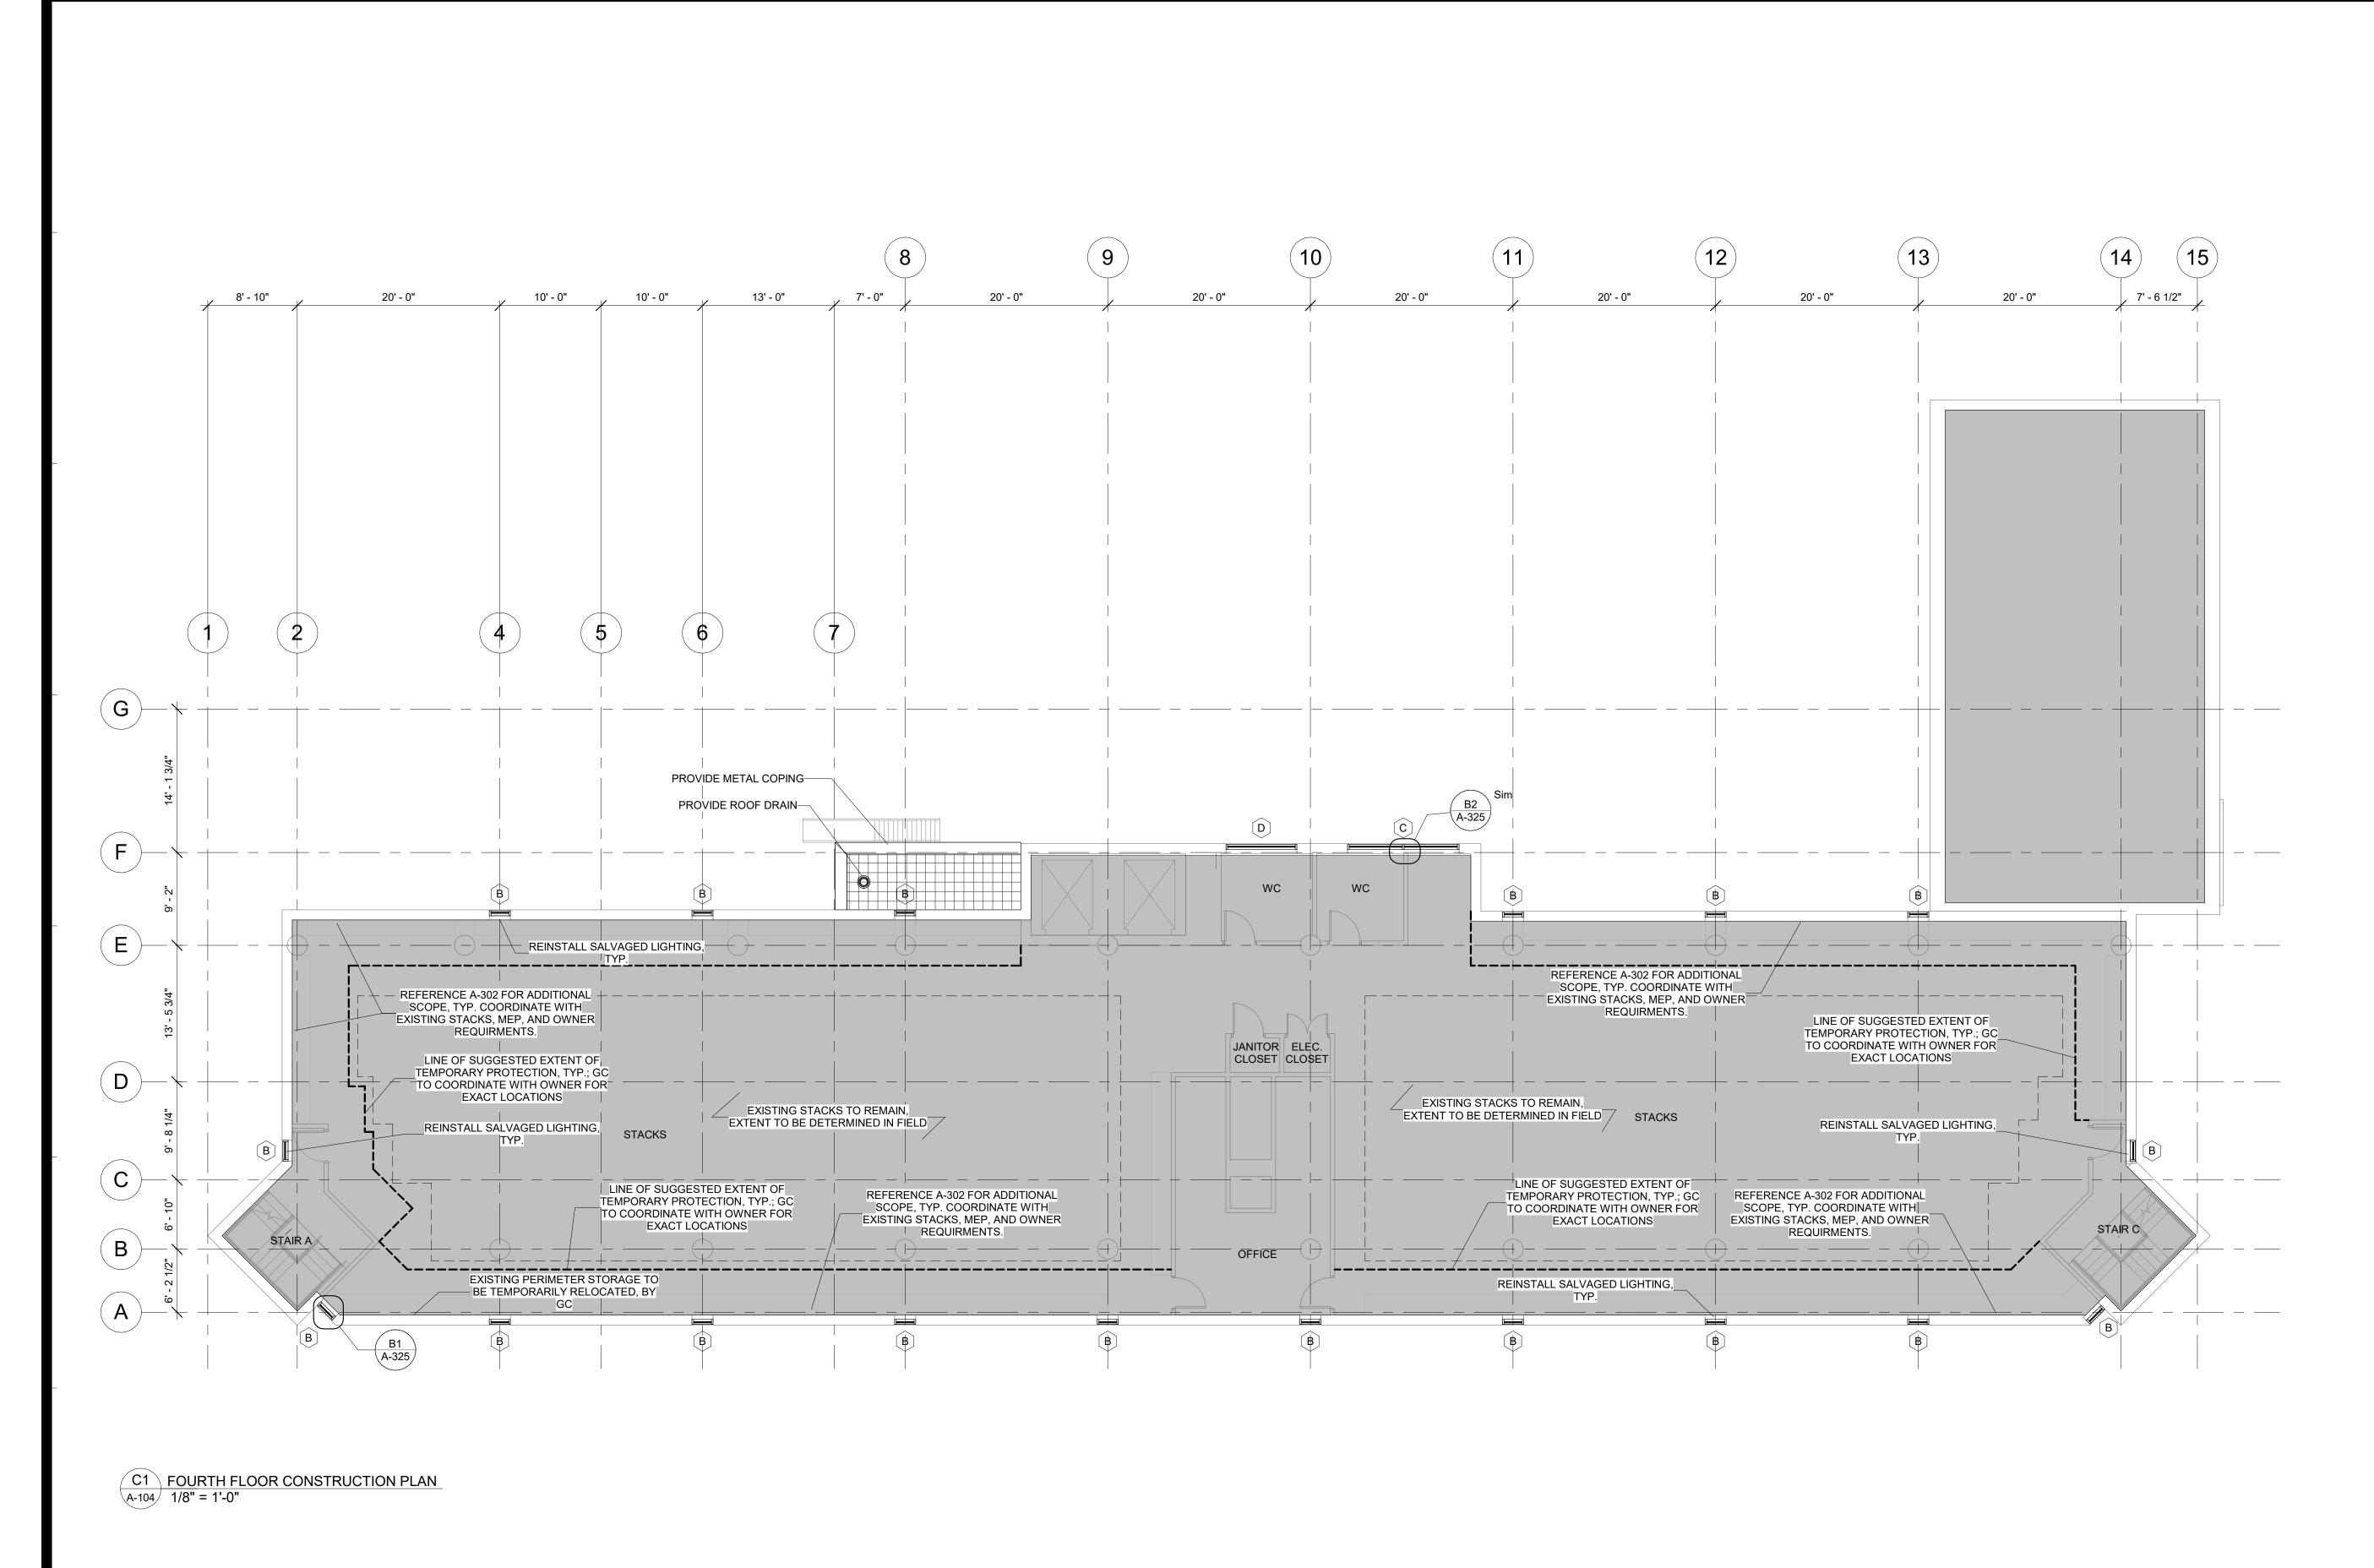

SENERAL NOTES:

1. SIET AND TO DOOR SOFFDILE
2. SIE AND TO PED TOOR SOFFDILE
3. SIE MORPH PROTECTION MEANS AND INJURIS DETAILS
3. SIE MORPH PROTECTION MEANS AND INJURIS DETAILS
4. SEE A 320 FOR WINDOW SCHEDULE


N.I.C. TYP.


DOB APPROVAL STAMPS

N.I.C. TYP.


DOB APPROVAL STAMPS

PLANS REFLECT EXISTING CONDITIONS UNLESS OTHERWISE NOTED. ALL DIMENSIONS TO BE
VERIFIED IN FIELD.

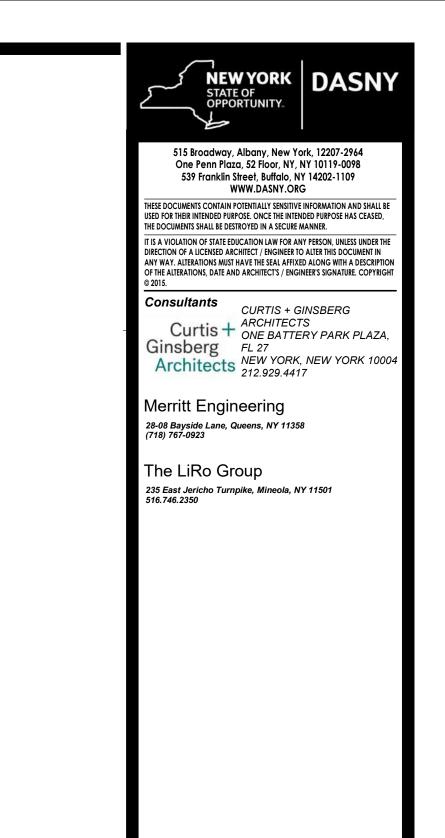


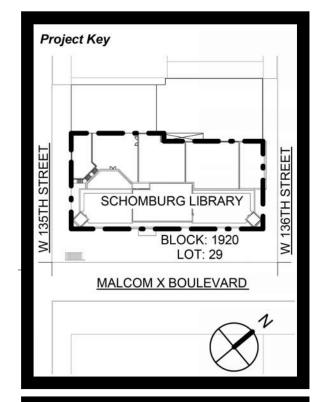



REVIS	SIONS	
Rev No	Description	Date:
1		
<u>2</u>		
<u>3</u>		
4		
<u>5</u>		
<u>6</u>		
<u> </u>		
<u>8</u>		
9		

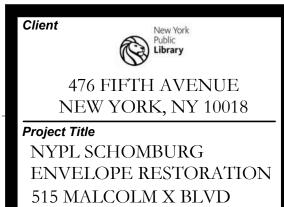


NEW YORK, NY 10037

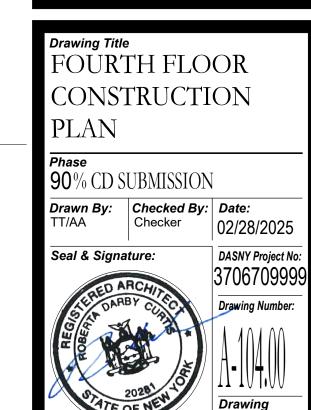

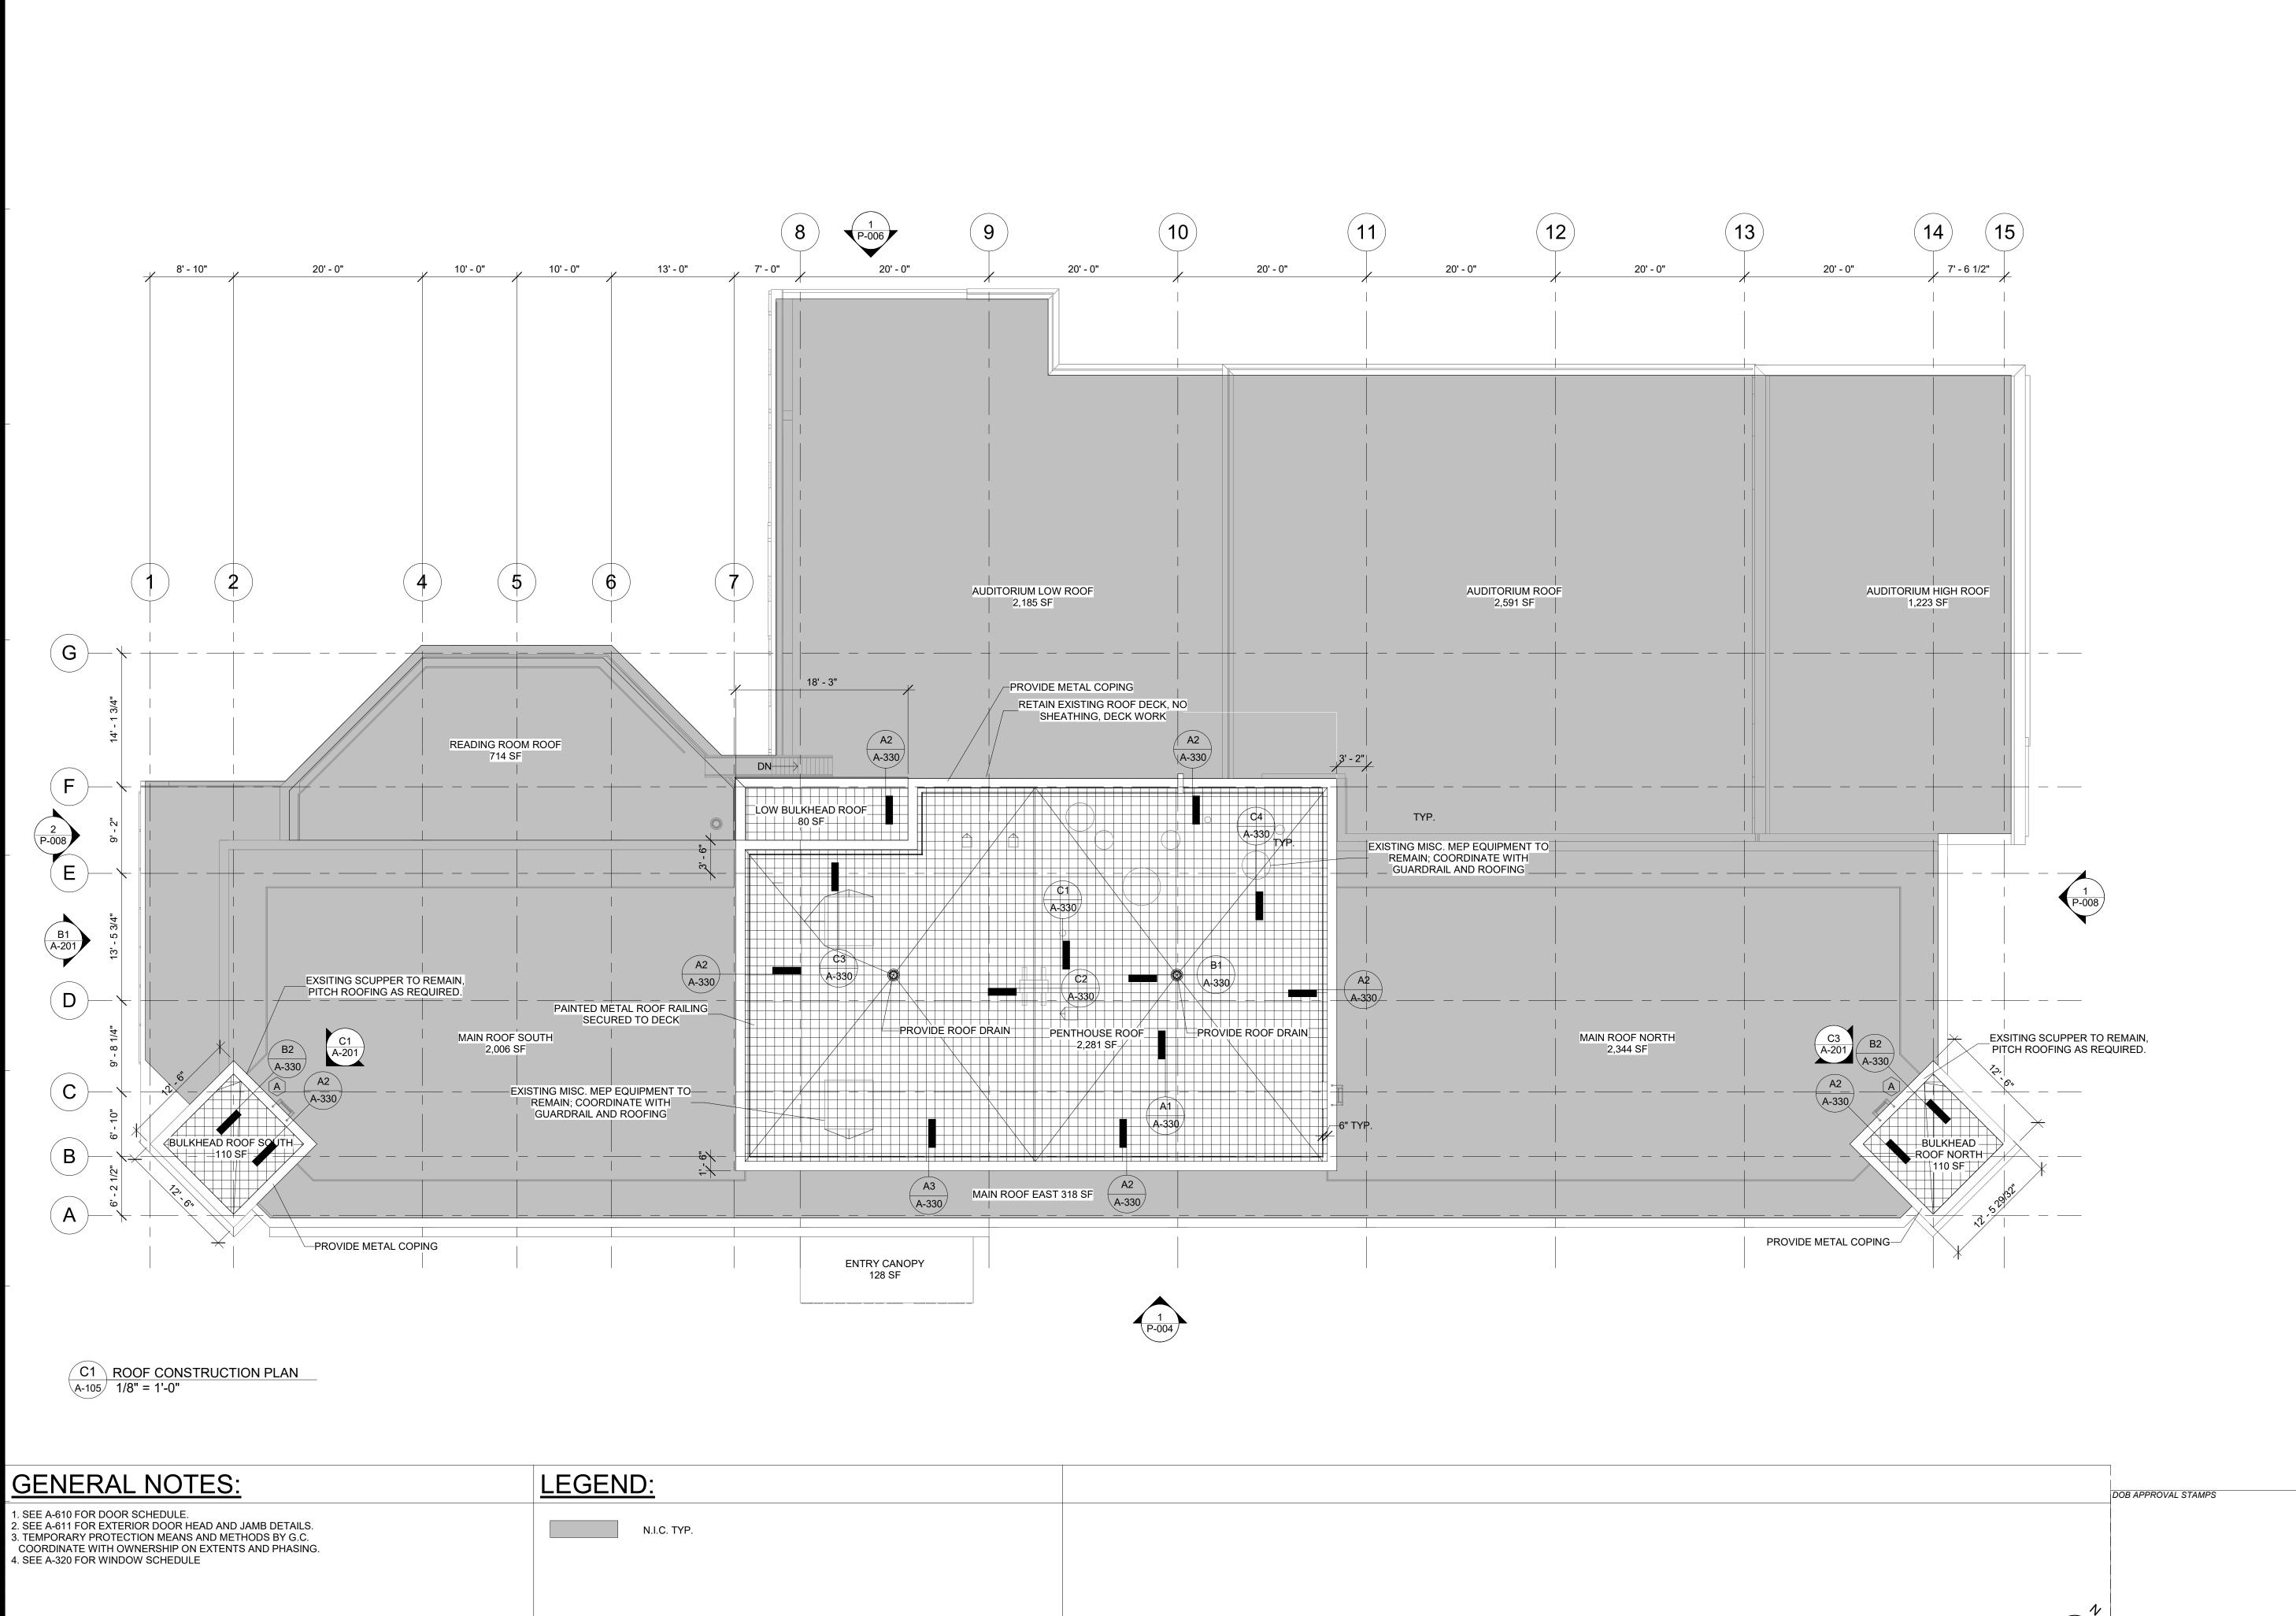

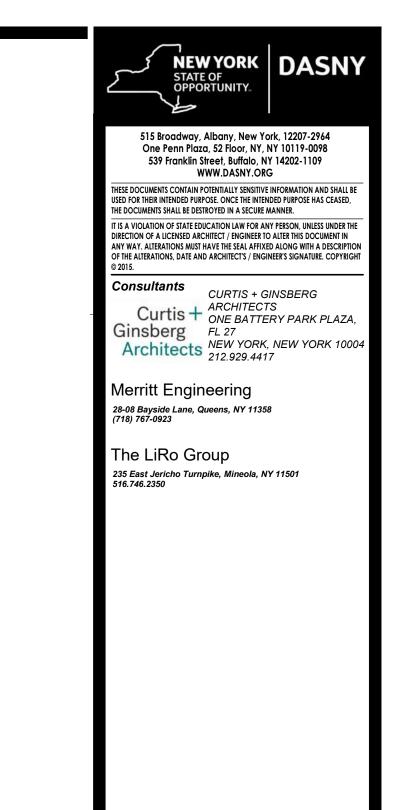

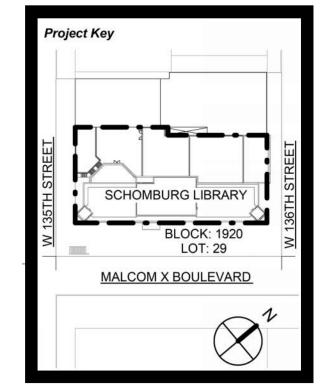

Rev No	Description	Date:
<u> </u>		
2		
3		
4		
<u>5</u>		
<u>6</u>		
<u> </u>		
8		
9		





Project Title
NYPL SCHOMBURG
ENVELOPE RESTORATION
515 MALCOLM X BLVD
NEW YORK, NY 10037


ROOF CONS		ON
Phase 90% CD 3	SUBMISSION	
Drawn By: TT/AA	Checked By: DC/RE	Date: 02/28/2025
Seal & Sign		DASNY Project N 37067099
SEL DAF	ARCHITECT	Drawing Number

SCALE: NTS


PLANS REFLECT EXISTING CONDITIONS UNLESS OTHERWISE NOTED. ALL DIMENSIONS TO BE VERIFIED IN FIELD.

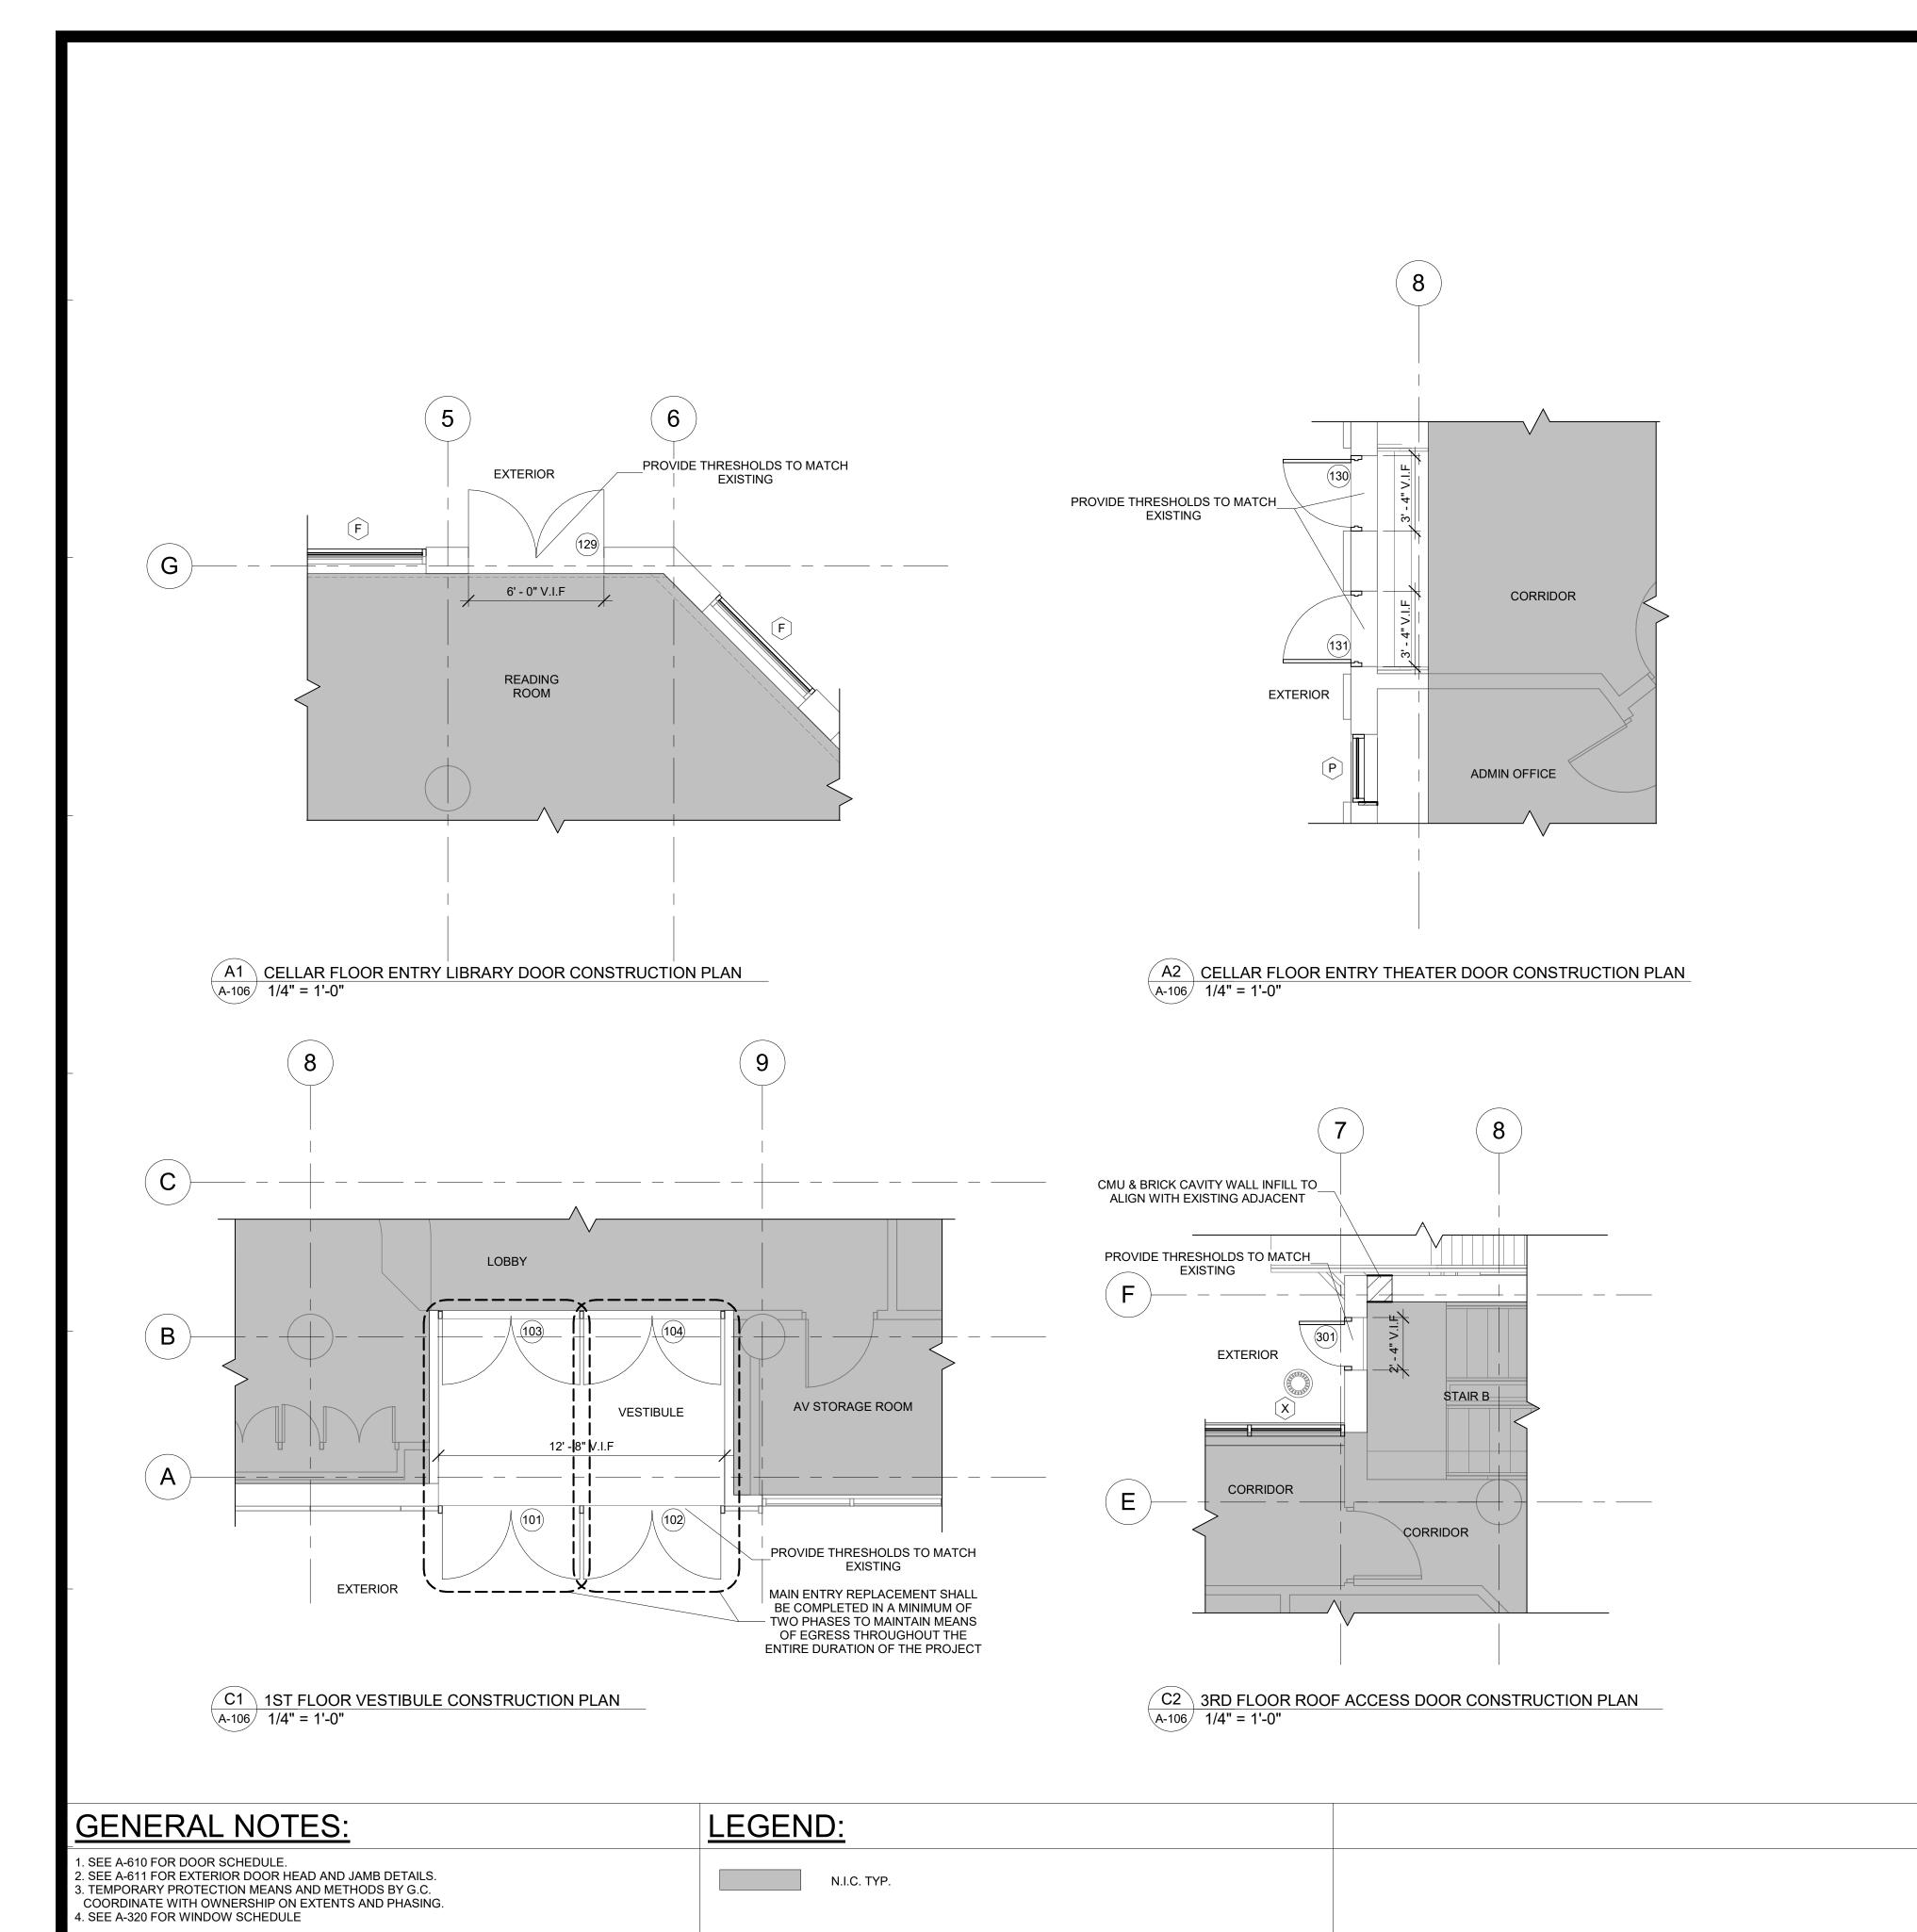

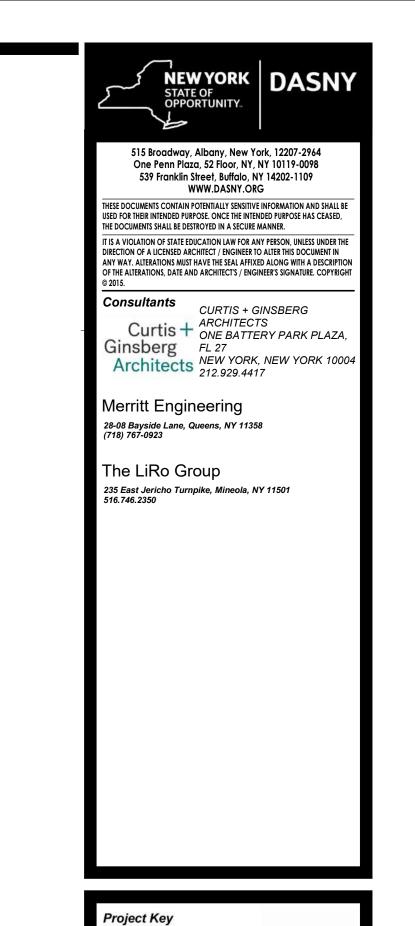


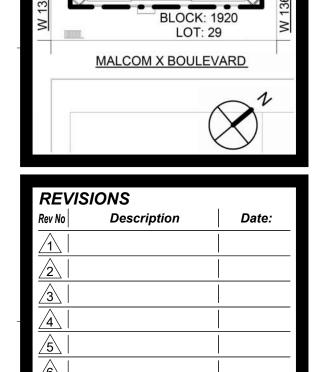

SCHOMBURG LIBRARY

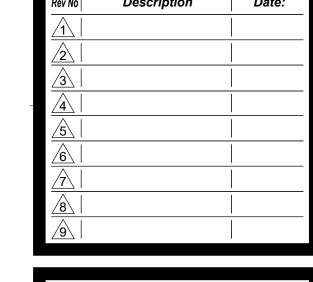



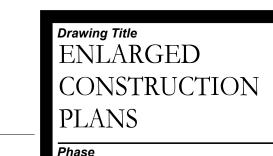



90% CD SUBMISSION Drawn By:Checked By:Date:TT/AADC / SL02/28/-


Seal & Signature:



SCALE: NTS

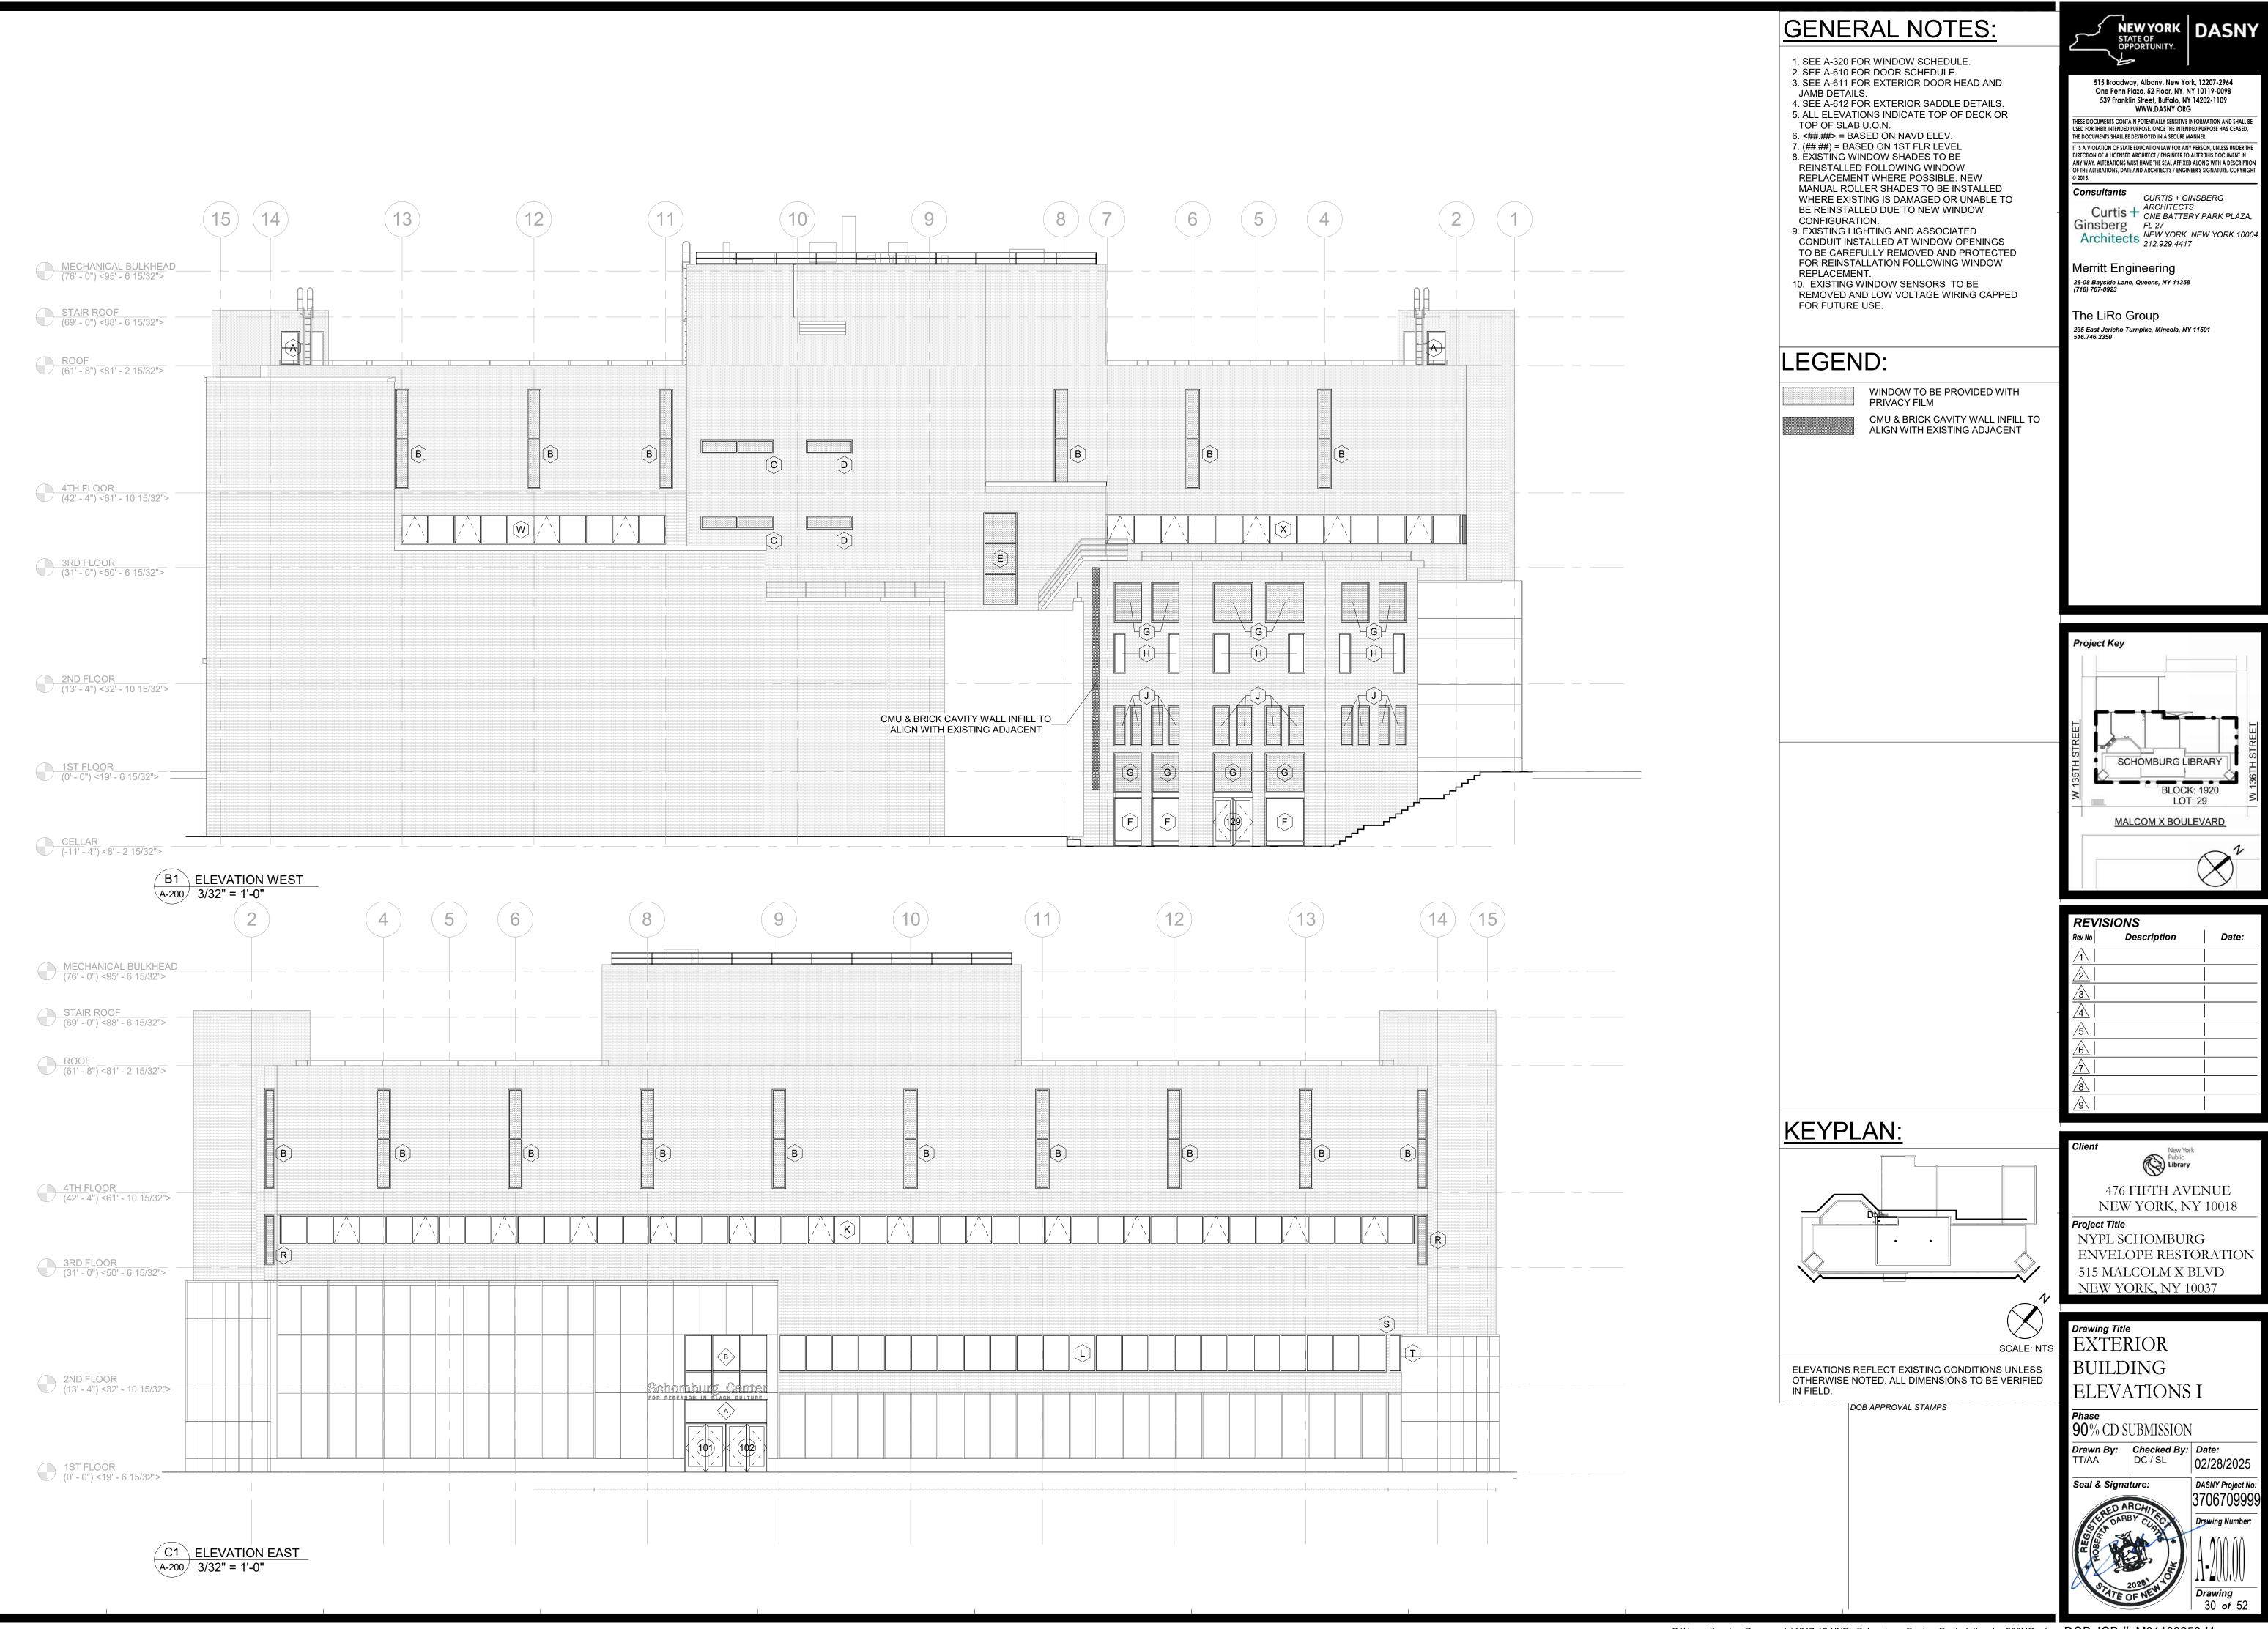


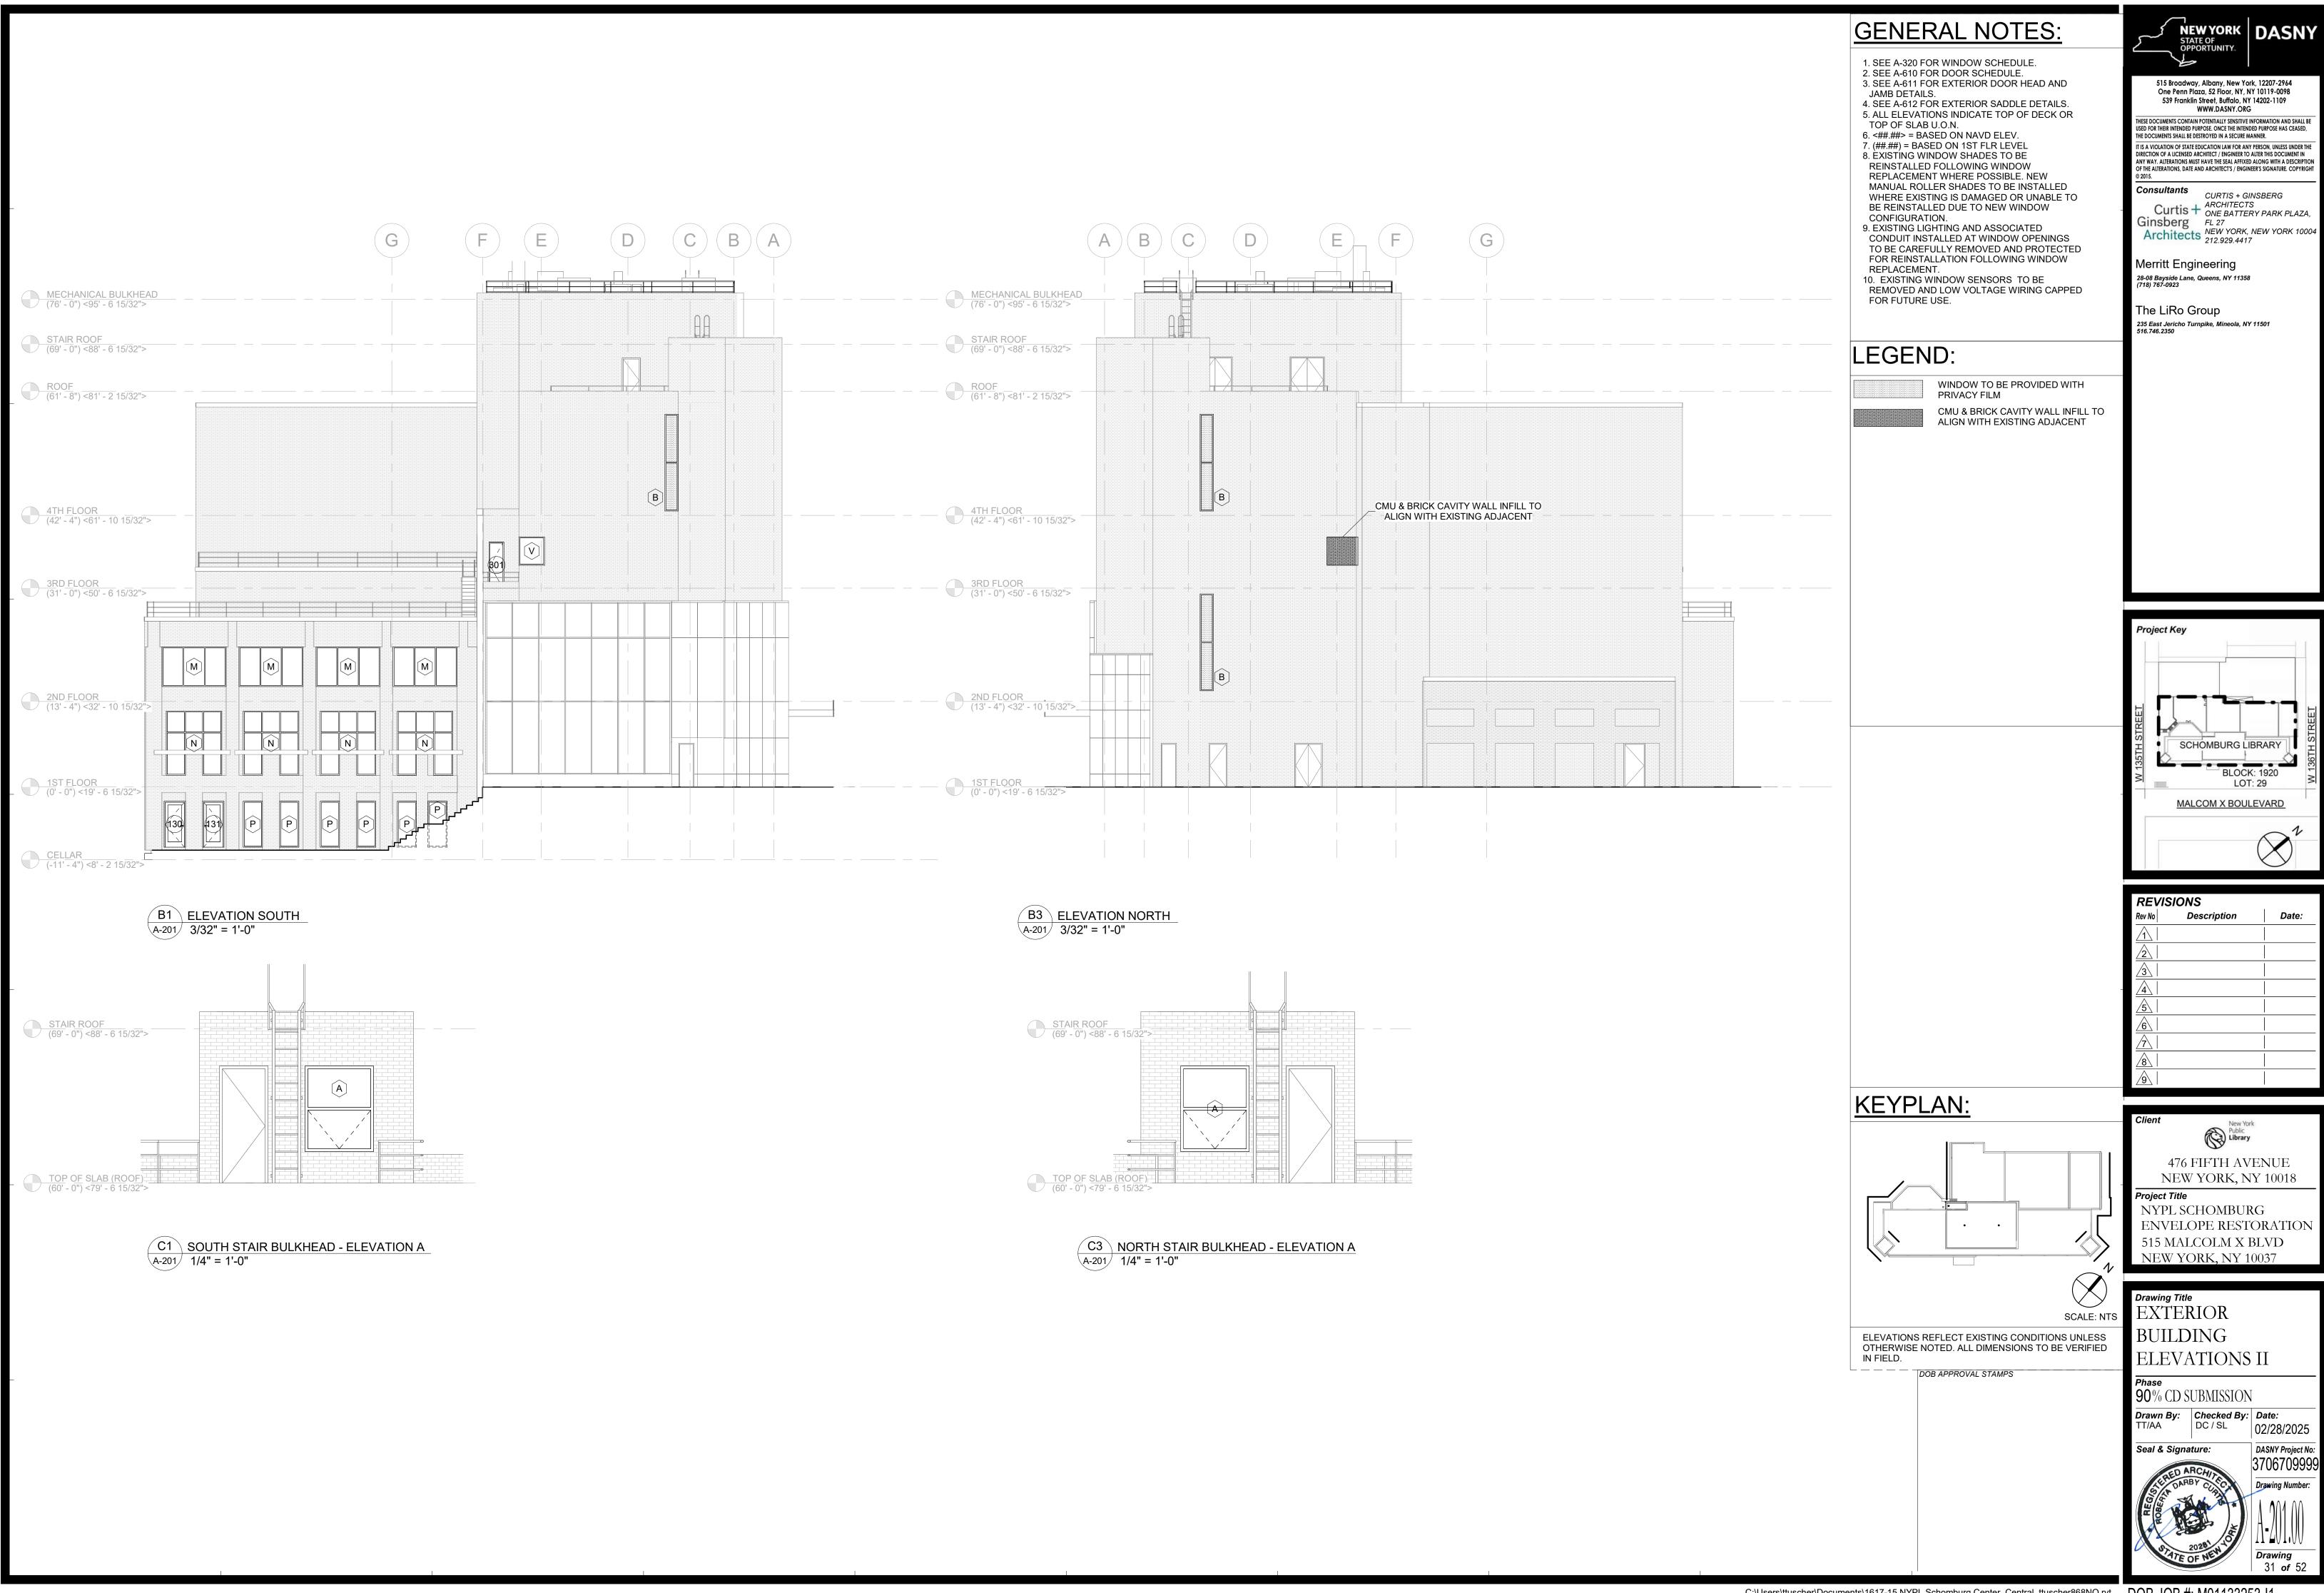

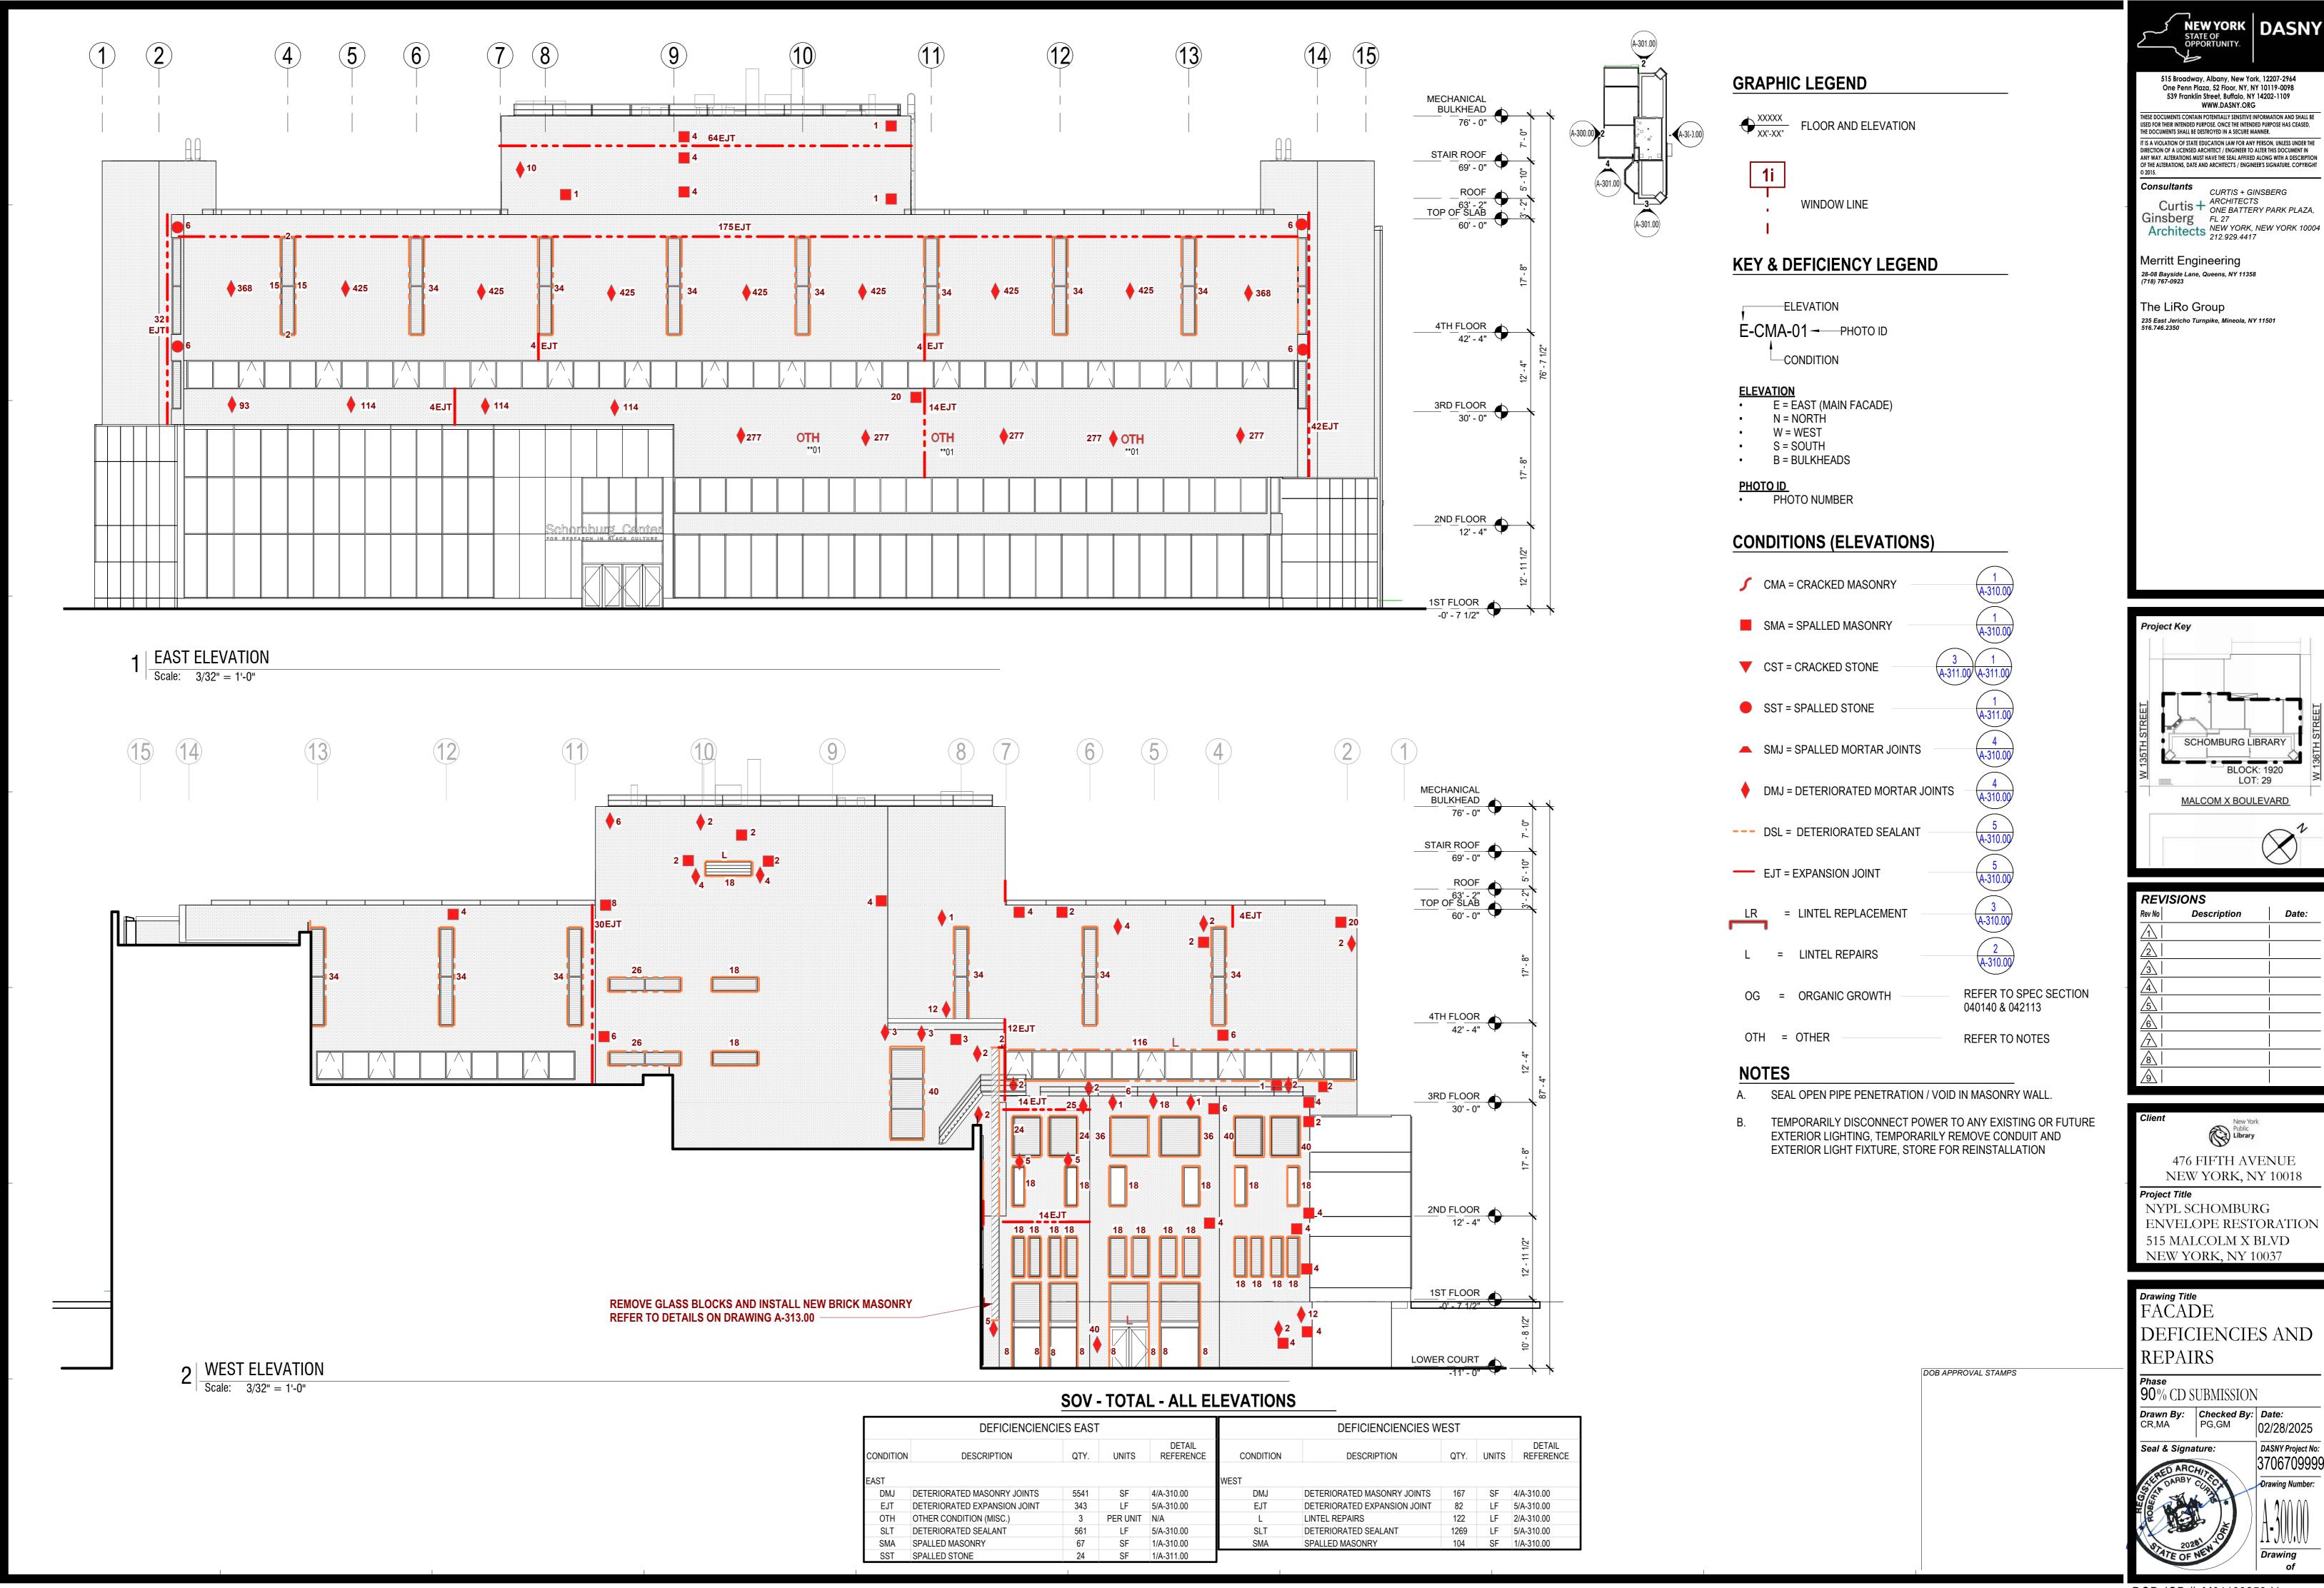

Rev No	Description	Date:
$\overline{\Lambda}$		
2		
3		
4		
<u>5</u>		
6		
<u></u>		
8		
<u></u>		

ENVELOPE RESTORATION

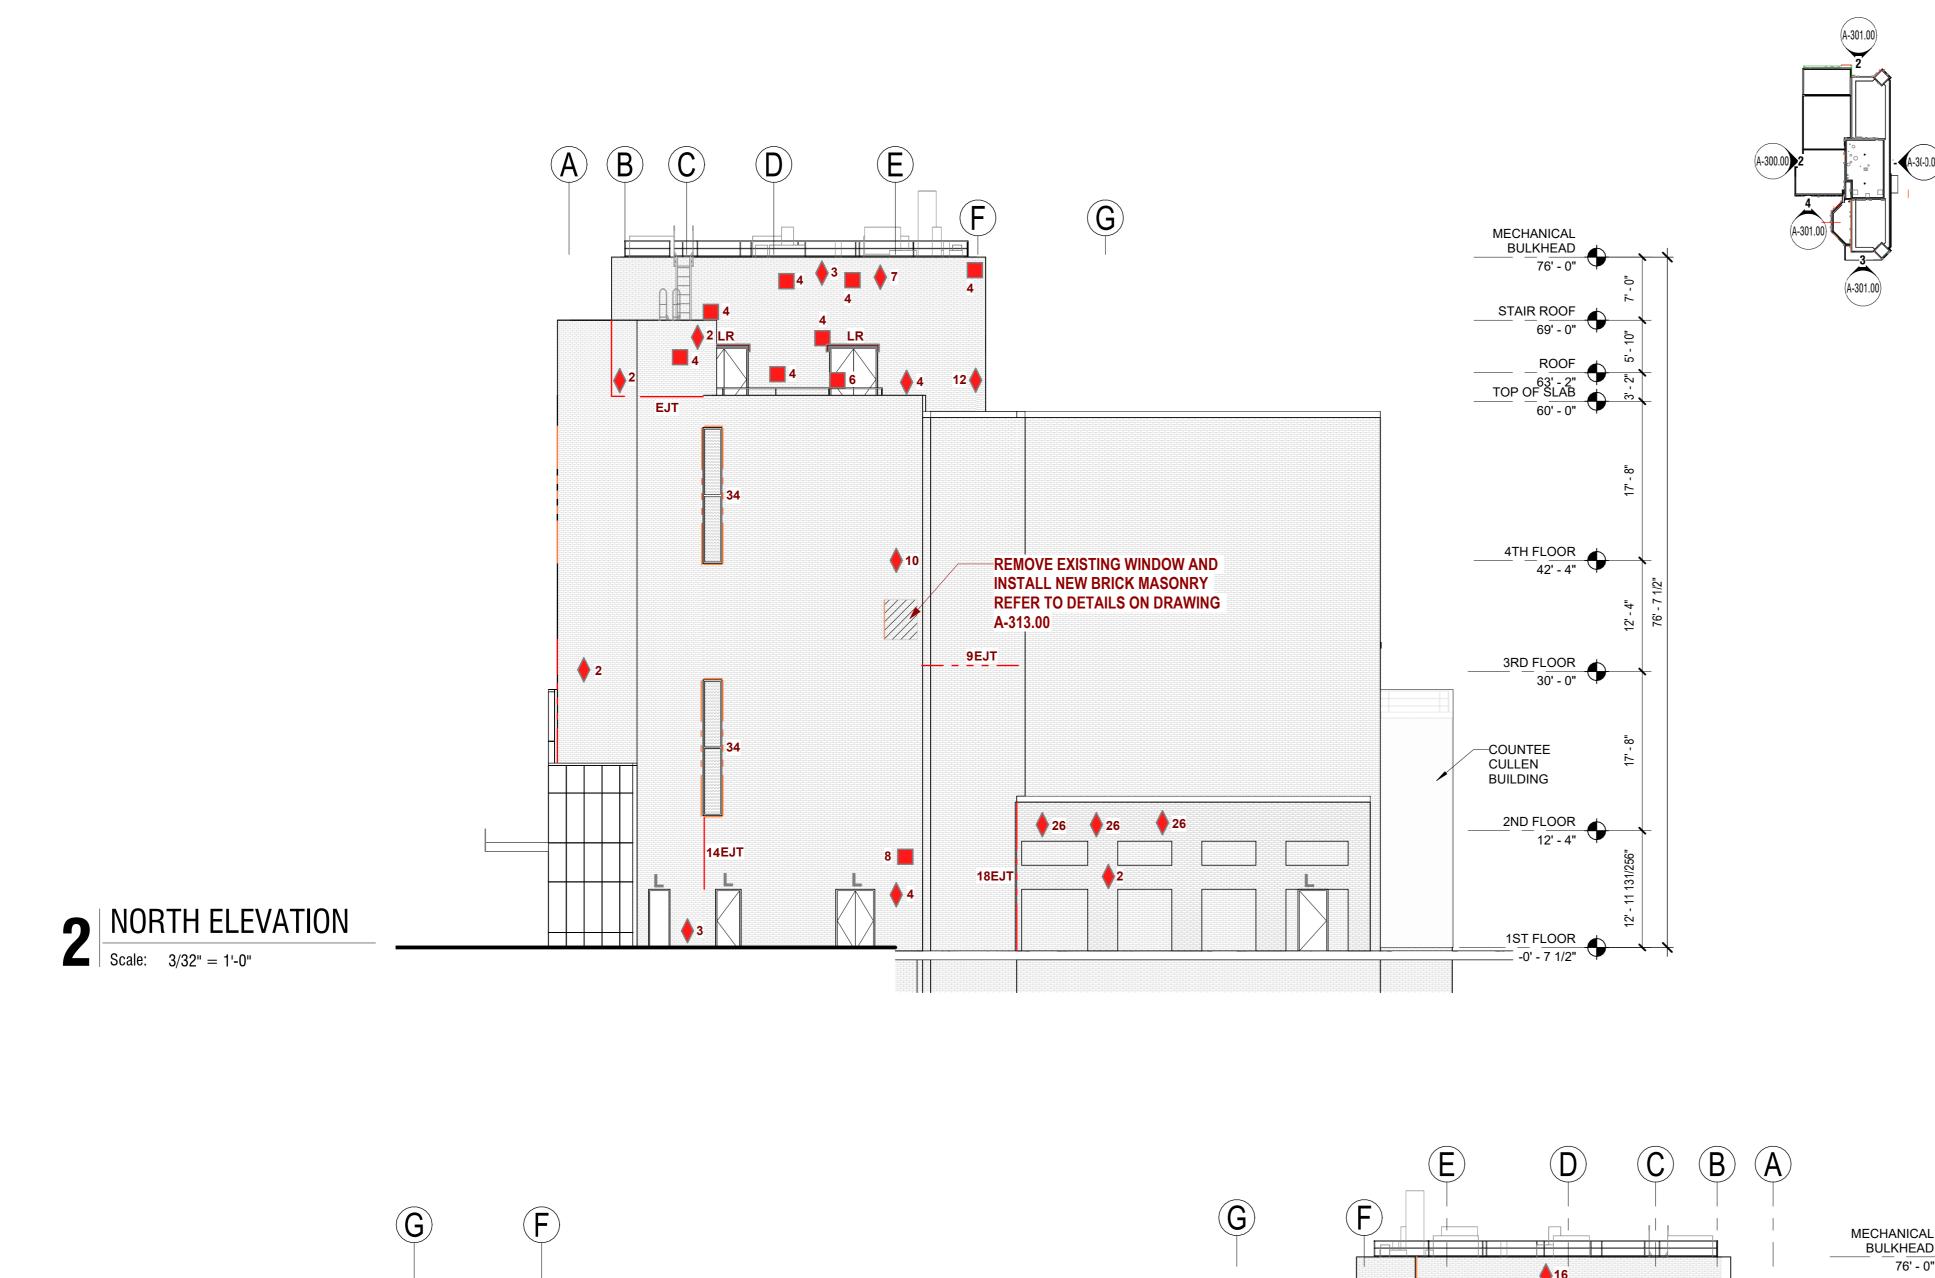

4 EJT

SOUTH - COURTYARD


Scale: 3/32" = 1'-0"

2ND FLOOR 12' - 4"

1ST FLOOR -0' - 7 1/2"

SOUTH ELEVATION

Scale: 3/32" = 1'-0"

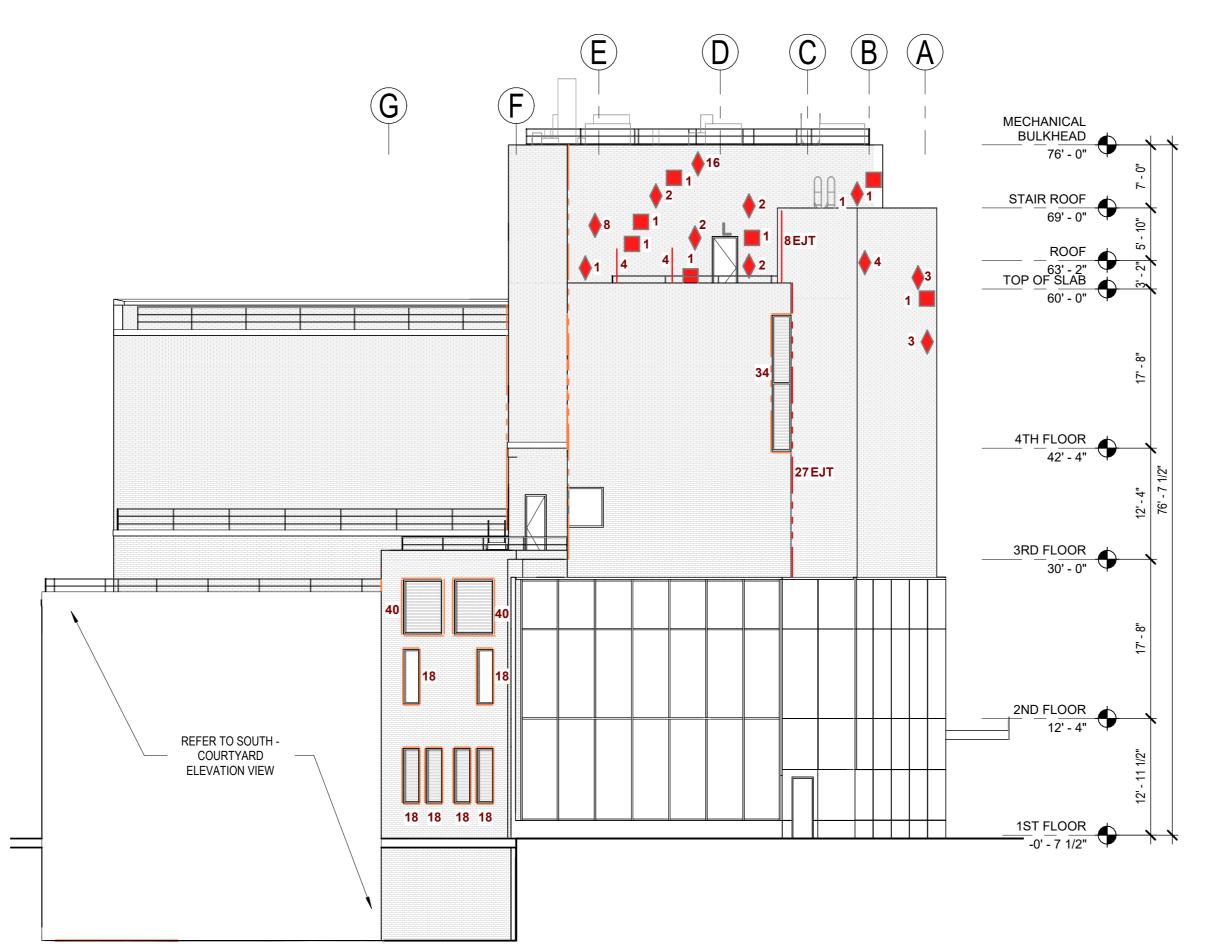

GRAPHIC LEGEND

TXXXXX FLOOR AND ELEVATION




WINDOW LINE

ELEVATION

• E = EAST (MAIN FACADE) N = NORTH

PHOTO ID PHOTO NUMBER

CONDITIONS (ELEVATIONS)

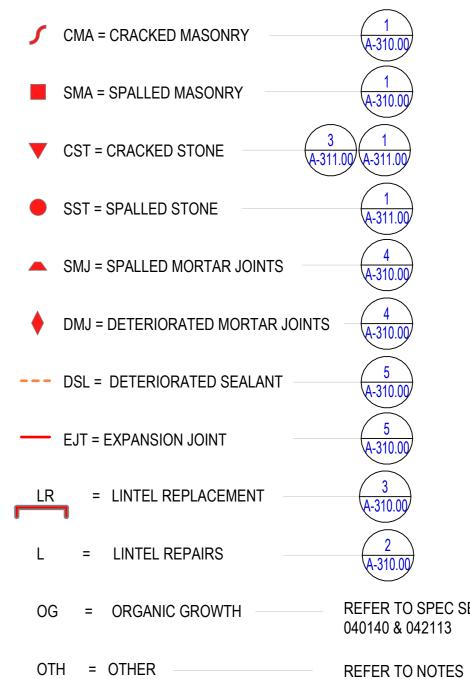

NOTES

- SEAL OPEN PIPE PENETRATION / VOID IN MASONRY WALL.
- TEMPORARILY DISCONNECT POWER TO ANY EXISTING OR FUTURE EXTERIOR LIGHTING, TEMPORARILY REMOVE CONDUIT AND EXTERIOR LIGHT FIXTURE, STORE FOR REINSTALLATION

SOV - TOTAL - ALL ELEVATIONS

	DEFICIENCIENCIES N	ORTH		
CONDITION	DESCRIPTION	QTY	UNITS	DETAIL REFERENC
NORTH				
DMJ	DETERIORATED MASONRY JOINTS	129	SF	4/A-310.00
EJT	DETERIORATED EXPANSION JOINT	66	LF	5/A-310.00
L	LINTEL REPAIRS	19	LF	2/A-310.00
LR	LINTEL REPLACEMENT	14	LF	3/A-310.00
	DETERIORATED CEALANT	128	<varies></varies>	<varies></varies>
SLT	DETERIORATED SEALANT	120	141100	


	DEFICIENCIENCIES SO	IITH		
	DEI IOIENOIENOIES SO	UIII		
CONDITION	DESCRIPTION	QTY.	UNITS	DETAIL REFERENCE
SOUTH				
CMA	CRACKED MASONRY	8	SF	1/A-310.00
CST	CRACKED STONE	36	SF	5/A-311.00
DMJ	DETERIORATED MASONRY JOINTS	44	SF	4/A-310.00
EJT	DETERIORATED EXPANSION JOINT	142	LF	5/A-310.00
L	LINTEL REPAIRS	76	LF	2/A-310.00
LR	LINTEL REPLACEMENT	48	LF	3/A-310.00
SLT	DETERIORATED SEALANT	646	LF	5/A-310.00
SMA	SPALLED MASONRY	7	SF	1/A-310.00

DOB APPROVAL STAMPS

KEY & DEFICIENCY LEGEND


-ELEVATION E-CMA-01 - PHOTO ID CONDITION

W = WEST S = SOUTH • B = BULKHEADS

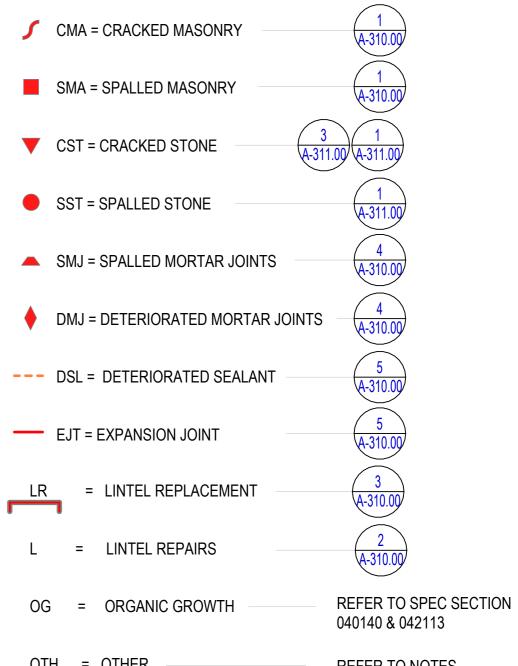


	DEFICIENCIENCIES SO	UTH		
CONDITION	DESCRIPTION	QTY.	UNITS	DETAIL REFERENCE
SOUTH				
CMA	CRACKED MASONRY	8	SF	1/A-310.00
CST	CRACKED STONE	36	SF	5/A-311.00
DMJ	DETERIORATED MASONRY JOINTS	44	SF	4/A-310.00
EJT	DETERIORATED EXPANSION JOINT	142	LF	5/A-310.00
L	LINTEL REPAIRS	76	LF	2/A-310.00
LR	LINTEL REPLACEMENT	48	LF	3/A-310.00
SLT	DETERIORATED SEALANT	646	LF	5/A-310.00
SMA	SPALLED MASONRY	7	SF	1/A-310.00



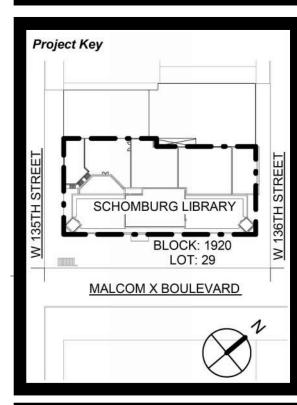


IONS	f _
Description	Date:
	Description

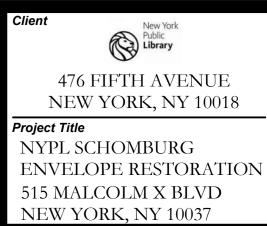



Phase 90% CD SUBMISSION Drawn By: Checked By: Date: 02/28/2025



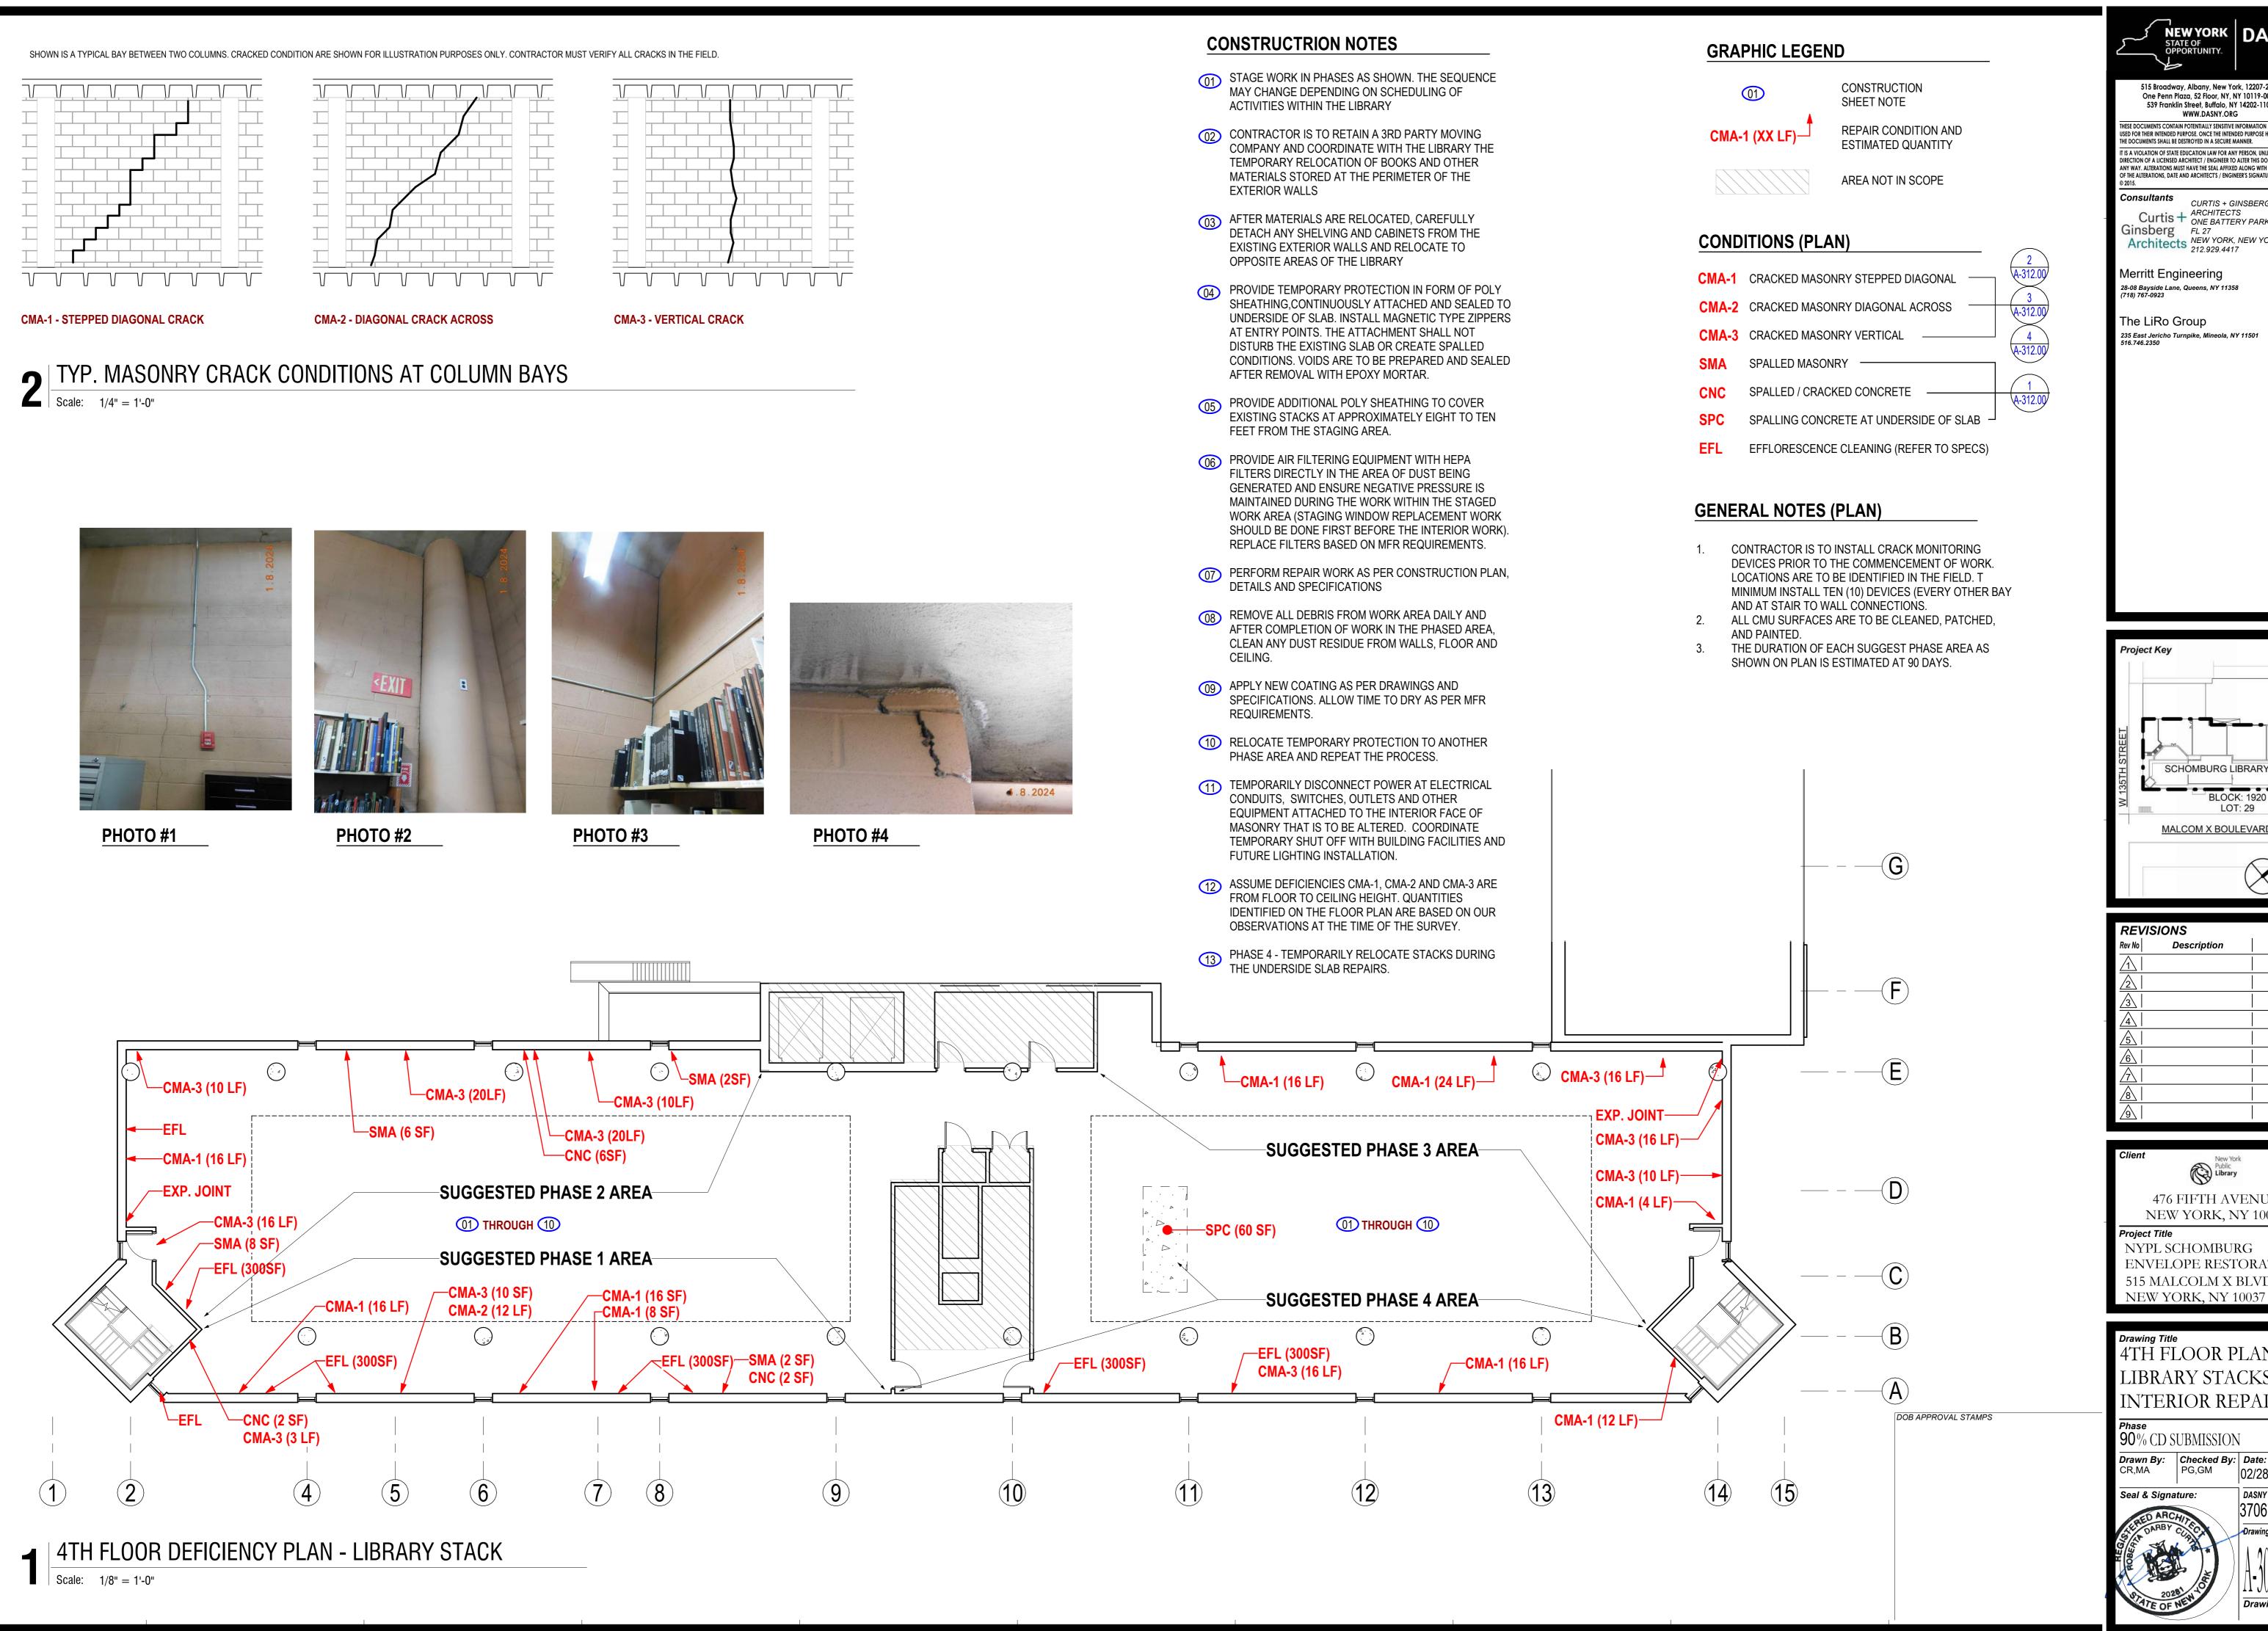

NEW YORK DASNY

515 Broadway, Albany, New York, 12207-2964 One Penn Plaza, 52 Floor, NY, NY 10119-0098 539 Franklin Street, Buffalo, NY 14202-1109


WWW.DASNY.ORG

SE DOCUMENTS CONTAIN POTENTIALLY SENSITIVE INFORMATION AND SHALL BE USED FOR THEIR INTENDED PURPOSE. ONCE THE INTENDED PURPOSE HAS CEASED, THE DOCUMENTS SHALL BE DESTROYED IN A SECURE MANNER. IS A VIOLATION OF STATE EDUCATION LAW FOR ANY PERSON, UNLESS UNDER TH DIRECTION OF A LICENSED ARCHITECT / ENGINEER TO ALTER THIS DOCUMENT IN ANY WAY. ALTERATIONS MUST HAVE THE SEAL AFFIXED ALONG WITH A DESCRIPTION THE ALTERATIONS, DATE AND ARCHITECT'S / ENGINEER'S SIGNATURE. COPYRIG

CURTIS + GINSBERG Curtis + ARCHITECTS
ONE BATTERY PARK PLAZA, Ginsberg FL 27 Architects NEW YORK, NEW YORK 10004 212.929.4417

Merritt Engineering 28-08 Bayside Lane, Queens, NY 11358

The LiRo Group 235 East Jericho Turnpike, Mineola, NY 11501

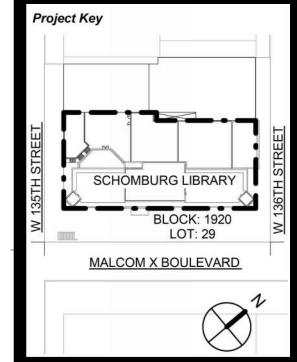

REVIS	IONS	
Rev No	Description	Date:
<u> </u>		
2		
<u>3</u>		
4		
<u>5</u>		
<u>6</u>		
<u> </u>		
<u>8</u>		
<u> </u>		



Project Title NYPL SCHOMBURG ENVELOPE RESTORATION 515 MALCOLM X BLVD


Drawing Title 4TH FLOOR PLAN LIBRARY STACKS INTERIOR REPAIRS

90% CD SUBMISSION

Drawn By:Checked By:Date:CR,MAPG,GM02/28/2 02/28/2025

> DASNY Project No: 3706709999



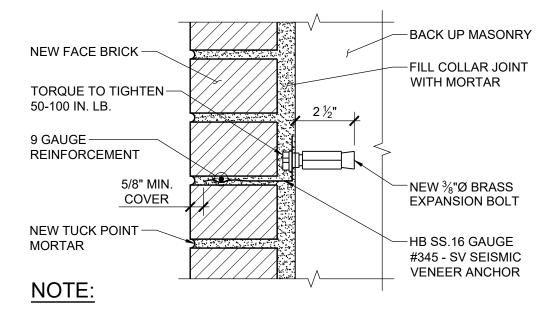


1. INSTALL MASONRY ANCHORS @ 16" O.C. VERTICALLY AND HORIZONTALLY

SECTION A-A

NOTES FOR ALL DETAILS:

- 1. REPLACE HATCHED BRICKED WITH NEW TO MATCH EXISTING. 2. DO NOT REPLACE HEADER BRICKS. COORDINATE WITH THE ENGINEER IF CRACKED OR SPALLED HEADER BRICKS ARE FOUND.
- 3. ALL JOINTS BETWEEN THE EXISTING AND NEW BRICK, HEAD, BED AND COLLAR (INCLUDING THE BACKUP WALL) ARE TO BE FILLED
- WITH NEW MORTAR AS PER SPECIFICATIONS. 4. INSTALL MASONRY ANCHORS @ 16" O.C. VERTICALLY AND HORIZONTALLY.

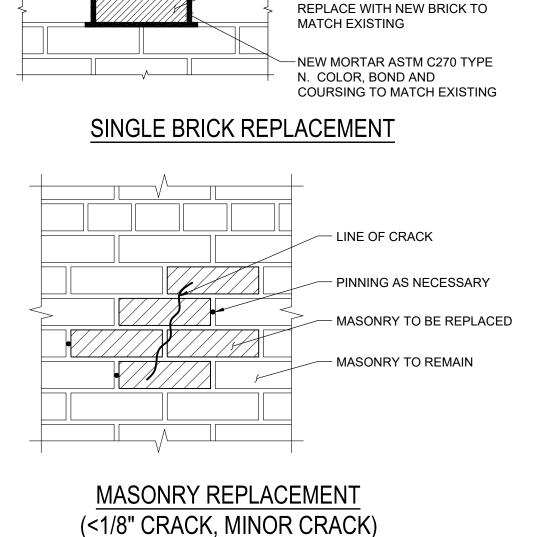



EXISTING BRICK TO REMAIN

CRACKED BRICK AND

-REMOVE EXISTING SPALLED OR

SURROUNDING MORTAR AND

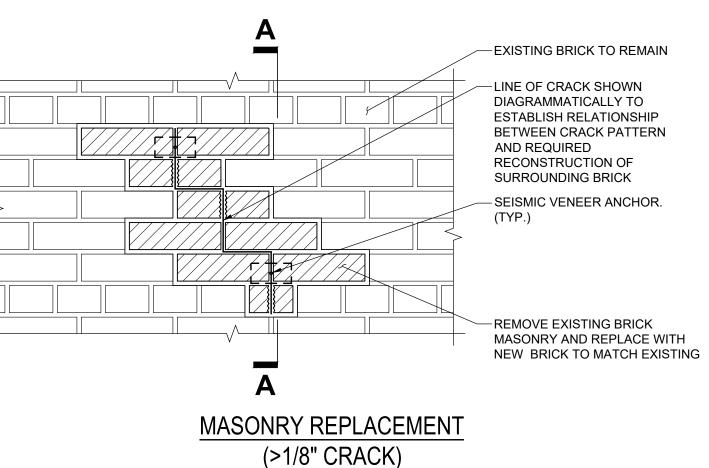

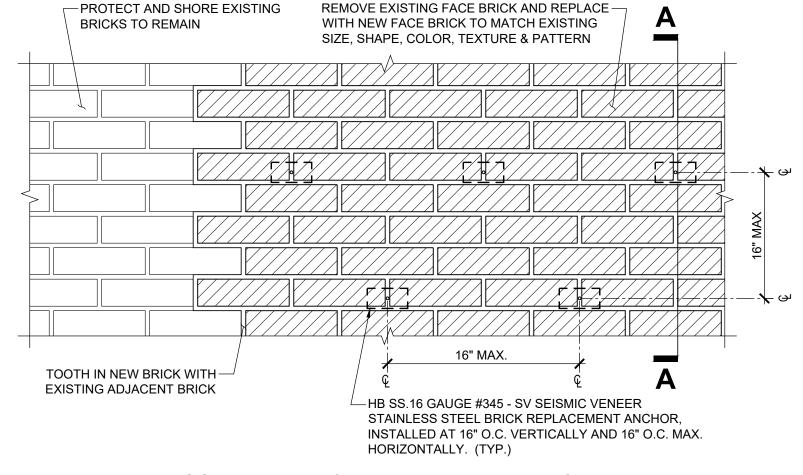

MASONRY REPLACEMENT IN THE FIELD OF WALL (SPALLING AND/OR CRACKED MASONRY BRICK)

·EXISTING BRICK. PROVIDE TEMPORARY SHORING.

- REPLACE BRICK TO MATCH EXISTING

CLEAN BACKUP MASONRY AND REMOVE ANY LARGE IRREGULARITIES

-LINTEL SIZE AND ATTACHMENT TO BE V.I.I


-NEW DRIP EDGE FLASHING SET IN BITUMEN

REPLACE DAMAGED MASONRY AT OPENING JAMBS

-EXISTING DOOR OR WINDOW FRAME TO REMAIN

PROVIDE NEW SEALANT

TYP. BRICK MASONRY REPLACEMENT DETAILS SCALE: N.T.S

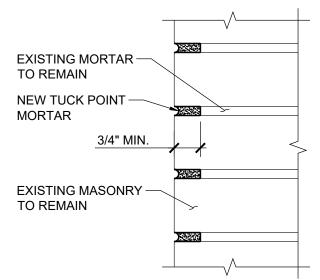

NOTES:

- 1. GRIND OUT EXISTING JOINT TO A MINIMUM DEPTH
- 2. FLUSH OUT ALL LOOSE MATERIAL WITH A WATER SPRAYER. PREHYDRATE TYPE N MORTAR (AS PER ASTM 270)

BY MIXING MORTAR DRY. MIX AGAIN WITH ONLY


ENOUGH WATER TO PROVIDE A DAMP MIX. AFTER


- ONE HOUR. ADD ENOUGH WATER TO PROVIDE A WORKABLE MORTAR. 4. DO NOT USE MORTAR AFTER THREE (3) HOURS
- FROM INITIAL ADDITION OF WATER. 5. LIGHTLY WET MORTAR JOINT (NO VISIBLE WATER SHALL BE LEFT ON SURFACE). THEN PACK IN NEW PREHYDRATED MORTAR TIGHTLY IN THIN LAYERS (1/4" LIFTS) UNTIL JOINT IS FILLED.

TOOL TO MATCH EXISTING JOINTS.

LINTEL LENGTH	SIZE
7'-0"	5 x 3 ½ x ½ L.L.V.
2'-6"	5 x 3 ½ x ½ L.L.V.
4'-0"	5 x 3 ½ x ½ L.L.V.

LINTEL SCHEDULE

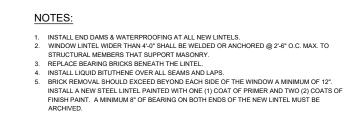

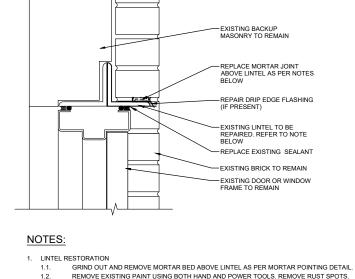


GRIND OUT AND REMOVE MORTAR BED ABOVE LINTEL AS PER MORTAR POINTING DETAIL.
REMOVE EXISTING PAINT USING BOTH HAND AND POWER TOOLS. REMOVE RUST SPOTS.
CLEAN AND REMOVE RESIDUE WITH ORGANIC SOLVENTS.
ALLOW ADEQUATE TIME FOR SOLVENTS TO DRY PER MFR RECOMMENDATIONS.

APPLY PRIMER AS PER SPECIFICATIONS AND ALLOW TO DRY, APPLY FINISH PAINT AS PER SPECIFICATIONS AND AL;LOW TO DRY. 2. PROTECT MASONRY BRICK THAT IS EXISTING TO REMAIN.
3. PROTECT EXISTING WINDOWS FROM DUST, DEBRIS AND PAINT.








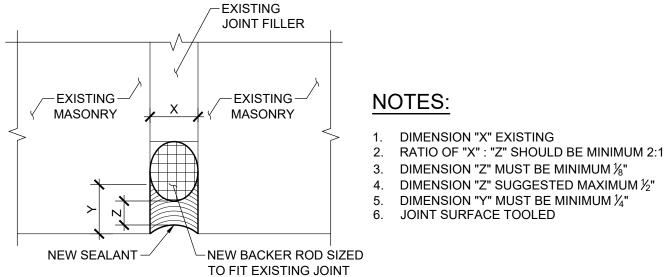



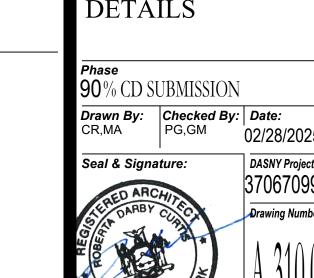

Drawing Title REPAIR DETAILS 02/28/2025 Drawing Number:

NEW YORK DASNY

515 Broadway, Albany, New York, 12207-2964 One Penn Plaza, 52 Floor, NY, NY 10119-0098 539 Franklin Street, Buffalo, NY 14202-1109

WWW.DASNY.ORG

USED FOR THEIR INTENDED PURPOSE. ONCE THE INTENDED PURPOSE HAS CEASED, THE DOCUMENTS SHALL BE DESTROYED IN A SECURE MANNER.

IS A VIOLATION OF STATE EDUCATION LAW FOR ANY PERSON, UNLESS UNDER THE DIRECTION OF A LICENSED ARCHITECT / ENGINEER TO ALTER THIS DOCUMENT IN ANY WAY. ALTERATIONS MUST HAVE THE SEAL AFFIXED ALONG WITH A DESCRIPTION

FTHE ALTERATIONS, DATE AND ARCHITECT'S / ENGINEER'S SIGNATURE. COPYRIGH

Architects NEW YORK, NEW YORK 10004 212.929.4417

Ginsberg FL 27

Merritt Engineering

The LiRo Group

Project Key

REVISIONS

Project Title

Description

New York Public **Library**

476 FIFTH AVENUE

NEW YORK, NY 10018

NYPL SCHOMBURG

SCHOMBURG LIBRARY

MALCOM X BOULEVARD

BLOCK: 1920

Date:

28-08 Bayside Lane, Queens, NY 11358


235 East Jericho Turnpike, Mineola, NY 11501


CURTIS + GINSBERG Curtis + ARCHITECTS
ONE BATTERY PARK PLAZA,

ENVELOPE RESTORATION 515 MALCOLM X BLVD NEW YORK, NY 10037

DOB APPROVAL STAMPS

DOB JOB #: M01133253-I1

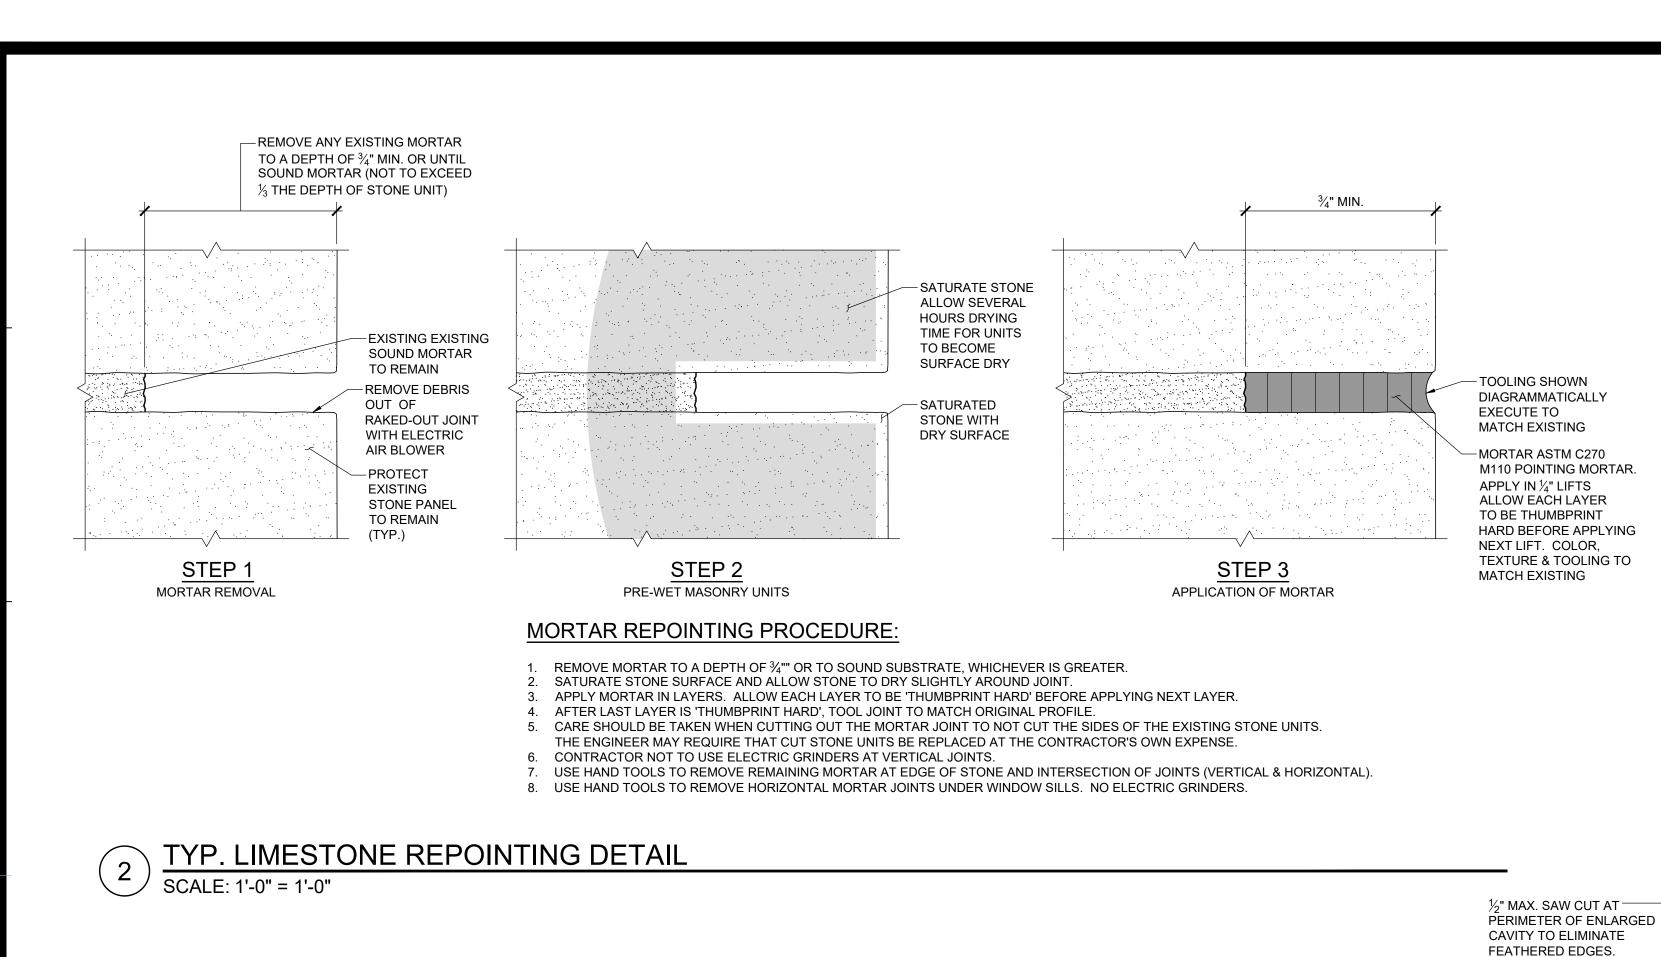

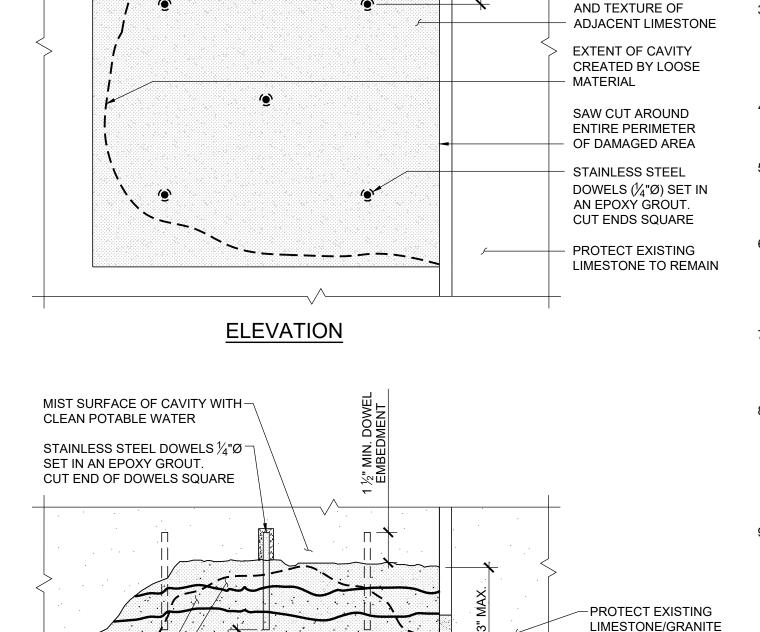

3" FROM ANY EDGE

REPAIR SEQUENCE:

PATCHING MORTAR

TO REMAIN

HYDRAULIC-LIME-BASED PATCH MORTAR

APPLY IN LIFTS (IF REQUIRED) BASED ON

DEPTH OF CAVITY. MAXIMUM THICKNESS

REPAIR IS PERFORMED USING MULTIPLE

LIFTS, SCORE THE SURFACE OF EACH LIFT

TO PRODUCE A ROUGHENED SURFACE TO

RECEIVE THE NEXT LIFT MATCH PROFILE,

OF LIFT AS PER MANUFACTURER. IF

COLOR AND TEXTURE OF ADJACENT

LIMESTONE

MATCH PROFILE, COLOR

- 1. SOUND POSSIBLE DETERIORATED SURFACES WITH 3 LB DEAD BLOW HAMMER TO IDENTIFY EXTENT OF DETERIORATED STONE TO BE REMOVED 2. CREATE A CAVITY BY REMOVING ALL
- LOOSE MATERIAL IN ACCORDANCE WITH SECTION 024119 OF THE SPECIFICATIONS. 3. ENLARGE CAVITY BY PROVIDING A
- SAW-CUT EDGE ½" IN DEPTH, LOCATED ¼" MIN (1½" MAX) BEYOND THE PERIMETER OF THE CAVITY INTO SOUND STONE. PERIMETER OF ENLARGED CAVITY TO BE RECTILINEAR IN SHAPE.
- 4. IF ANCHORS ARE FOUND, PREPARE AND COAT ANY EXPOSED STEEL FOLLOWING COATING MANUFACTURER'S INSTRUCTIONS.
- 5. DRILL HOLES OF DIAMETER AND DEPTH INDICATED, LEAN HOLES USING COMPRESSED OIL-FREE AIR AND NYLON BRISTLE BRUSHES, AND SET THREADED RODS IN EPOXY ADHESIVE.
- 6. AT CORNER AND EDGE PATCH, RAKE OUT MORTAR IN JOINT AND INSERT PLYWOOD FORM PRIOR TO PERFORMING STONE PATCHING WORK. CAREFULLY REMOVE PLYWOOD AND POINT JOINT AFTER PATCH IS FULLY CURED.
- 7. PREPARE CAVITY SURFACE AND APPLY PATCHING COMPOUND AS RECOMMENDED BY MANUFACTURER'S INSTRUCTIONS AND AS SHOWN IN THIS
- 8. APPLY PATCHING COMPOUND IN LIFTS, IF REQUIRED, BASED ON THE DEPTH OF THE CAVITY. MAXIMUM THICKNESS OF LIFT AS RECOMMENDED BY MANUFACTURER. IF REPAIR IS PERFORMED USING MULTIPLE LIFTS, SCORE THE SURFACE OF EACH LIFT TO PRODUCE ROUGHENED SURFACE TO RECEIVE THE NEXT LIFT.
- 9. TOOL SURFACE TO MATCH SURROUNDING STONE. COVER PATCH OR USE COMPATIBLE CURING COMPOUND TO ENSURE PROPER CURING.

NOTES:

- REPAIRS TO MATCH EXISTING STONE IN COLOR, SHAPE AND TEXTURE.
- APPLY THE MORTAR MIX USING A TROWELL TO A MAXIMUM THICKNESS OF
- BUILD UP PATCHING MATERIAL SLIGHTLY ABOVE ADJACENT MASONRY SURFACE.
- 4. FOLLOW MANUFACTURER'S INSTRUCTIONS AND RECOMMENDATIONS.

TYP. LIMESTONE/GRANITE PATCHING DETAIL

MAX. SPACING

PROVIDE 1/4" MIN. CLEAR

COVERAGE OF DOWELS


LIFT A-

LIFT B-

CAVITY SHALL EXTEND TO

SOUND SUBSTRATE OR A

MAX. OF 3" DEPTH

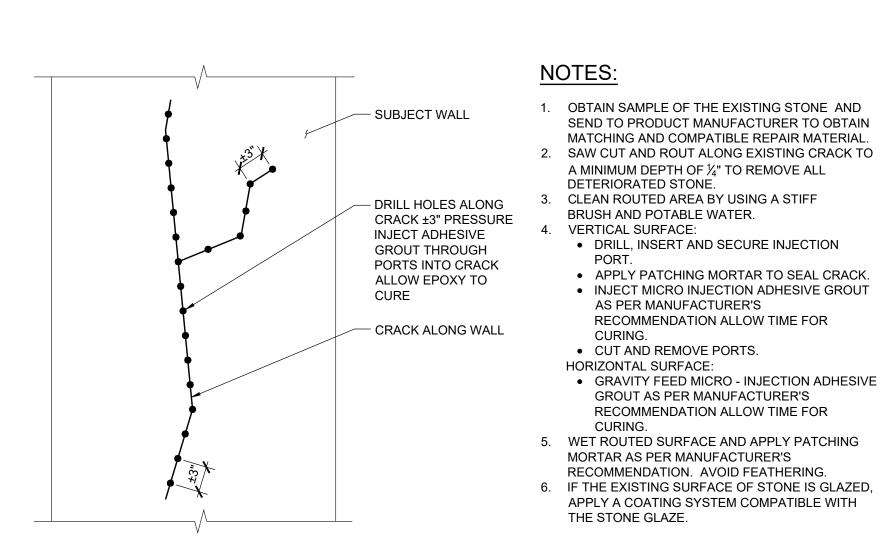


TYP. STONE CRACK INJECTION

SCALE: N.T.S.

REPAIR DETAIL FOR CRACKS ≤ 1/16" WIDE

STONE POINTING - REMOVE EXISTING DETERIORATED STONE TO SOUND SUBSTRATE SAW & CUT AROUND ENTIRE PERIMETER OF DAMAGED AREA LIMESTONE TO MATCH EXISTING LIMESTONE IN MATERIAL, COLOR, TEXTURE & FORM - APPLY ADHESIVE AT JOINT OF 1 ½" MIN. EXISTING STONE **EMBEDMENT** - DOWELS (STAINLESS STEEL) SET IN ANCHORING COMPOUND STONE TO REMAIN AND BE PROTECTED

- NOTES: 1. TREAT (POWER WASH) DUTCHMAN TO REPLACE TEXTURE OF EXISTING WEATHERED
- STONE PRIOR TO INSTALLATION. 2. SHORE / BRACE EXISTING STONE AS REQUIRED PRIOR TO THE START OF WORK. 3. FOR LIMESTONE DUTCHMAN AT STONE ANCHOR OR WHERE LARGER THAN 12"x12", NOTIFY ENGINEER TO SCHEDULE INSPECTION PRIOR TO THE START OF FABRICATION

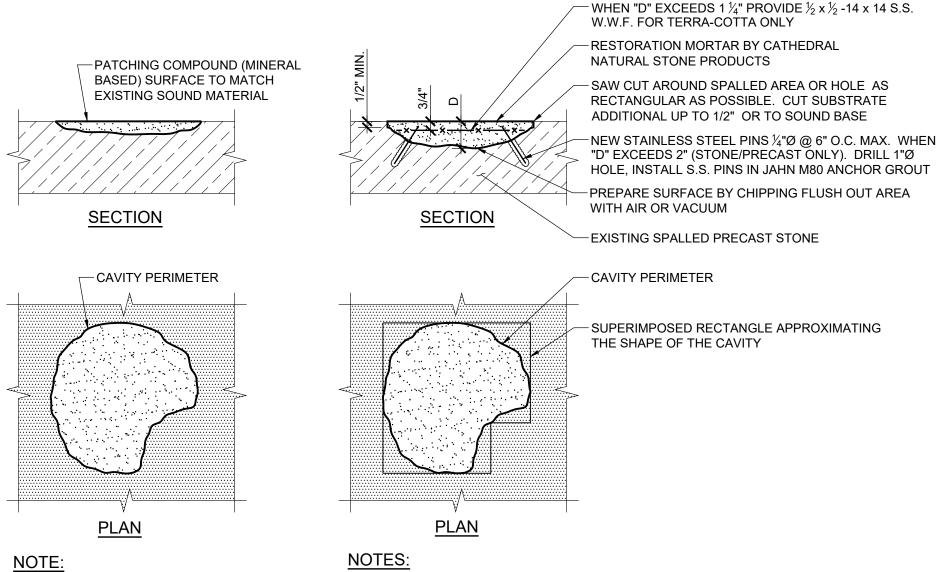

CAVITY PERIMETER DOES NOT REQUIRE SAW-CUT EDGE


REPAIRS TO MATCH EXISTING PRECAST STONE IN COLOR, SHAPE AND TEXTURE. APPLY THE MORTAR MIX USING A TROWELL TO A MAXIMUM THICKNESS OF 3". 3. BUILD UP PATCHING MATERIAL SLIGHTLY ABOVE ADJACENT MASONRY SURFACE.

4. FOLLOW MANUFACTURER'S INSTRUCTIONS AND RECOMMENDATIONS.


TYP. DUTCHMAN REPAIR DETAIL

DOB APPROVAL STAMPS

NEW YORK 515 Broadway, Albany, New York, 12207-2964 One Penn Plaza, 52 Floor, NY, NY 10119-0098 539 Franklin Street, Buffalo, NY 14202-1109 WWW.DASNY.ORG JSED FOR THEIR INTENDED PURPOSE. ONCE THE INTENDED PURPOSE HAS CEASED, THE DOCUMENTS SHALL BE DESTROYED IN A SECURE MANNER. IS A VIOLATION OF STATE EDUCATION LAW FOR ANY PERSON, UNLESS UNDER THE RECTION OF A LICENSED ARCHITECT / ENGINEER TO ALTER THIS DOCUMENT IN ANY WAY, ALTERATIONS MUST HAVE THE SEAL AFFIXED ALONG WITH A DESCRIPTIO THE ALTERATIONS, DATE AND ARCHITECT'S / ENGINEER'S SIGNATURE. COPYRIGH CURTIS + GINSBERG Curtis + ARCHITECTS
ONE BATTERY PARK PLAZA, Ginsberg FL 27 Architects NEW YORK, NEW YORK 10004 Merritt Engineering 8-08 Bayside Lane, Queens, NY 11358 The LiRo Group 35 East Jericho Turnpike, Mineola, NY 11501

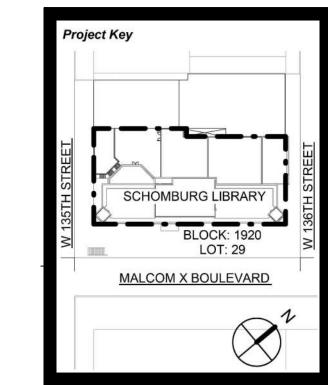


Rev No	SIONS Description	Date:
1		<u> </u>
${2}$		
<u>3</u>		
4		
<u></u> <u>5</u>		
<u>6</u> 1		
<u> </u>		
<u>&</u>		
<u></u>		

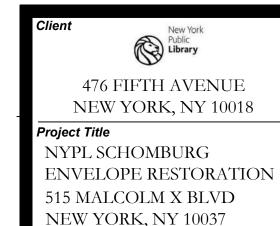



TYPICAL PRECAST STONE SPALL REPAIR DETAIL

DOB JOB #: M01133253-I1

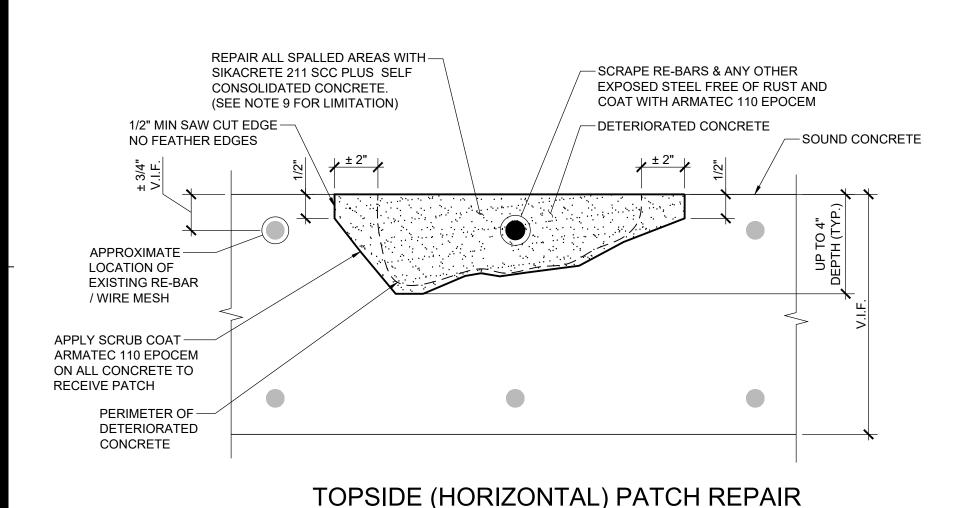


THREADED STAINLESS STEEL PINS -EMBEDDED 4" INTO EPOXY @ 6" O.C. (TYP.) PERIMETER OF -DETERIORATED CONCRETE APPLY SCRUB COAT -ARMATEC 110 EPOCEM ON ALL CONCRETE TO RECEIVE PATCH APPROXIMATE -LOCATION OF EXISTING RE-BAR / WIRE MESH SOUND CONCRETE 1/2" MIN SAW CUT EDGE -DETERIORATED CONCRETE NO FEATHER EDGES REPAIR ALL SPALLED AREAS WITH -- SCRAPE RE-BARS & ANY OTHER SIKA TOP 123 PLUS OR SIKACRETE EXPOSED STEEL FREE OF RUST AND 211 SCC PLUS COAT WITH ARMATEC 110 EPOCEM SEE NOTE - 10 FOR LIMITATION

UNDERSIDE (OVERHEAD) PATCH REPAIR

THREADED STAINLESS STEEL PINS EMBEDDED 4" INTO EPOXY @ 6" O.C. (TYP.) - SOUND CONCRETE -1/2" MIN SAW CUT EDGE NO FEATHER EDGES APPLY SCRUB COAT ARMATEC 110 EPOCEM ON ALL CONCRETE TO RECEIVE PATCH -DETERIORATED CONCRETE -REPAIR ALL SPALLED AREAS WITH SIKA TOP 123 PLUS OR SIKACRETE 211 SCC PLUS FOR REPAIR MORTAR **SEE NOTE** - 10 FOR INSTALLATION PERIMETER OF DETERIORATED CONCRETE - SCRAPE RE-BARS & ANY OTHER EXPOSED STEEL FREE OF RUST AND COAT WITH ARMATEC 110 EPOCEM UP TO 4" DEPTH (TYP.)

VERTICAL PATCH REPAIR

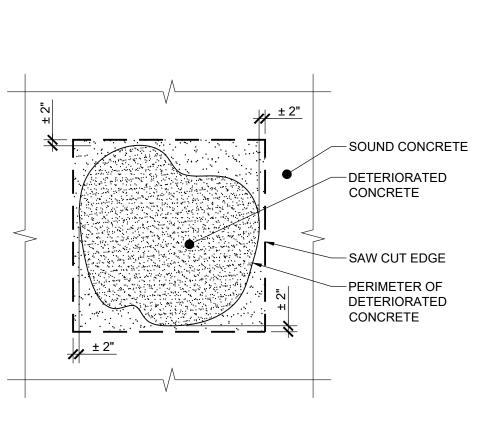


TOP PLAN VIEW OF DETERIORATED **CONCRETE SURFACE**

NOTES:

- SURVEY SOUND SURFACES WITH 3 LB. DEAD BLOW HAMMER AT LOCATIONS APPROXIMATELY 2"-3" O.C. TO IDENTIFY EXTENT OF DETERIORATED CONCRETE TO BE REMOVED. CREATE AN ENLARGED CAVITY BY PROVIDING A SAW CUT EDGE 1/2"-1" IN DEPTH, LOCATED A MINIMUM OF 2" IN SOUND CONCRETE BEYOND THE PERIMETER OF THE CAVITY. DO NOT DAMAGE REINFORCING STEEL.
- REMOVE ALL LOOSE MATERIAL IF DEPTH OF SOUND SUBSTRATE FOUND BEYOND THE EXISTING RE-BAR THEN CONCRETE REMOVAL SHALL EXTEND MINIMUM 1" BEYOND EXISTING RE-BAR / WIRE MESH.
- IF CORRODED REINFORCING STEEL IS NOTED THEN CONCRETE REMOVAL SHALL EXTEND ALONG LENGTH OF REINFORCING STEEL TO LOCATION FREE OF CORROSION RE-BAR / WIRE MESH.
- SCARIFY AND CLEAN THE CAVITY WITH POTABLE WATER, REMOVE ANY BOND INHIBITIVE MATERIAL REINFORCING STEEL TO BE SCRAPED FREE OF ALL RUST AND COATED WITH SIKA ARMATEC 110 EPOCEM. BONDING AGENT AS A ANTI-CORROSION COATING FOR EXISTING EXPOSED REINFORCING BAR / WIRE MESH.
- DRILL AND SET 1/4" STAINLESS STEEL THREADED RODS @ MAX 6" O.C. WHERE DEPTH OF SPALLED EXCEED CONCRETE 3" IN VERTICAL AND UNDERSIDE REPAIRS.
- APPLY SIKACRETE 211 SCC PLUS. SELF CONSOLIDATED CONCRETE FOR HORIZONTAL SURFACES. APPLICATION THICKNESS MIN. 1". APPLY SIKATOP III PLUS, AND SIKA MONOTOP 615 FOR THICKNESS LESS THAN 1". APPLY SIKA TOP 123 PLUS FOR VERTICAL AND OVERHEAD PATCHES. APPLICATION THICKNESS IS MIN. 1/8" AND 1-1/2" MAXIMUM. APPLY SIKACRETE 211 SCC PLUS WHERE THICKNESS IS MORE THAN 1-1/2".
- 11. THE CONTRACTOR IS RESPONSIBLE FOR THE INSTALLATION OF NEW SEALANT JOINT ALONG THE LOCATIONS WHERE NEWLY PATCHED CONCRETE COME ACROSS MASONRY PARTS OF THE FACADE.


TYPICAL CONCRETE PATCH REPAIR DETAILS

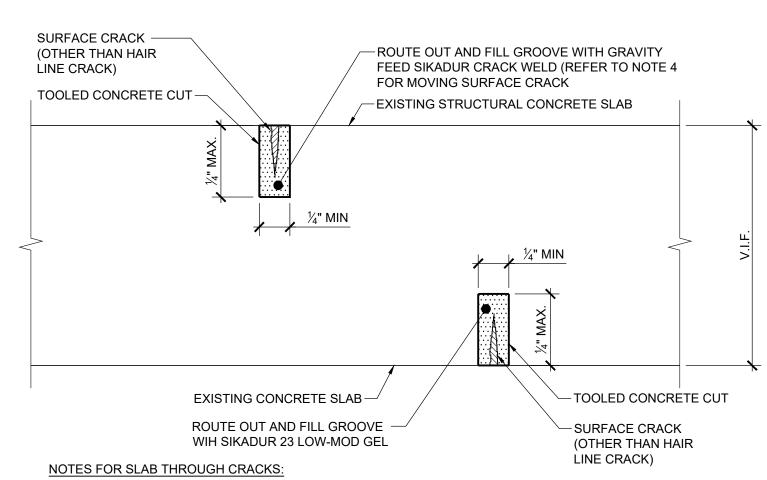

- 1. SEAL BOTTOM WITH SIKADUR 23 LOW-MOD GEL SMOOTH PASTE ADHESIVE FOR CRACK SEALING.

WIDTH TO DEPTH RATIO.

- 2. TOOL CONCRETE CUT ¼" X ¼" ALONG THE LENGTH OF THE CRACK. GRAVITY FEED SIKADUR CRACK WELD AS PER MANUFACTURE RECOMMENDATION AND ALLOW FOR CURING. 4. FOR MOVING SURFACE CRACKS USE SIKAFLEX 1A. REFER TO MANUFACTURE RECOMMENDATION FOR
- TYPICAL NON-MOVING SURFACE CRACK REPAIR DETAIL

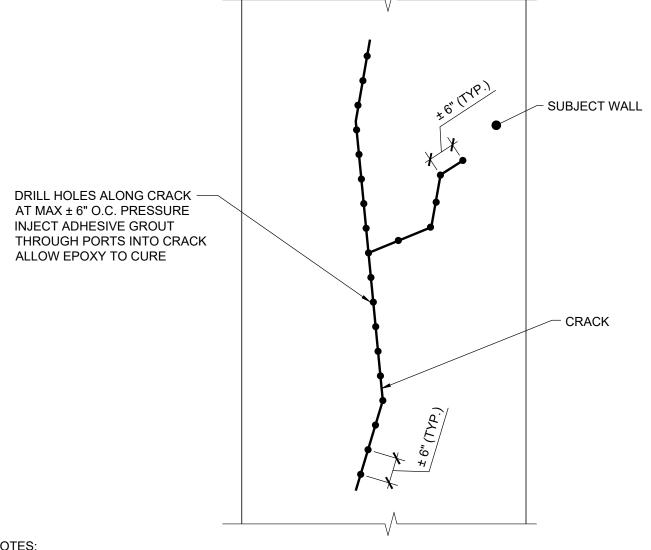

1. SAW CUT AND ROUTE ALONG EXISTING CRACK TO A MINIMUM DEPTH OF 1/8" & WIDTH OF 1/8" (MAX. 1/4" WIDE & 1/4" DEEP). CLEAN ROUTED AREA AS PER MANUFACTURER RECOMMENDATION.


3. FOR HORIZONTAL, VERTICAL & OVERHEAD SURFACES: A. DRILL, INSERT AND SECURE INJECTION PORT ALONG CRACK AT 6" O.C. TYP.

IN STRUCTURE CONCRETE PRIOR TO PRESSURE INJECTION GROUTING.


- B. APPLY SIKADUR 23 LOW-MODGEL SMOOTH PASTE ADHESIVE FOR CRACK SEALING AND SECURE INJECTION PORTS
- C. REFER TO MANUFACTURER RECOMMENDATION FOR CURE TIME OF SIKADUR 23 LOW-MODGEL CRACK SEALANT BEFORE APPLYING PRESSURE INJECTION GROUTING.
- D. INJECT SIKADUR CRACK WELD AS PER MANUFACTURER RECOMMENDATION AND ALLOW TIME FOR CURING. E. CUT AND REMOVE PORTS AND SEAL THEM WITH SIKADUR 23 LOW-MOD GEL.
- 4. FOR THROUGH WALL CRACKS APPLY INJECTION PARTS ON EITHER SIDE OF WALL ALONG CRACKS AT STAGGERED LOCATIONS.

TYPICAL CRACK INJECTION REPAIR DETAIL FOR NON-MOVING CRACKS DEEPER THAN 1/2"


SCALE: 1/2" = 1'-0"

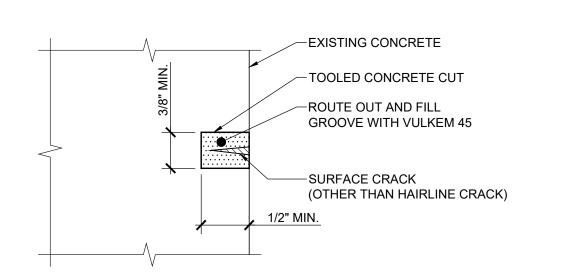

TYPICAL VERTICAL CRACK REPAIR DETAIL

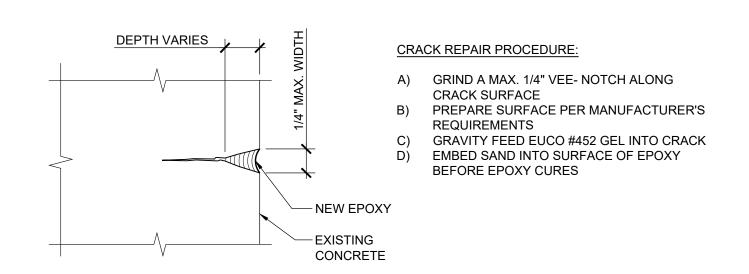

TYPICAL VERTICAL CRACK /SPALL (1/4" MAX.) REPAIR DETAIL

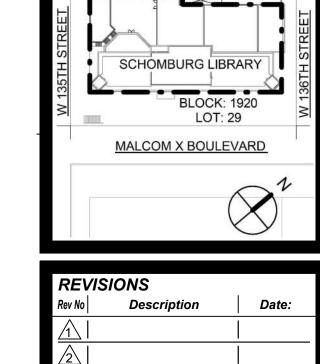

515 Broadway, Albany, New York, 12207-2964

One Penn Plaza, 52 Floor, NY, NY 10119-0098

539 Franklin Street, Buffalo, NY 14202-1109

WWW.DASNY.ORG

JSED FOR THEIR INTENDED PURPOSE. ONCE THE INTENDED PURPOSE HAS CEASED, THE DOCUMENTS SHALL BE DESTROYED IN A SECURE MANNER.

IS A VIOLATION OF STATE EDUCATION LAW FOR ANY PERSON, UNLESS UNDER THE

RECTION OF A LICENSED ARCHITECT / ENGINEER TO ALTER THIS DOCUMENT IN ANY WAY, ALTERATIONS MUST HAVE THE SEAL AFFIXED ALONG WITH A DESCRIPTIO

THE ALTERATIONS, DATE AND ARCHITECT'S / ENGINEER'S SIGNATURE. COPYRIG

Ginsberg FL 27

Merritt Engineering

The LiRo Group

Project Key

8-08 Bayside Lane, Queens, NY 11358


35 East Jericho Turnpike, Mineola, NY 11501

CURTIS + GINSBERG


ARCHITECTS Curtis + ONE BATTERY PARK PLAZA,

Architects NEW YORK, NEW YORK 10004


REVIS	IONS	
Rev No	Description	Date:
<u> </u>		
<u> </u>		
<u>3</u>		
<u>4</u>		
<u></u> <u>5</u>		
<u>6</u>		
<u> </u>		
<u>8</u>		
<u> </u>		

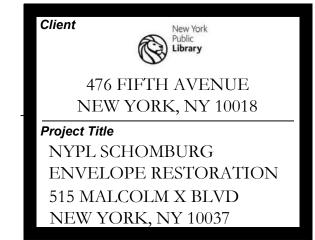




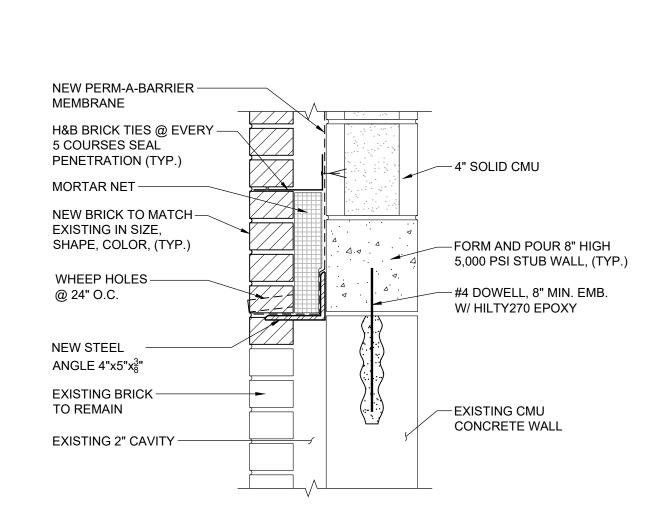

3 GLASS BLOCK CLOSURE BASE DETAIL
SCALE: 1 1/2" = 1'-0"

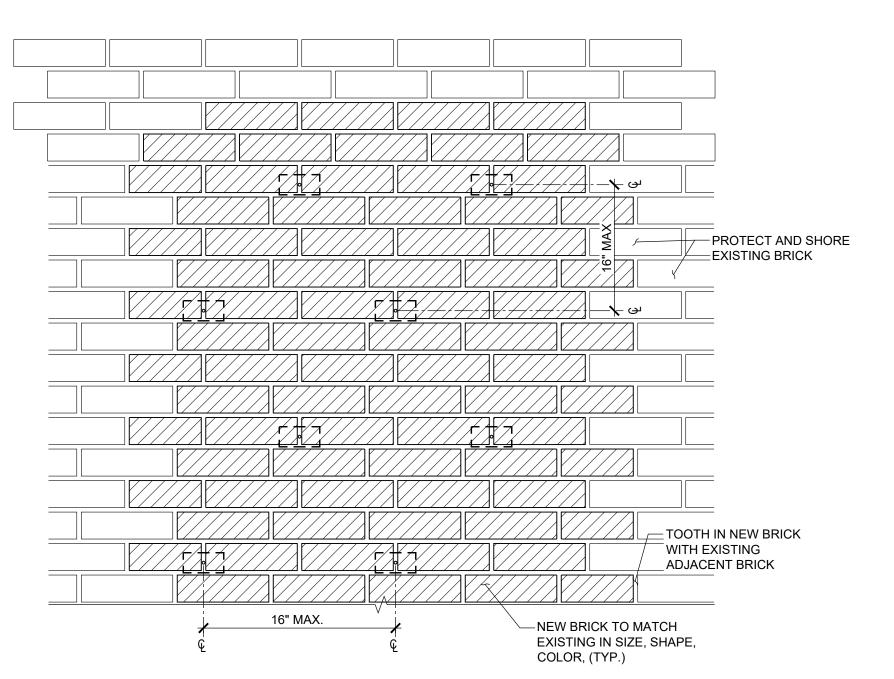


2 NEW BRICK INSTALLATION
SCALE: 1 1/2" = 1'-0"

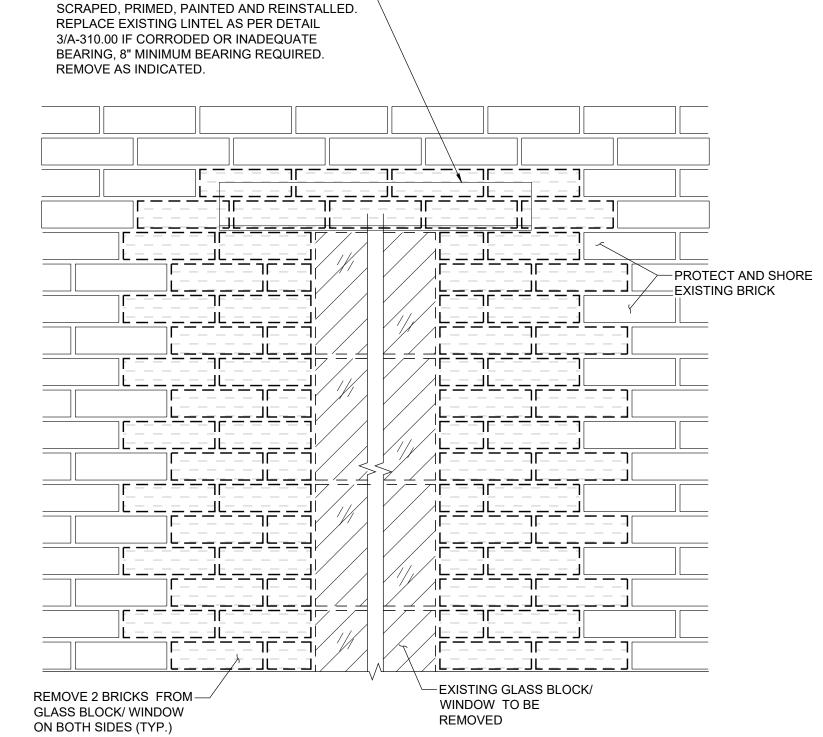


EXISTING LINTEL TO BE REMOVED, SALVAGED,

1 GLASS BLOCK/ WINDOW REMOVAL DETAIL
SCALE: 1 1/2" = 1'-0"

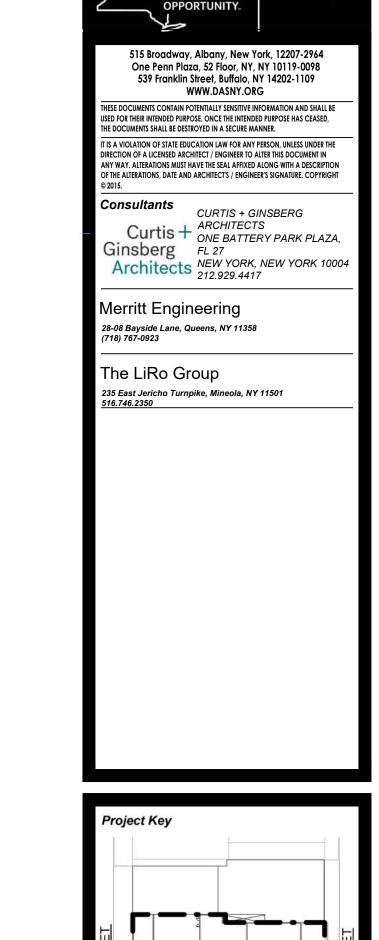

NEW YORK DASNY

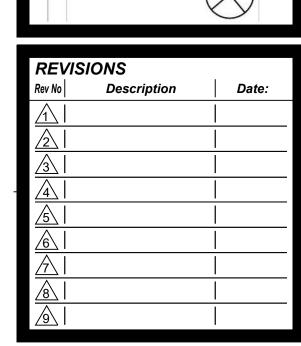


SCHOMBURG LIBRARY

MALCOM X BOULEVARD

BLOCK: 1920





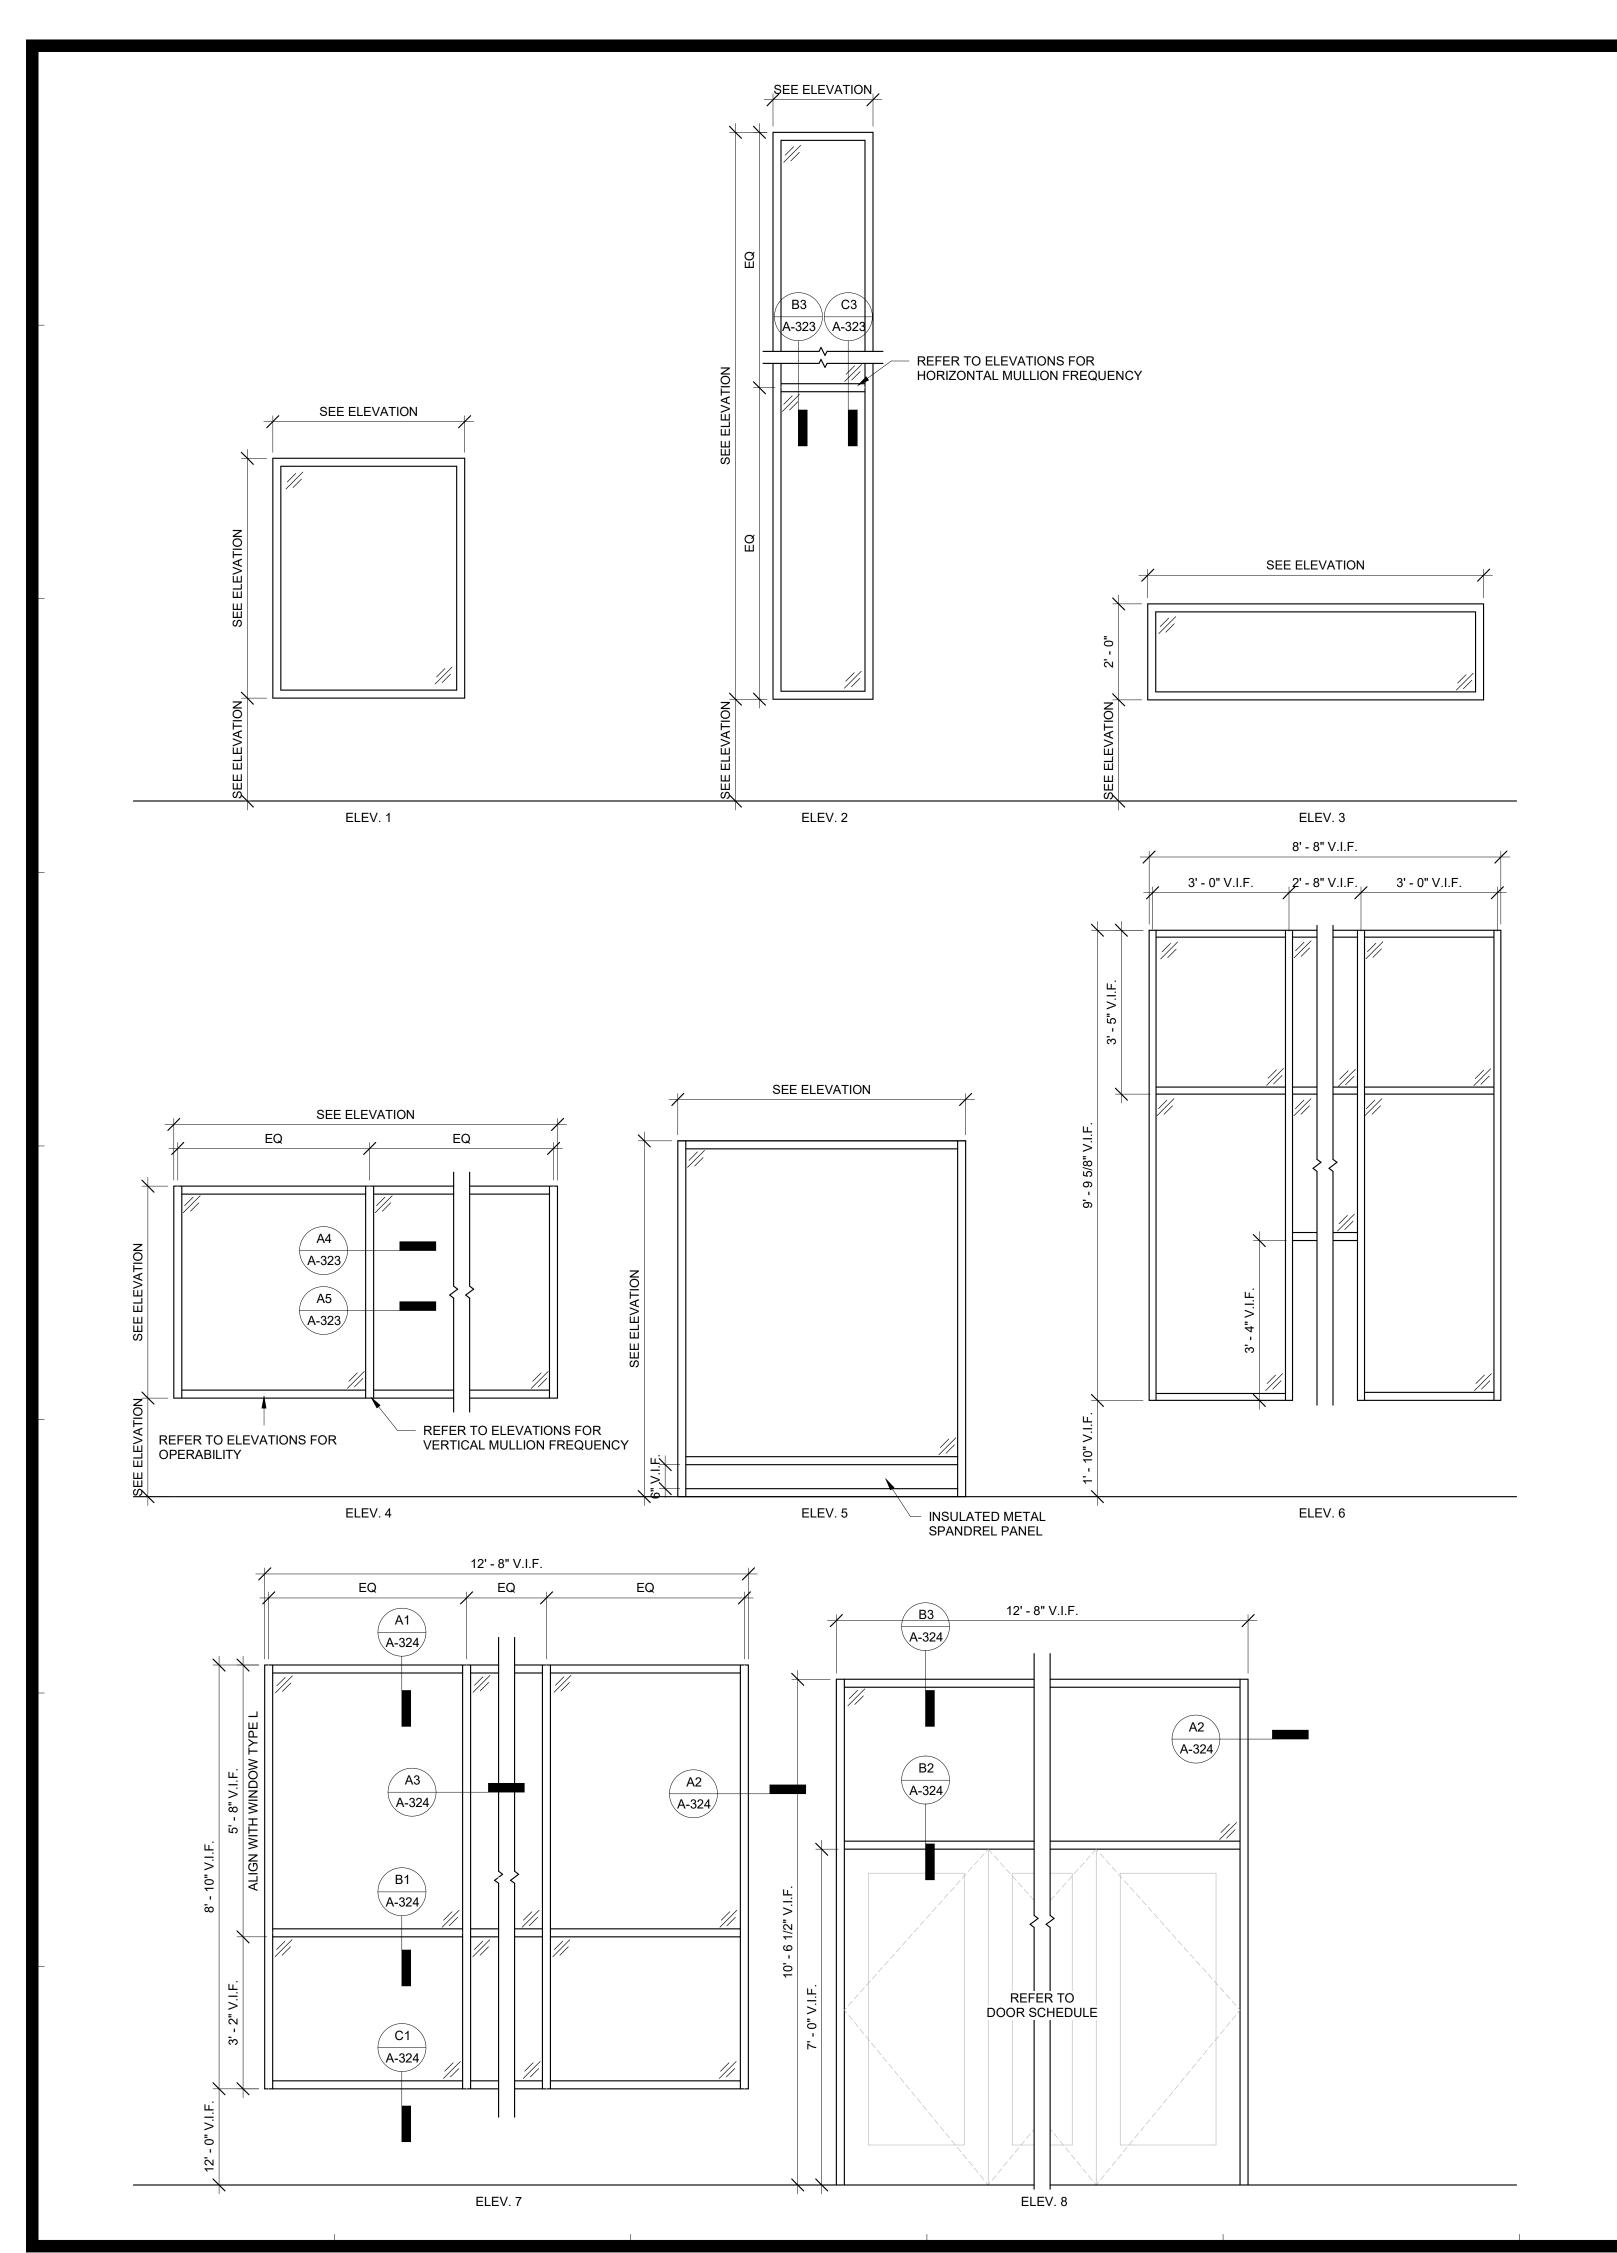

						WINDOW S	CHEDULE					
Type Mark	Type Elevation	Window Height	Window Width	HEAD DETAIL	SILL DETAIL	JAMB DETAIL	Maximum U-Value	Maximum SHGC	Maufacturer	Series	Color	Type Comments
Α	2	5' - 0"	4' - 0"	A2/A-321	B2/A-321	C2/A-321	0.30	0.36	QUAKER COMMERCIAL	C600 - VARIES	MATCH EXISTING	
В	2	15' - 1"	2' - 1"	A3/A-321	B3/A-321	C3/A-321	0.30	0.36	QUAKER COMMERCIAL	C600 - FIXED	MATCH EXISTING	
С	4	2' - 0"	11' - 0"	A4/A-321	B4/A-321	C4/A-321	0.30	0.36	QUAKER COMMERCIAL	C600 - FIXED	MATCH EXISTING	
D	3	2' - 0"	7' - 0"	A4/A-321	B4/A-321	C4/A-321	0.30	0.36	QUAKER COMMERCIAL	C600 - FIXED	MATCH EXISTING	
E	2	14' - 0"	5' - 1"	A3/A-321	B3/A-321	C3/A-321	0.30	0.36	QUAKER COMMERCIAL	C600 - FIXED	MATCH EXISTING	
F	5	7' - 5"	6' - 0"	A1/A-322	B2/A-322	C3/A-322	0.30	0.36	QUAKER COMMERCIAL	C600 - FIXED	MATCH EXISTING	
G	1	6' - 0"	6' - 0"	A2/A-322	B2/A-322	C2/A-322	0.30	0.36	QUAKER COMMERCIAL	C600 - FIXED	MATCH EXISTING	
Н	1	6' - 0 1/2"	2' - 6"	A3/A-322	B3/A-322	C3/A-322	0.30	0.36	QUAKER COMMERCIAL	C600 - FIXED	MATCH EXISTING	
J	1	6' - 0 1/2"	2' - 6"	A2/A-322	B2/A-322	C2/A-322 C1/A-321	0.30	0.36	QUAKER COMMERCIAL	C600 - FIXED	MATCH EXISTING	SEE ELEV FOR OPERABL
К	4	4' - 5 1/4" 5' - 8"	172' - 1 1/4" 92' - 2"	A1/A-321	B1/A-321	C1/A-321	0.30	0.36	QUAKER COMMERCIAL QUAKER	C600 - VARIES	MATCH EXISTING MATCH	LOCATIONS
M	4	6' - 2"	10' - 0"	A1/A-321 A4/A-322	B1/A-321 B4/A-322	C1/A-321	0.30	0.36	COMMERCIAL QUAKER	C600 - FIXED	EXISTING MATCH	
N	6	10' - 0"	8' - 8"	A4/A-322	B4/A-322	C4/A-322	0.30	0.36	COMMERCIAL QUAKER	C600 - FIXED	EXISTING MATCH	
P	1	7' - 2"	3' - 0"	A1/A-323	B1/A-323	C1/A-323	0.30	0.36	COMMERCIAL QUAKER	C600 - FIXED	EXISTING MATCH	
	2	7' - 6 1/2"	2' - 1"	A3/A-321	B3/A-321	C3/A-321	0.30	0.36	COMMERCIAL QUAKER	C600 - FIXED	EXISTING MATCH	
S	1	5' - 8"	1' - 7"	A1/A-321	B1/A-321	C1/A-321	0.30	0.36	COMMERCIAL QUAKER	C600 - FIXED	EXISTING MATCH	
	1	5' - 8"		A1/A-321	B1/A-321	C1/A-321	0.30	0.36	COMMERCIAL QUAKER	C600 - FIXED	EXISTING MATCH	
V	1	4' - 5 1/4"	4' - 0"	A1/A-321	B1/A-321	C1/A-321	0.30	0.36	COMMERCIAL		EXISTING MATCH	
W	4	4' - 5 1/4"	40' - 2"	A1/A-321	B1/A-321	C1/A-321	0.30	0.36	COMMERCIAL		EXISTING MATCH	SEE ELEV FOR OPERABL
X	1	4' - 5 1/4"		A1/A-321	B1/A-321	C1/A-321	0.30	0.36	COMMERCIAL QUAKER		EXISTING MATCH	LOCATIONS SEE ELEV FOR OPERABL

	STOREFRONT SCHEDULE										
Type Mark	Type Elevation	Curtain Wall Height	Curtain Wall Width	Maximum U-Value	Maximum SHGC	Maufacturer	Series	Color	Type Comments		
Α	8	11' - 0"	12' - 10"	0.36	0.36	KAWNEER	1600SS				
В	7	8' - 10"	12' - 10"	0.36	0.36	KAWNEER	1600SS				

1. SILL HEIGHTS VARY. REFER TO ELEVATIONS.

2. GC TO VERIFY EXISTING WINDOW AND CURTAIN WALL DIMENSIONS.

3. REFER TO ELEVATION FOR WINDOW AND CURTAIN WALL LOCATIONS. 4. PROVIDE NFRC 100 CERTIFICATES FOR ALL WINDOWS TO DETERMINE U-FACTOR.

5. AIR LEAKAGE REQUIREMENTS PER ASHRAE 5.4.3:


UNCONDITIONED VESTIBULES SHALL COMPLY WITH THE REQUIREMENTS FOR A SEMIHEATED SPACE.


A. FENESTRATION AND DOORS: AIR LEAKAGE FOR FENESTRATION AND DOORS SHALL BE DETERMINED IN ACCORDANCE WITH AAMA/WDMA/CSA 101/I.S.2/A440, NFRC 400, OR ASTM E283 AS SPECIFIED BELOW. AIR LEAKAGE SHALL BE DETERMINED BY A LABORATORY ACCREDITED BY A NATIONALLY RECOGNIZED ACCREDITATION ORGANIZATION, SUCH AS THE NATIONAL FENESTRATION RATING COUNCIL, AND SHALL BE LABELED AND CERTIFIED BY THE MANUFACTURER. AIR LEAKAGE SHALL NOT EXCEED:

a. GLAZED SWINGING ENTRANCE DOORS AND REVOLVING DOORS: 1.0 CFM/FT2. FOR GLAZED SWINGING ENTRANCE DOORS AND REVOLVING DOORS, TESTED AT A PRESSURE OF AT LEAST 1.57 PSF IN ACCORDANCE WITH AAMA/WDMA/CSA 101/I.S.2/A440, NFRC 400, OR ASTM E283;

b. CURTAIN WALL AND STOREFRONT GLAZING: 0.06 CFM/FT2. FOR CURTAIN WALL AND STOREFRONT GLAZING, TESTED AT A PRESSURE OF AT LEAST 1.57 PSF OR HIGHER IN ACCORDANCE WITH NFRC 400 OR ASTM E283;

c. VESTIBULE: BUILDING ENTRANCES THAT SEPARATE CONDITIONED SPACE FROM THE EXTERIOR SHALL BE PROTECTED WITH AN ENCLOSED VESTIBULE, WITH ALL DOORS OPENING INTO AND OUT OF THE VESTIBULE EQUIPPED WITH SELF-CLOSING DEVICES. VESTIBULES SHALL BE DESIGNED SO THAT IN PASSING THROUGH THE VESTIBULE IT IS NOT NECESSARY FOR THE INTERIOR AND EXTERIOR DOORS TO OPEN AT THE SAME TIME. INTERIOR AND EXTERIOR DOORS SHALL HAVE A MINIMUM DISTANCE BETWEEN THEM OF NOT LESS THAN 7 FT WHEN IN THE CLOSED POSITION. THE FLOOR AREA OF EACH VESTIBULE SHALL NOT EXCEED THE GREATER OF 50 FT2 OR 2% OF THE GROSS CONDITIONED FLOOR AREA OF THAT LEVEL OF THE BUILDING. THE EXTERIOR ENVELOPE OF CONDITIONED VESTIBULES SHALL COMPLY WITH THE REQUIREMENTS FOR A CONDITIONED SPACE. THE INTERIOR AND EXTERIOR ENVELOPE OF

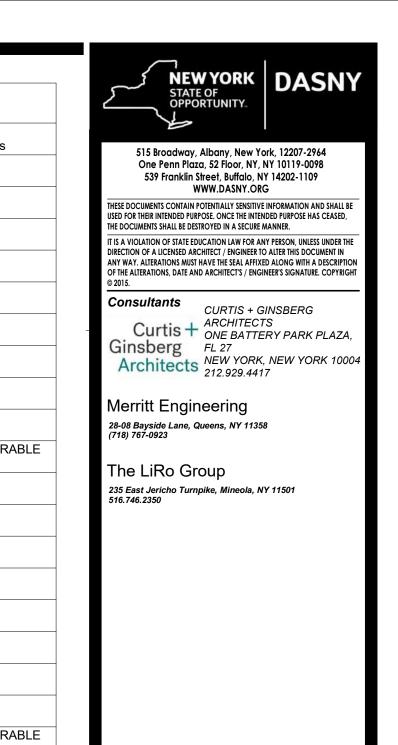

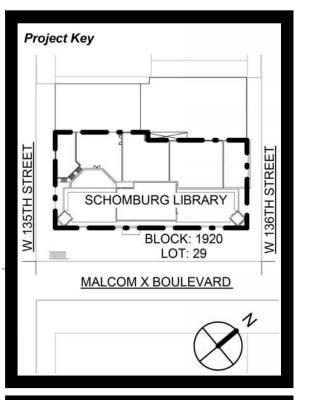


REVIS	IONS	
Rev No	Description	Date:
1		
2		
3		
4		
<u>5</u>		
<u>6</u>		
<u> </u>		
<u>8</u>		
<u> </u>		
01: 4		





90% CD SUBMISSION DC / SL Seal & Signature:

Drawn By:Checked By:Date:TT/AADC / SL02/28/5 DASNY Project No

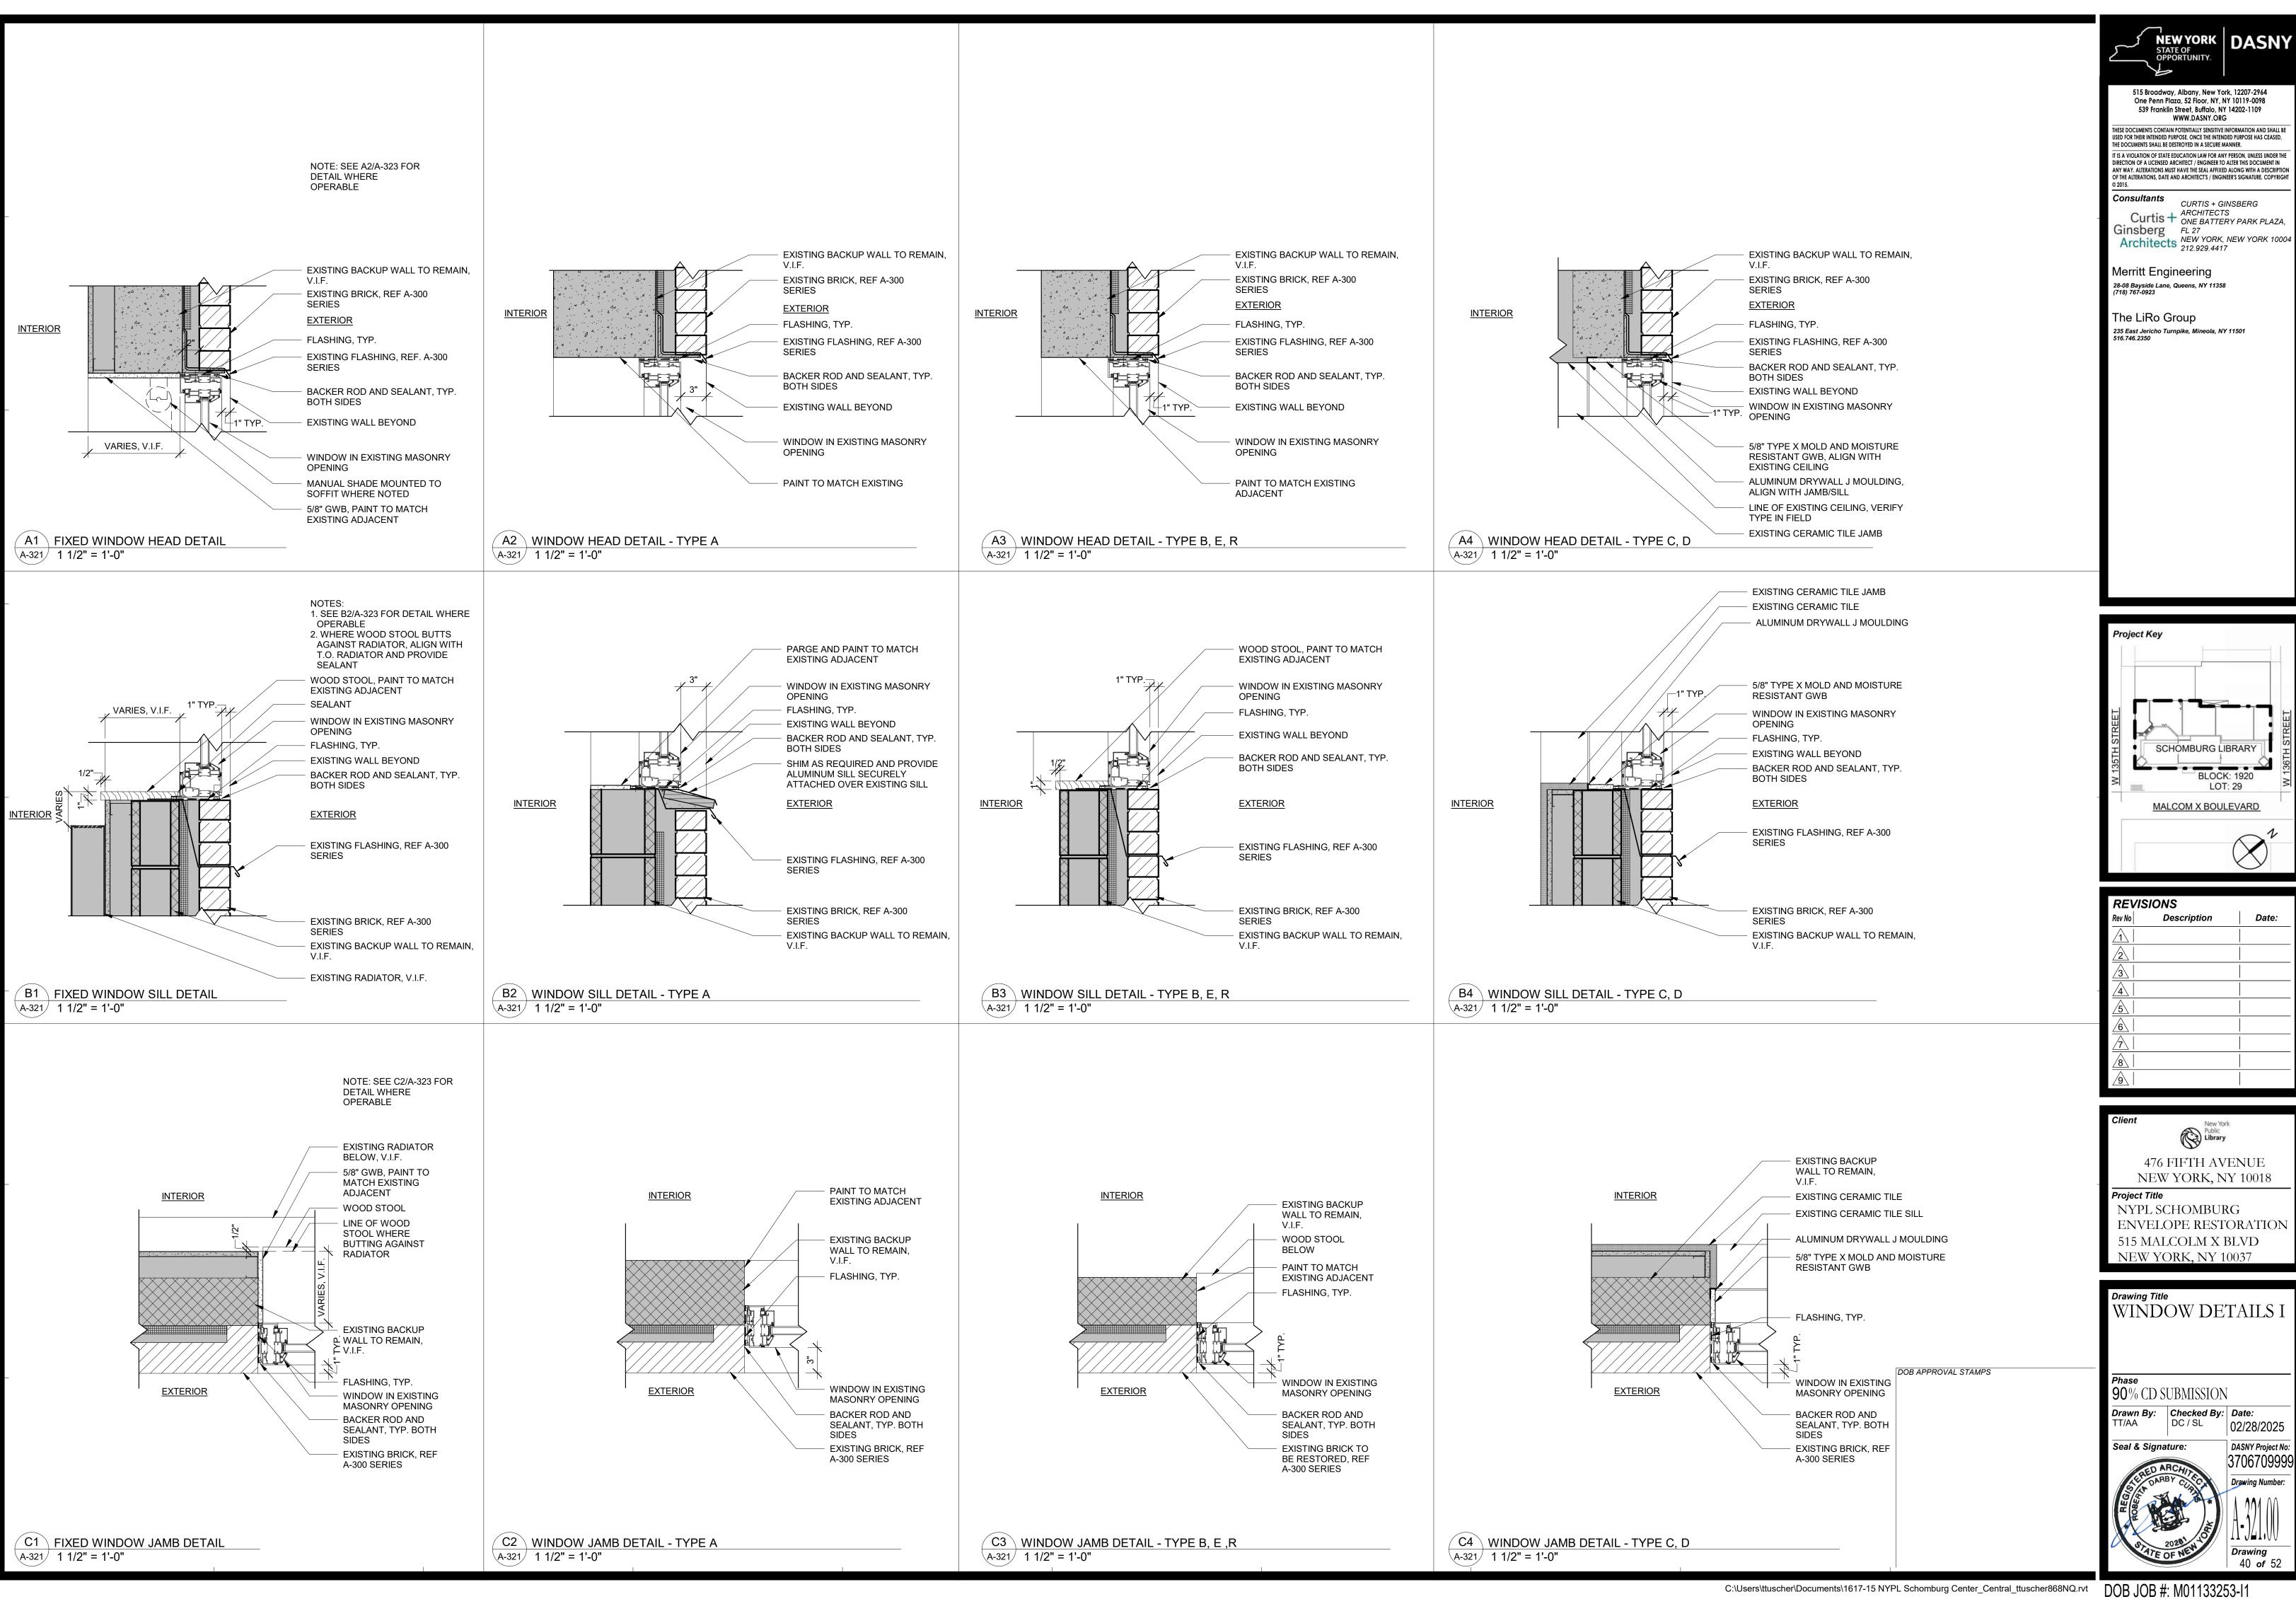

WWW.DASNY.ORG

CURTIS + GINSBERG

SCHOMBURG LIBRARY

MALCOM X BOULEVARD

New York Public **Library**

DC / SL


02/28/2025


DASNY Project No

40 **of** 52


BLOCK: 1920

LOT: 29

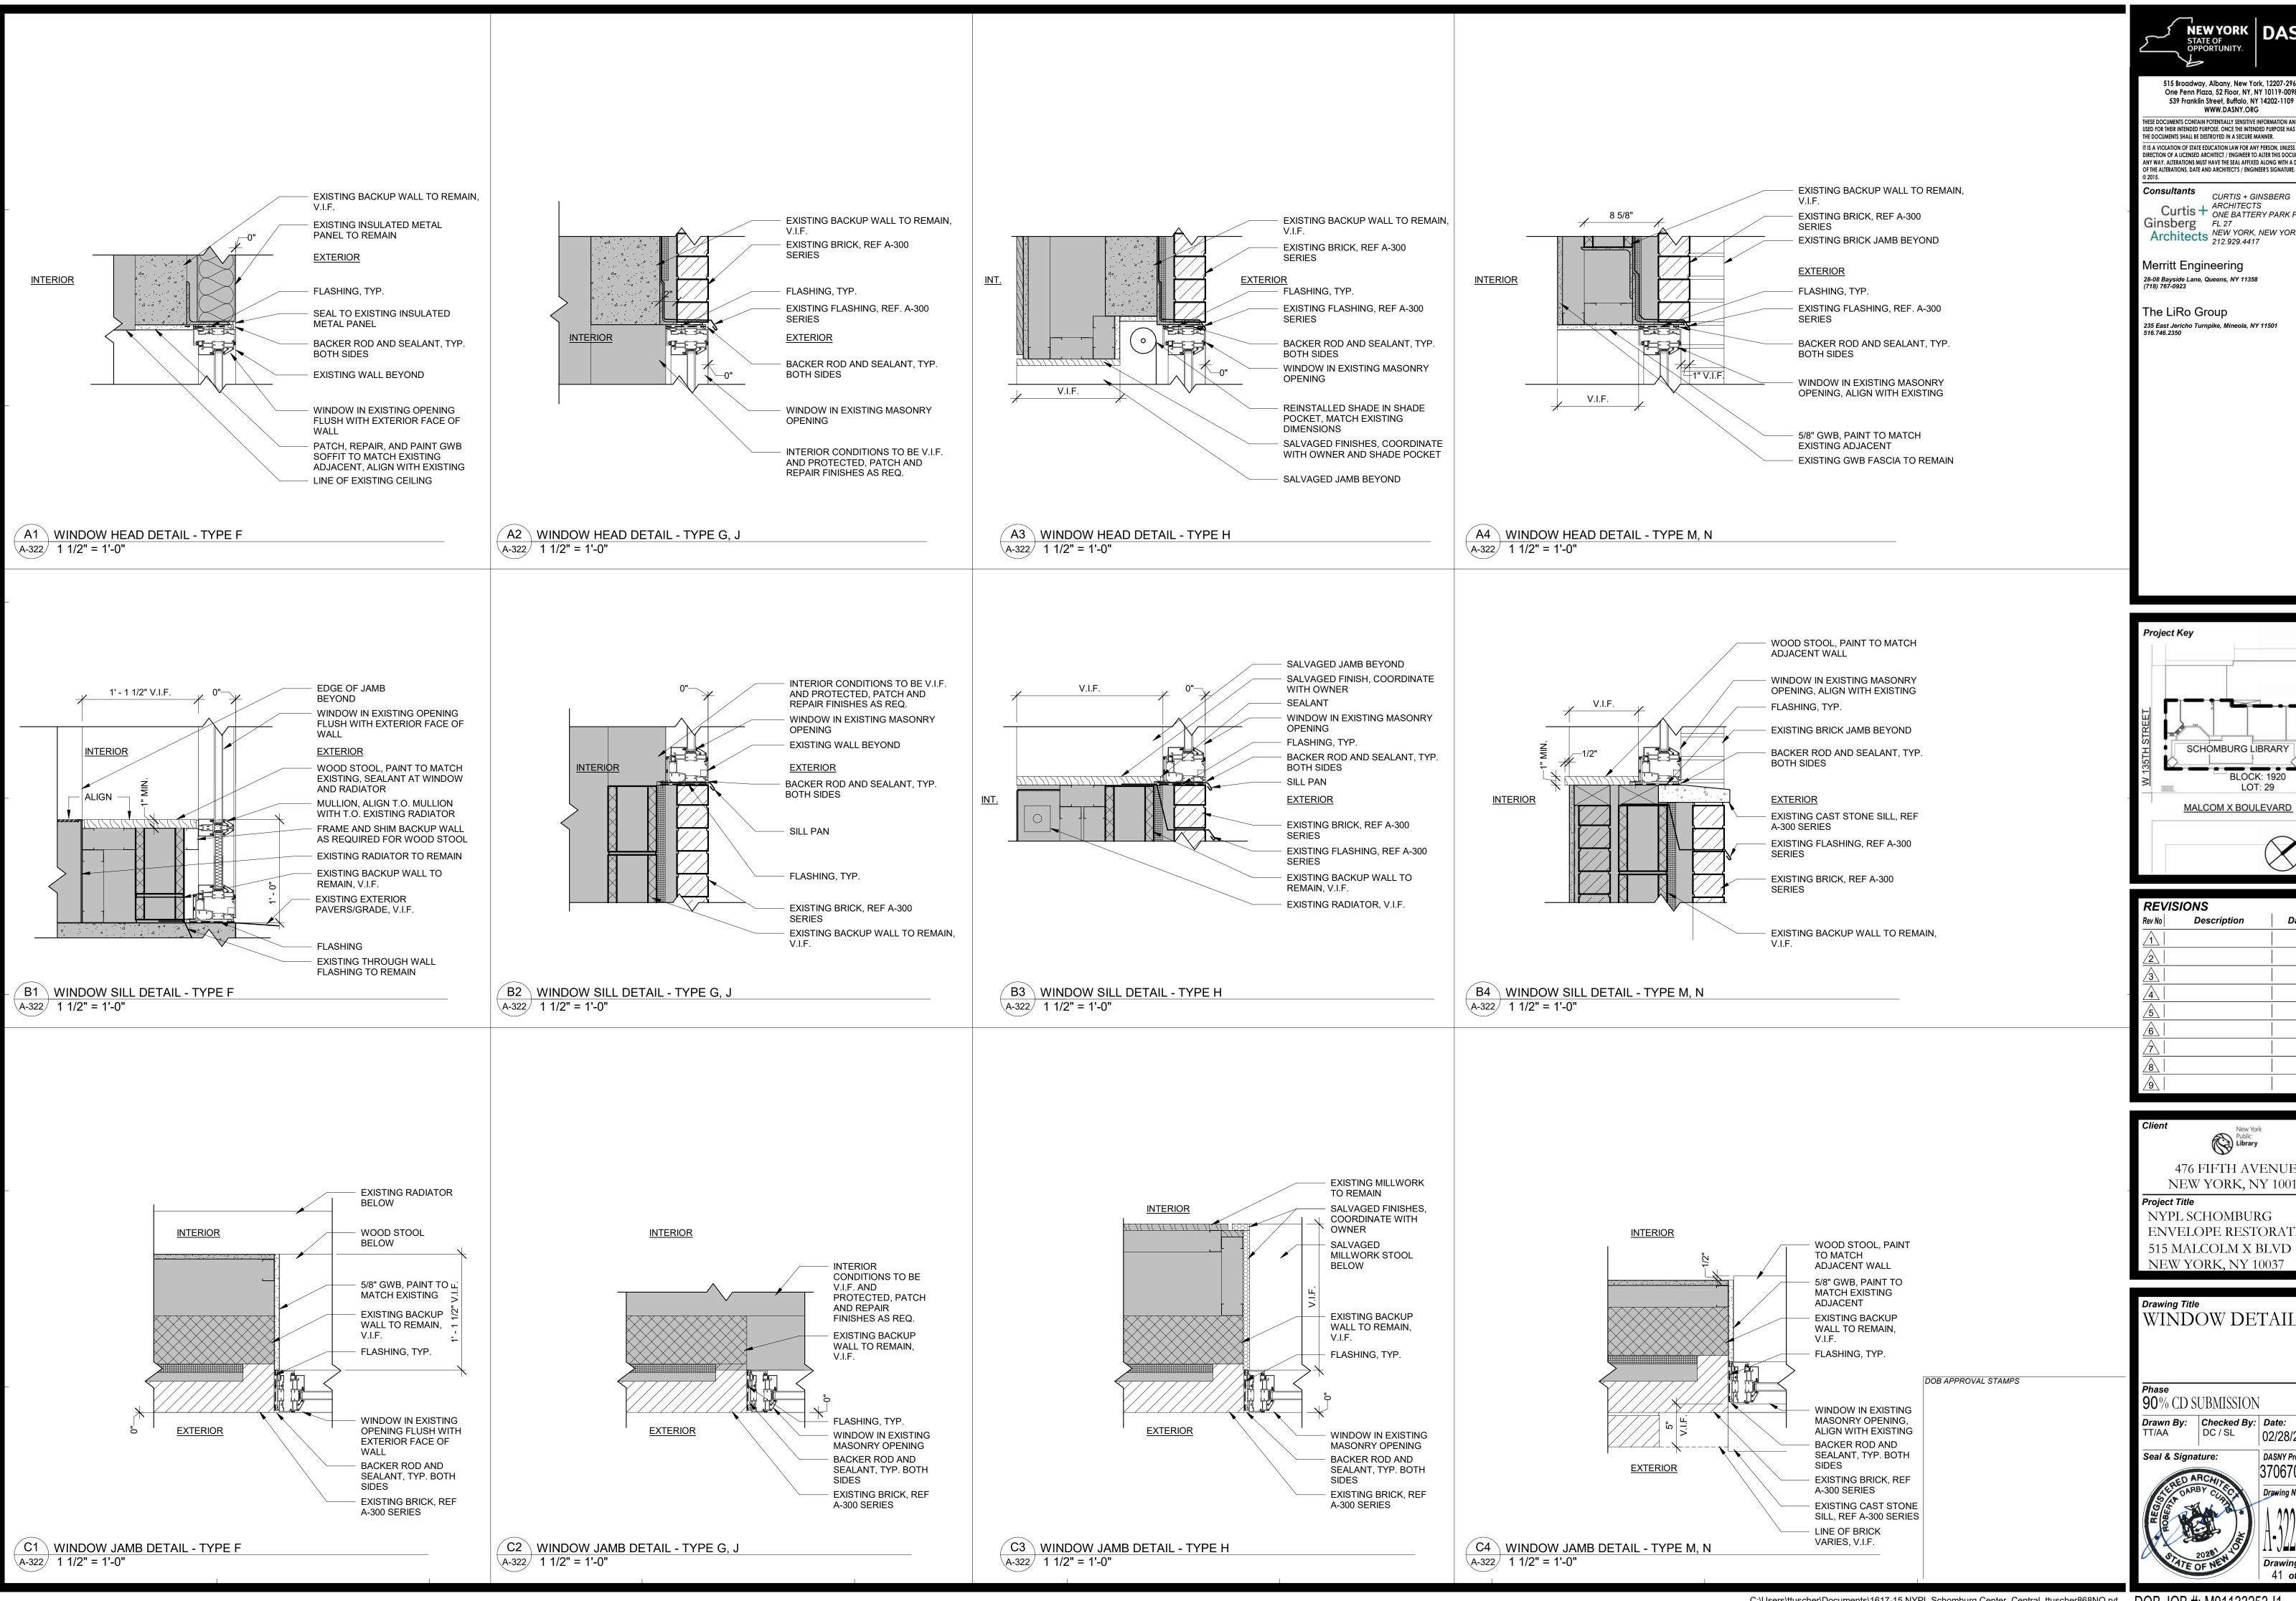


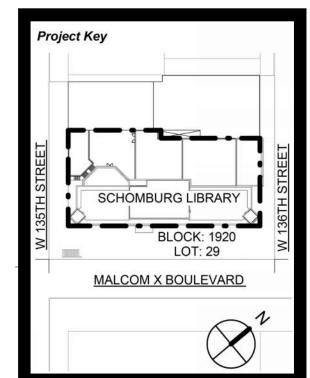



Rev No	Description	Date:
1		
2		
3		
4		
<u></u> 5		
<u>6</u>		
<u> </u>		
8		
9		

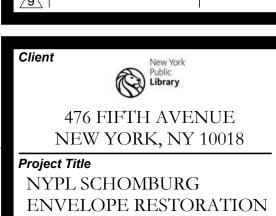





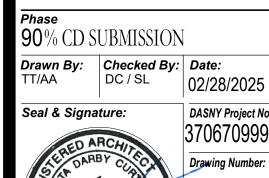


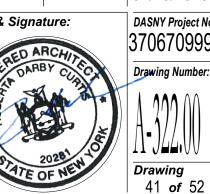


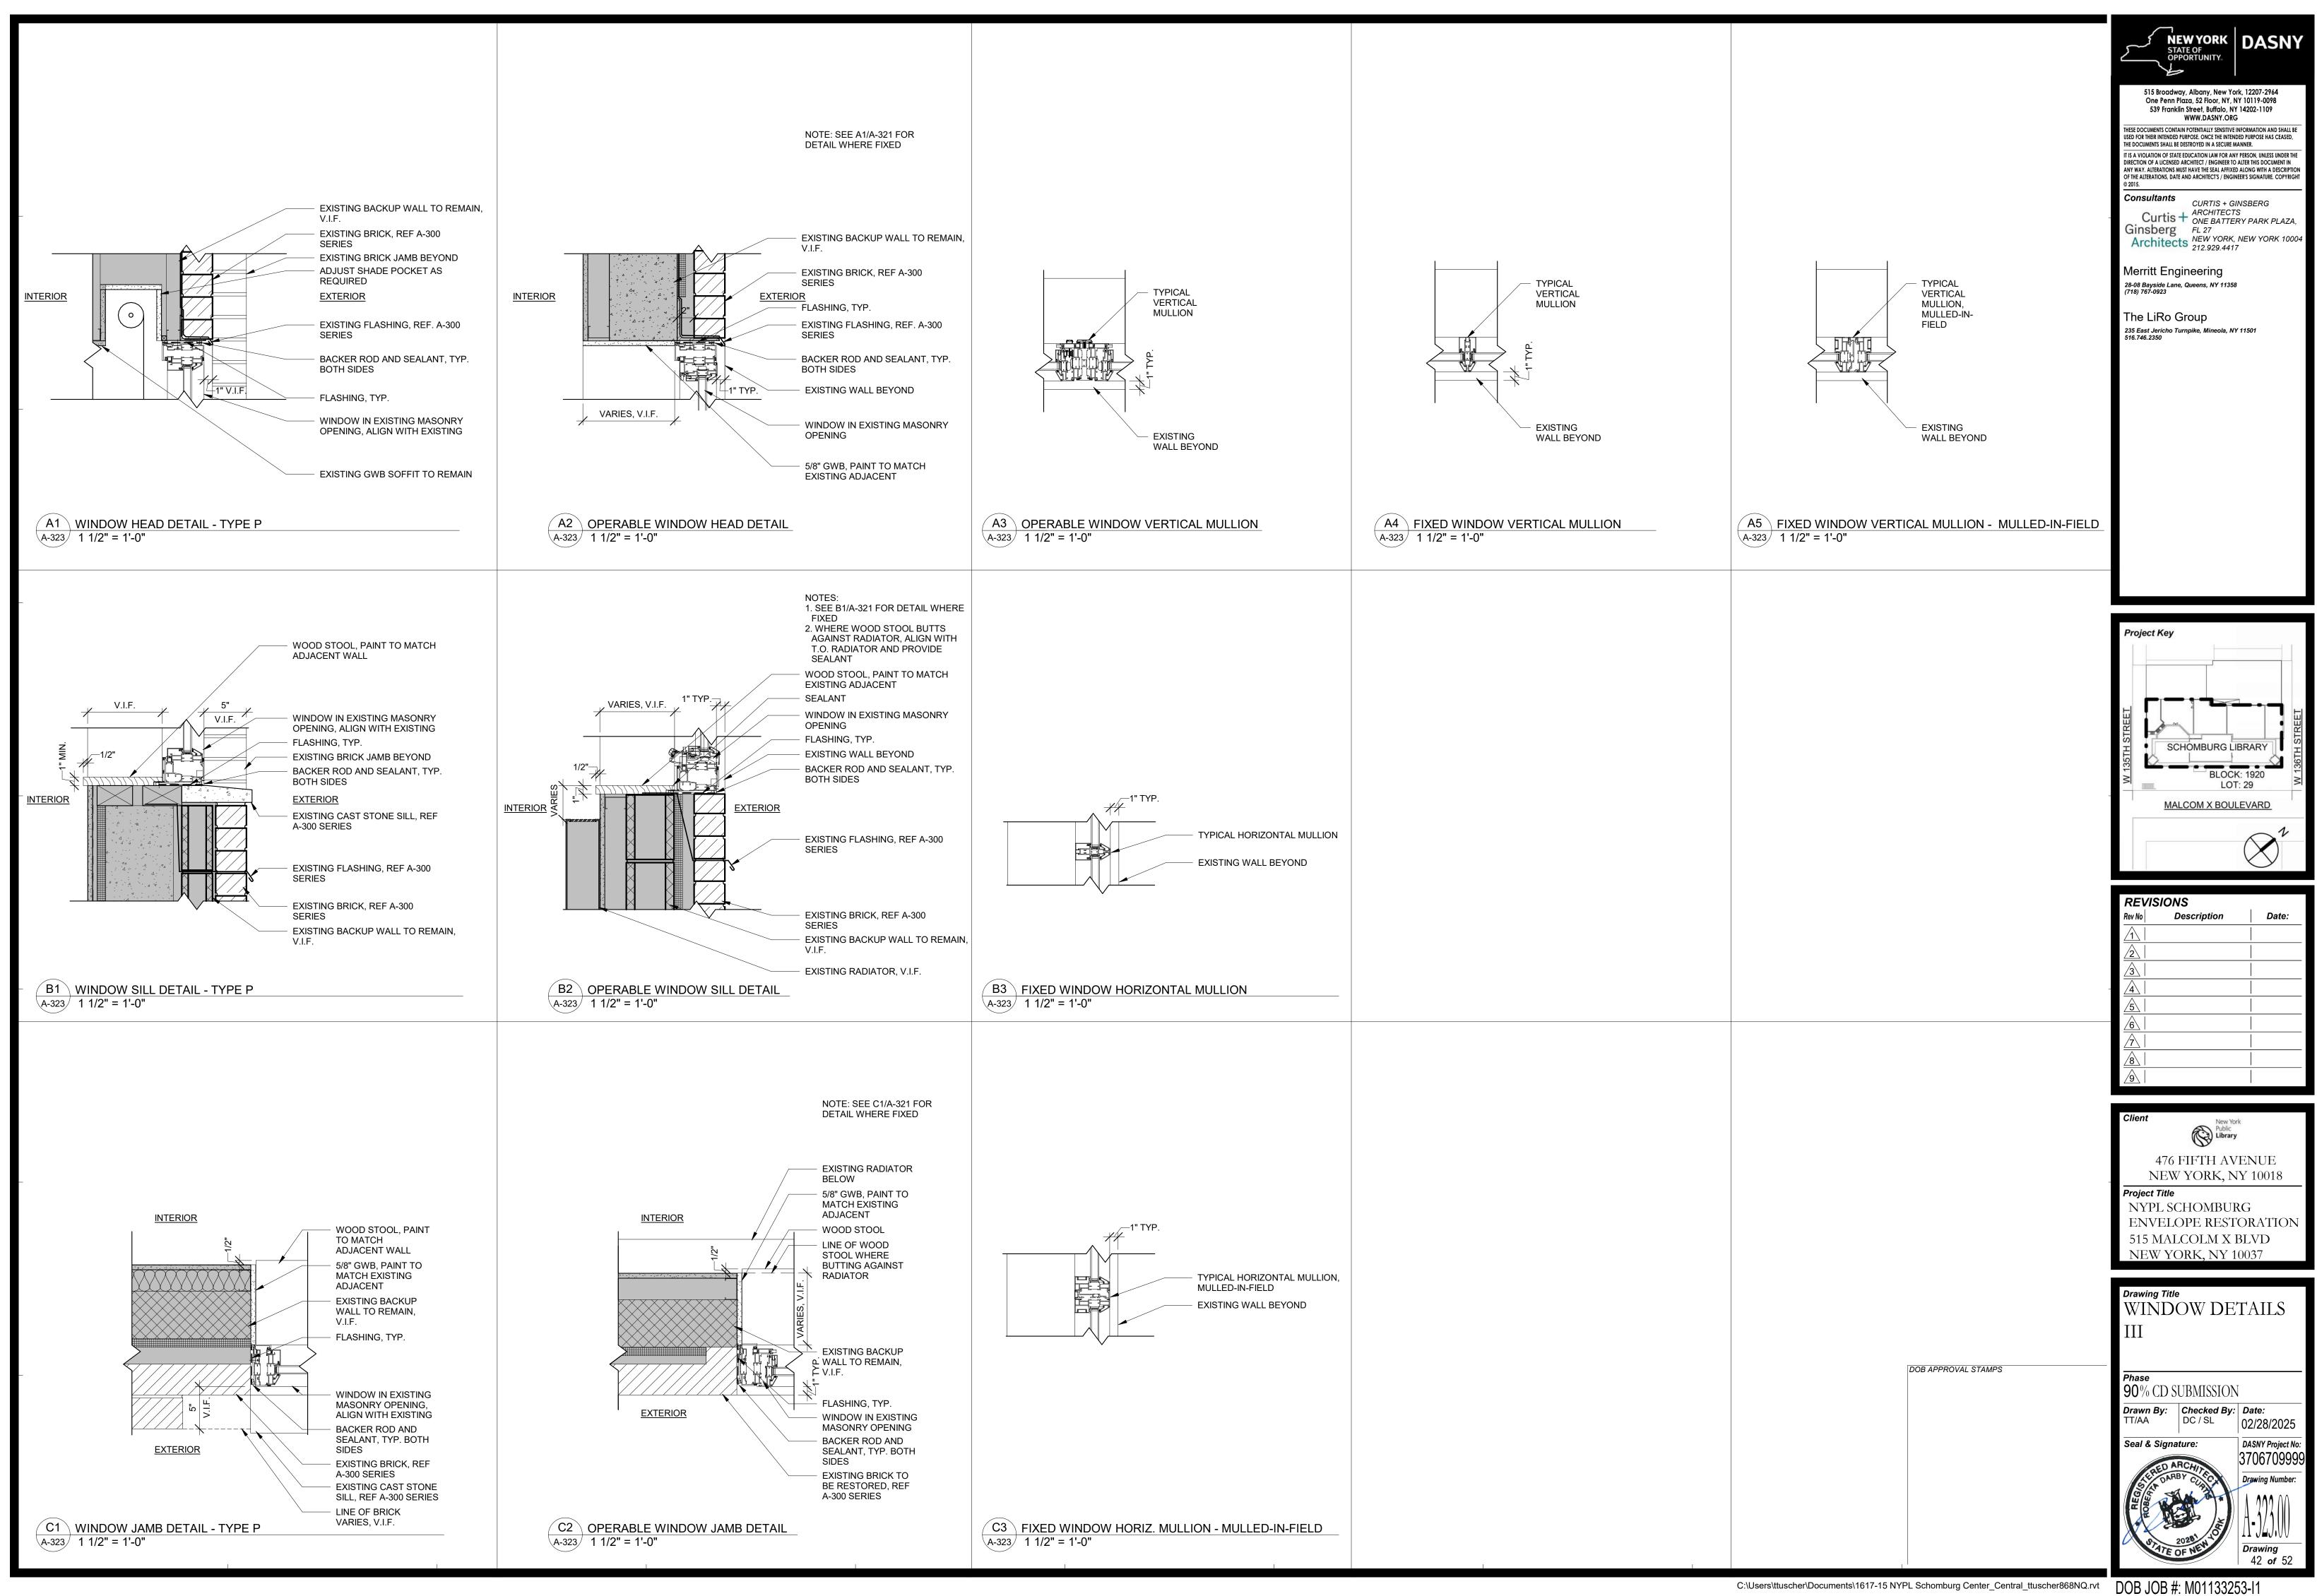

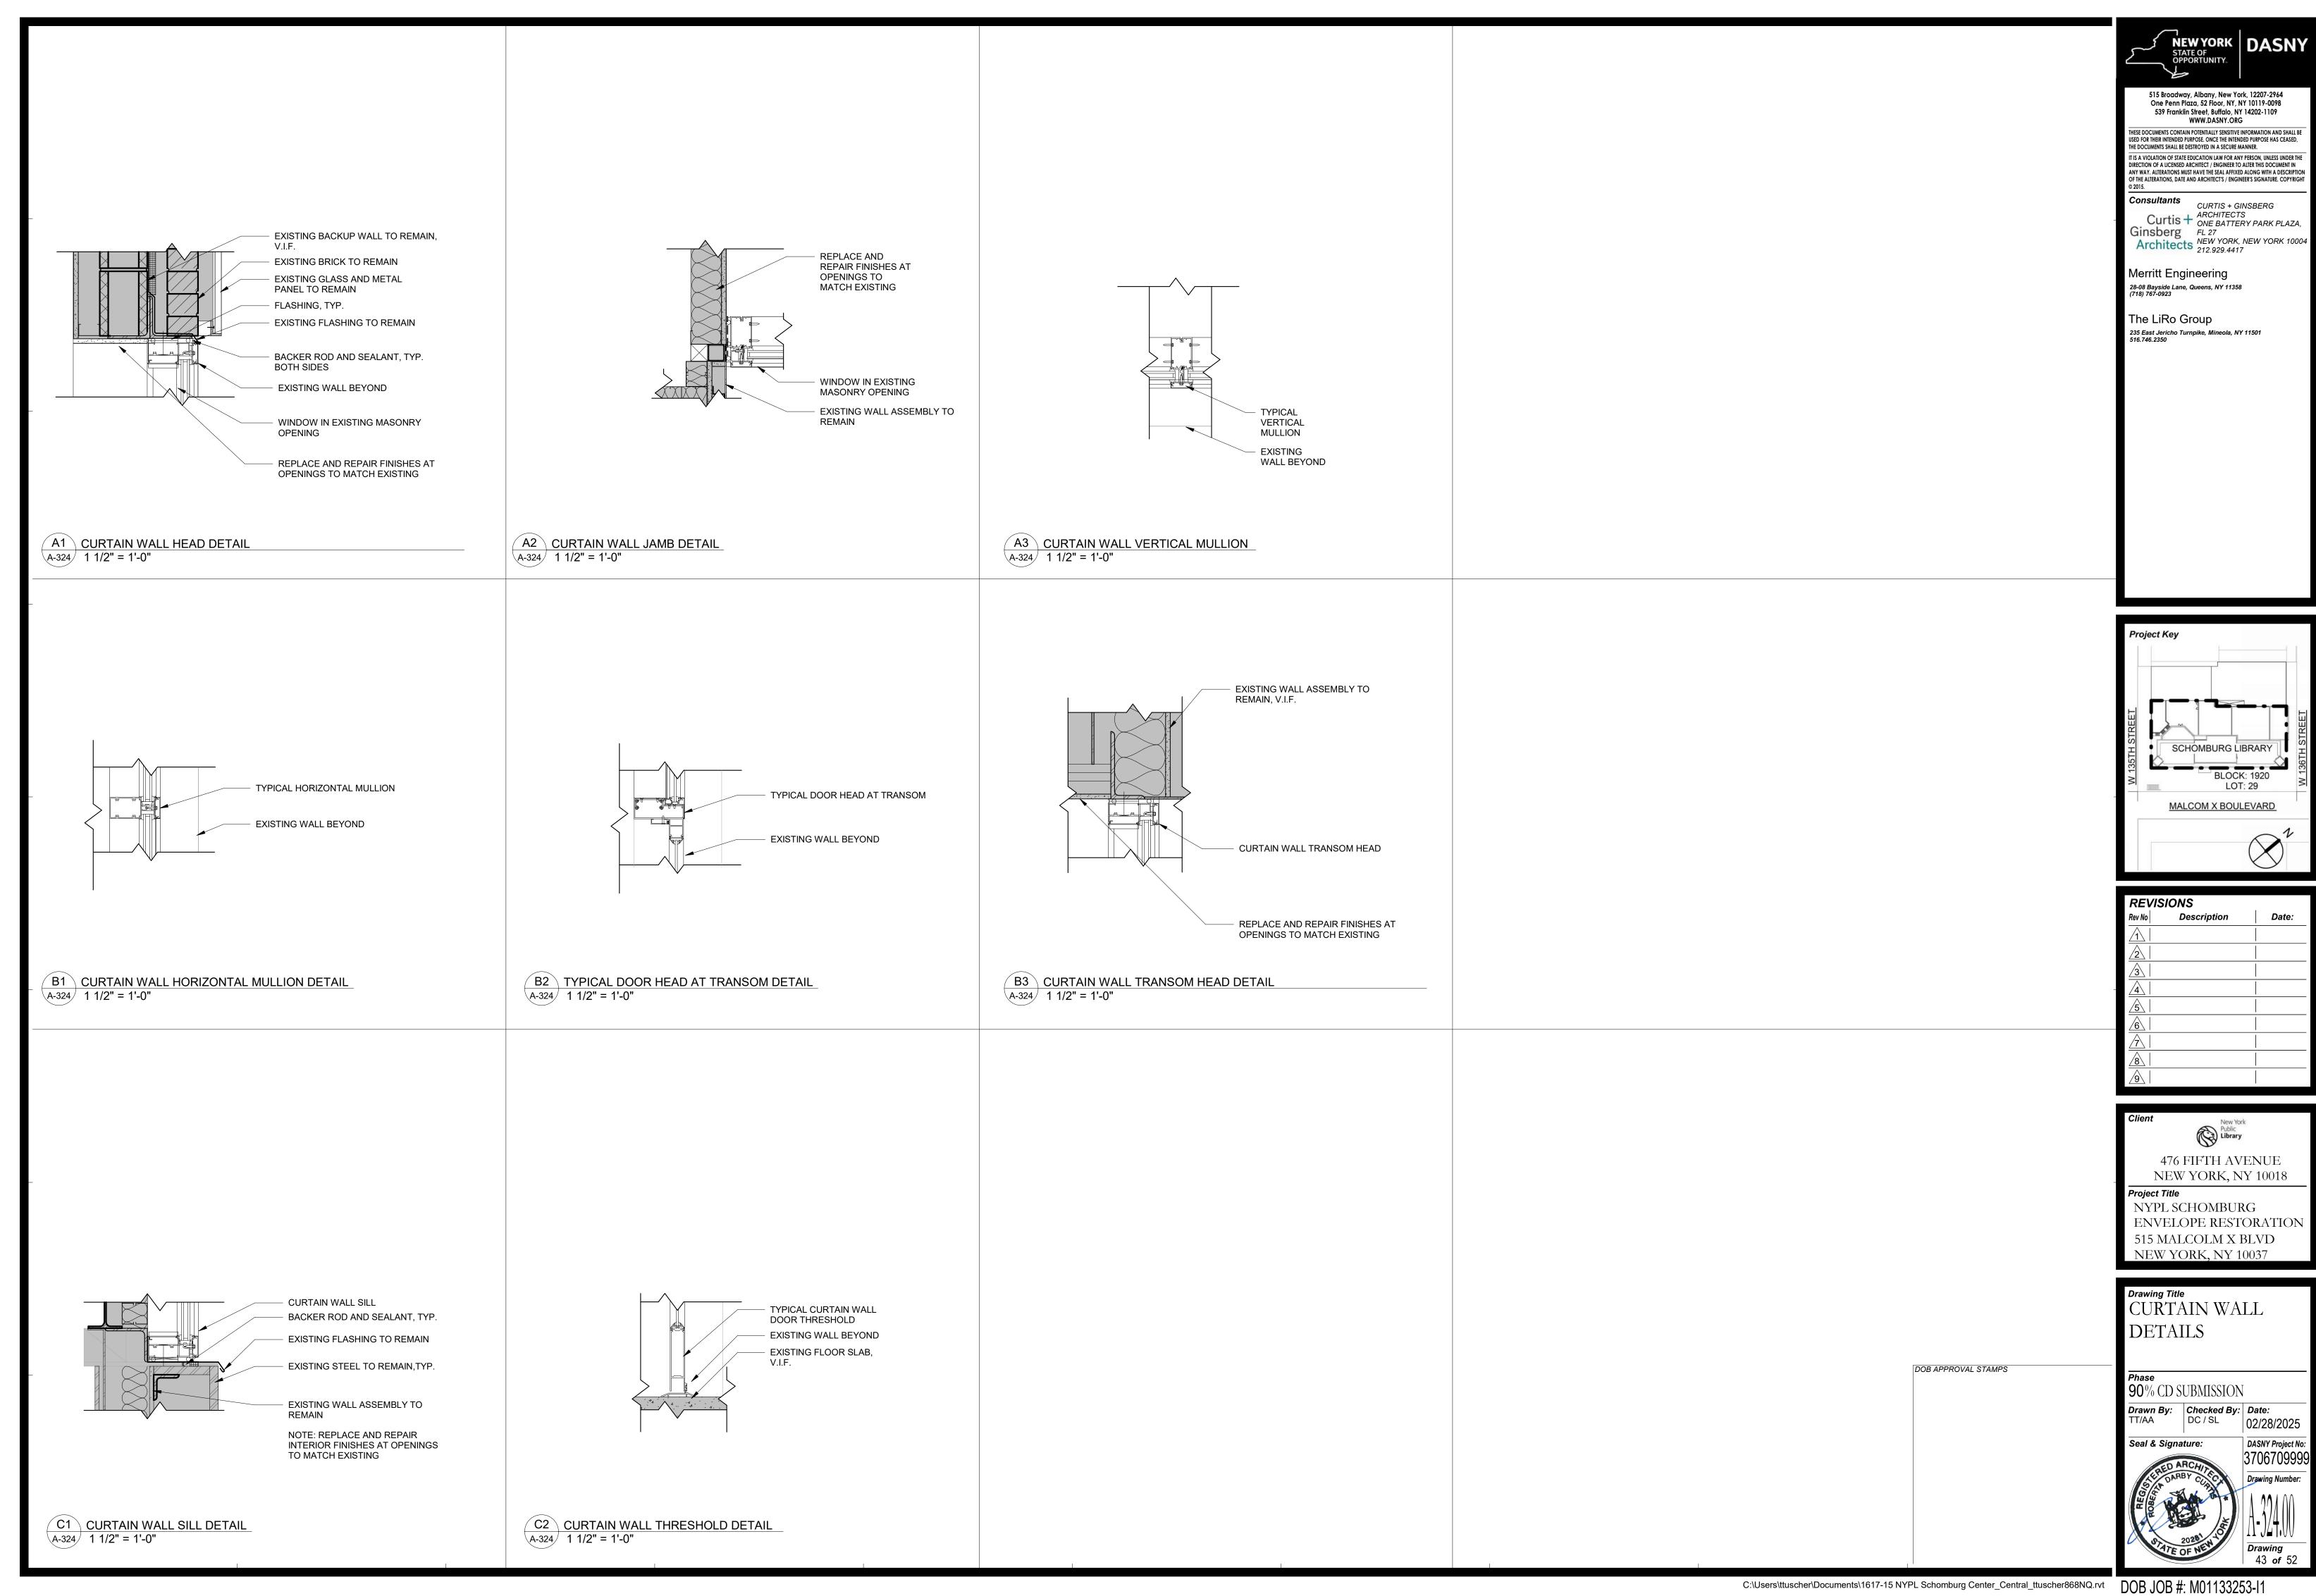

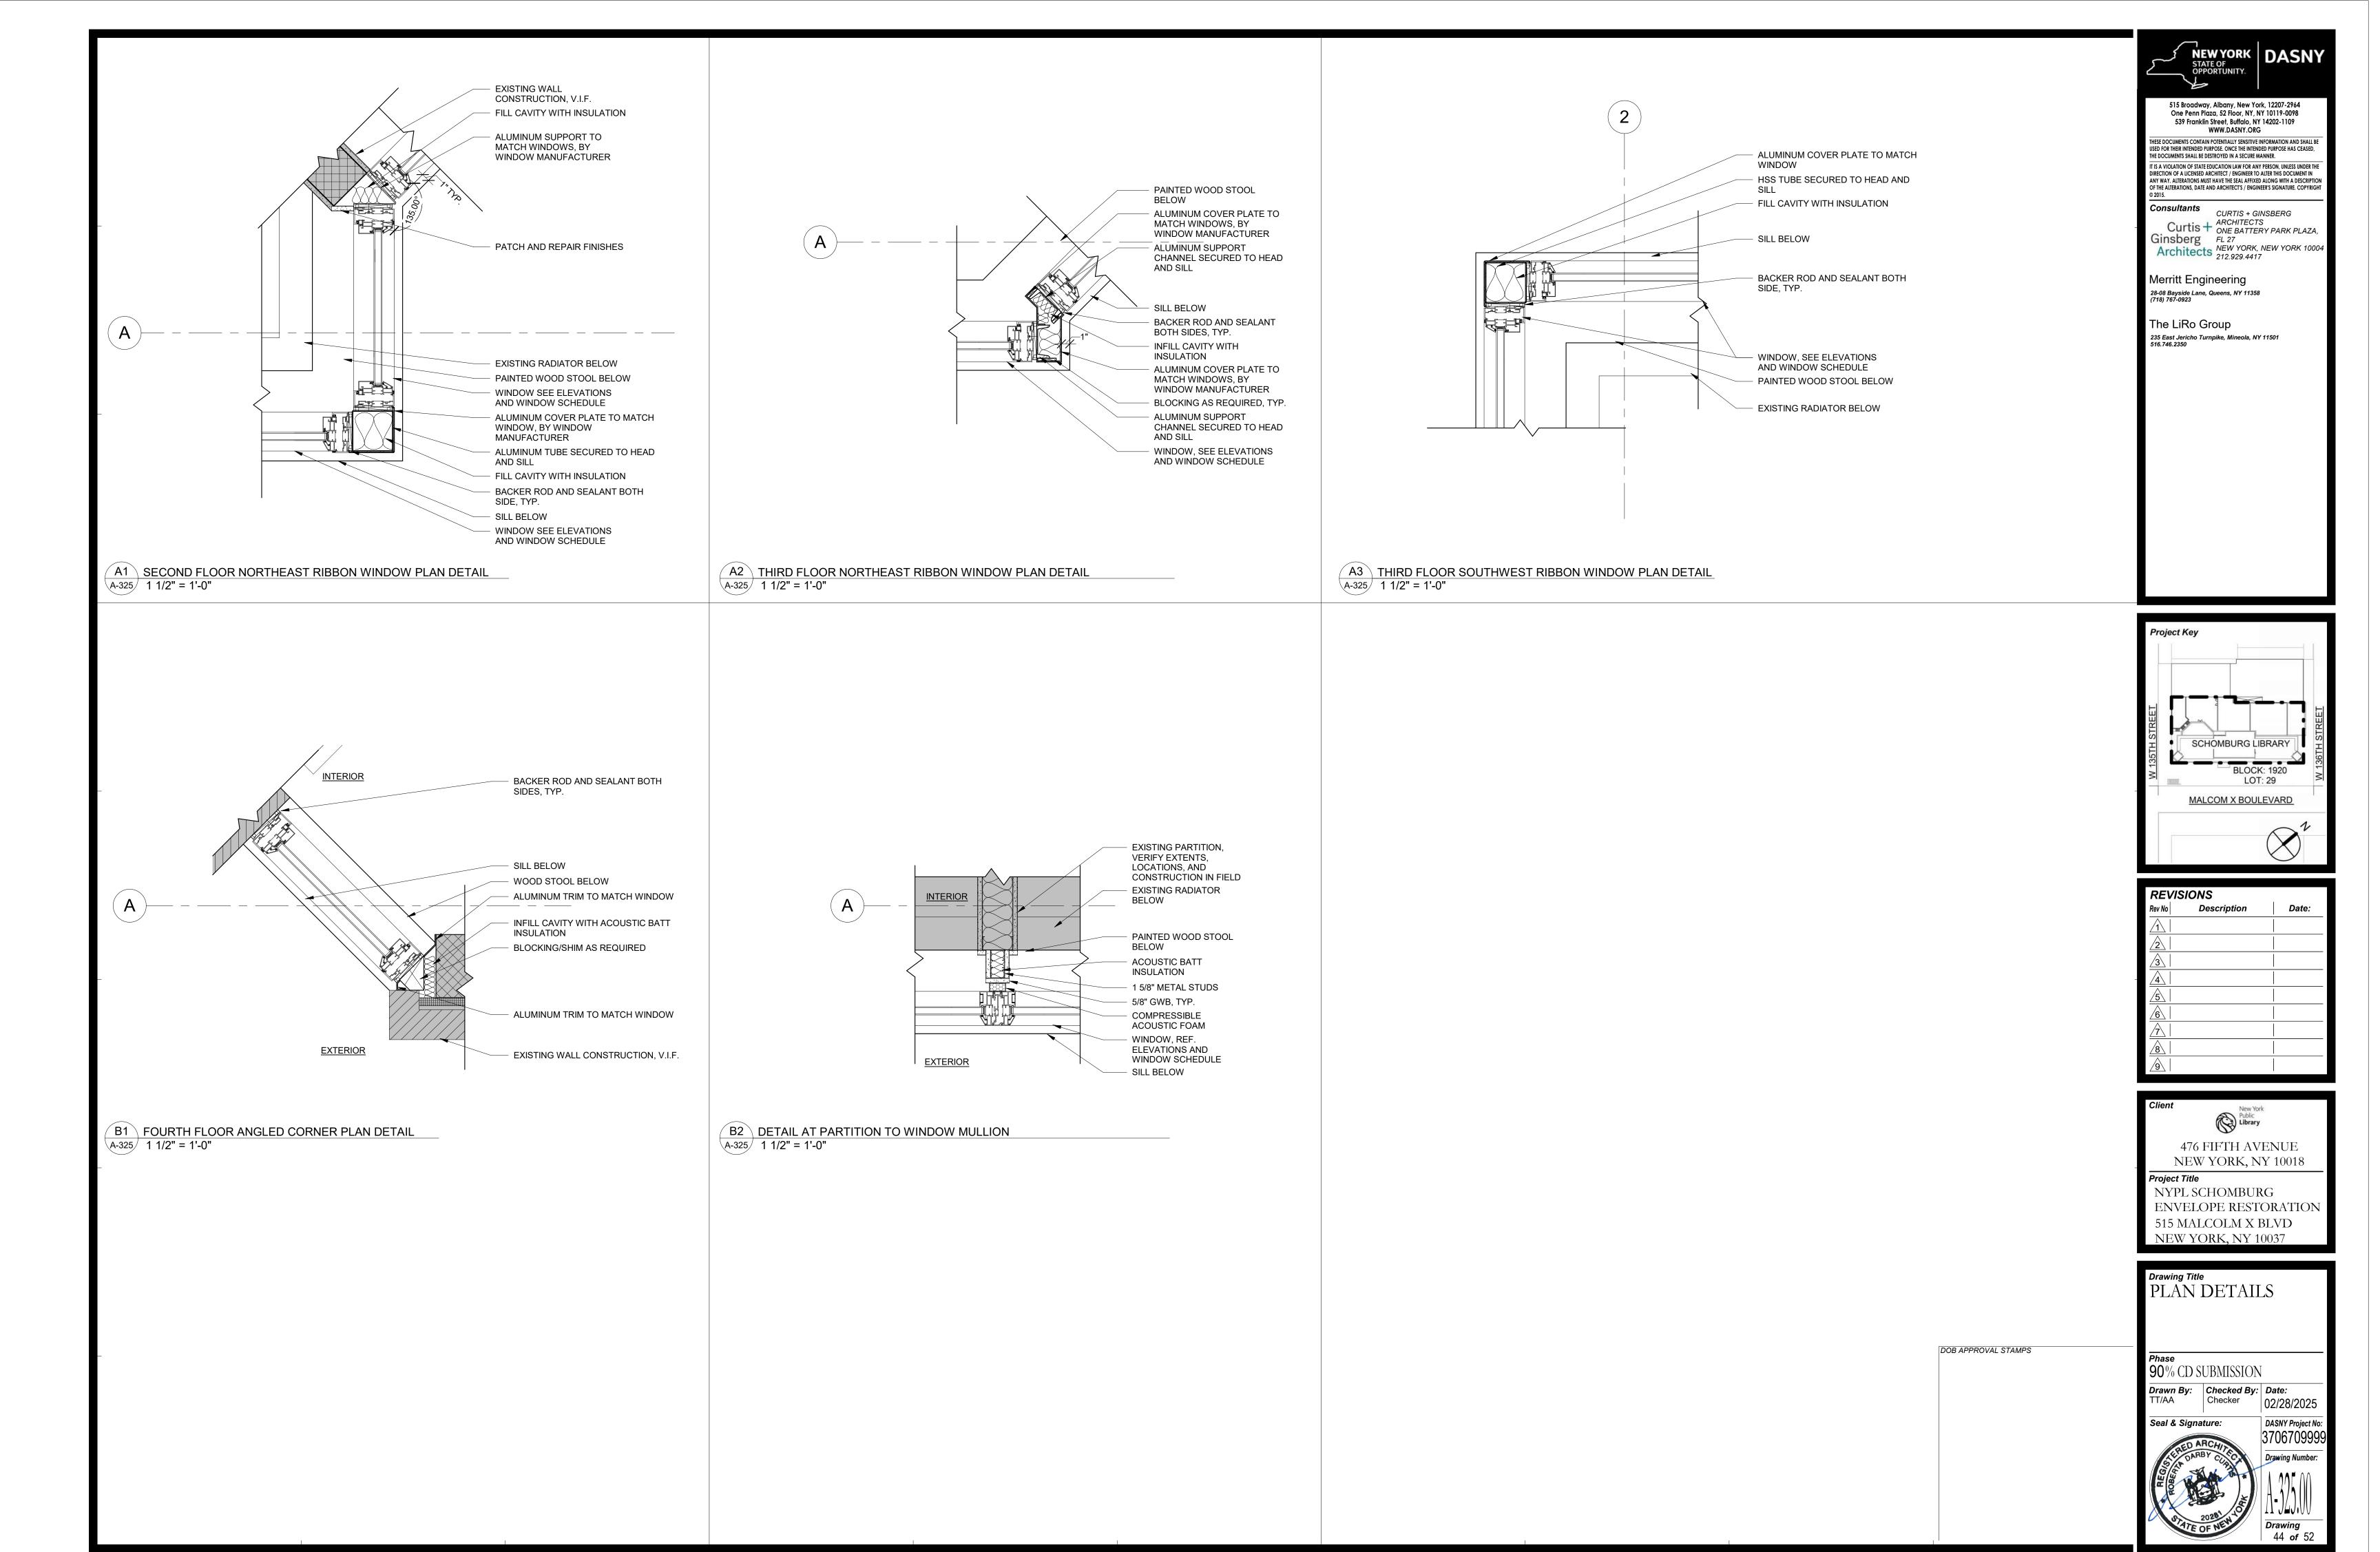

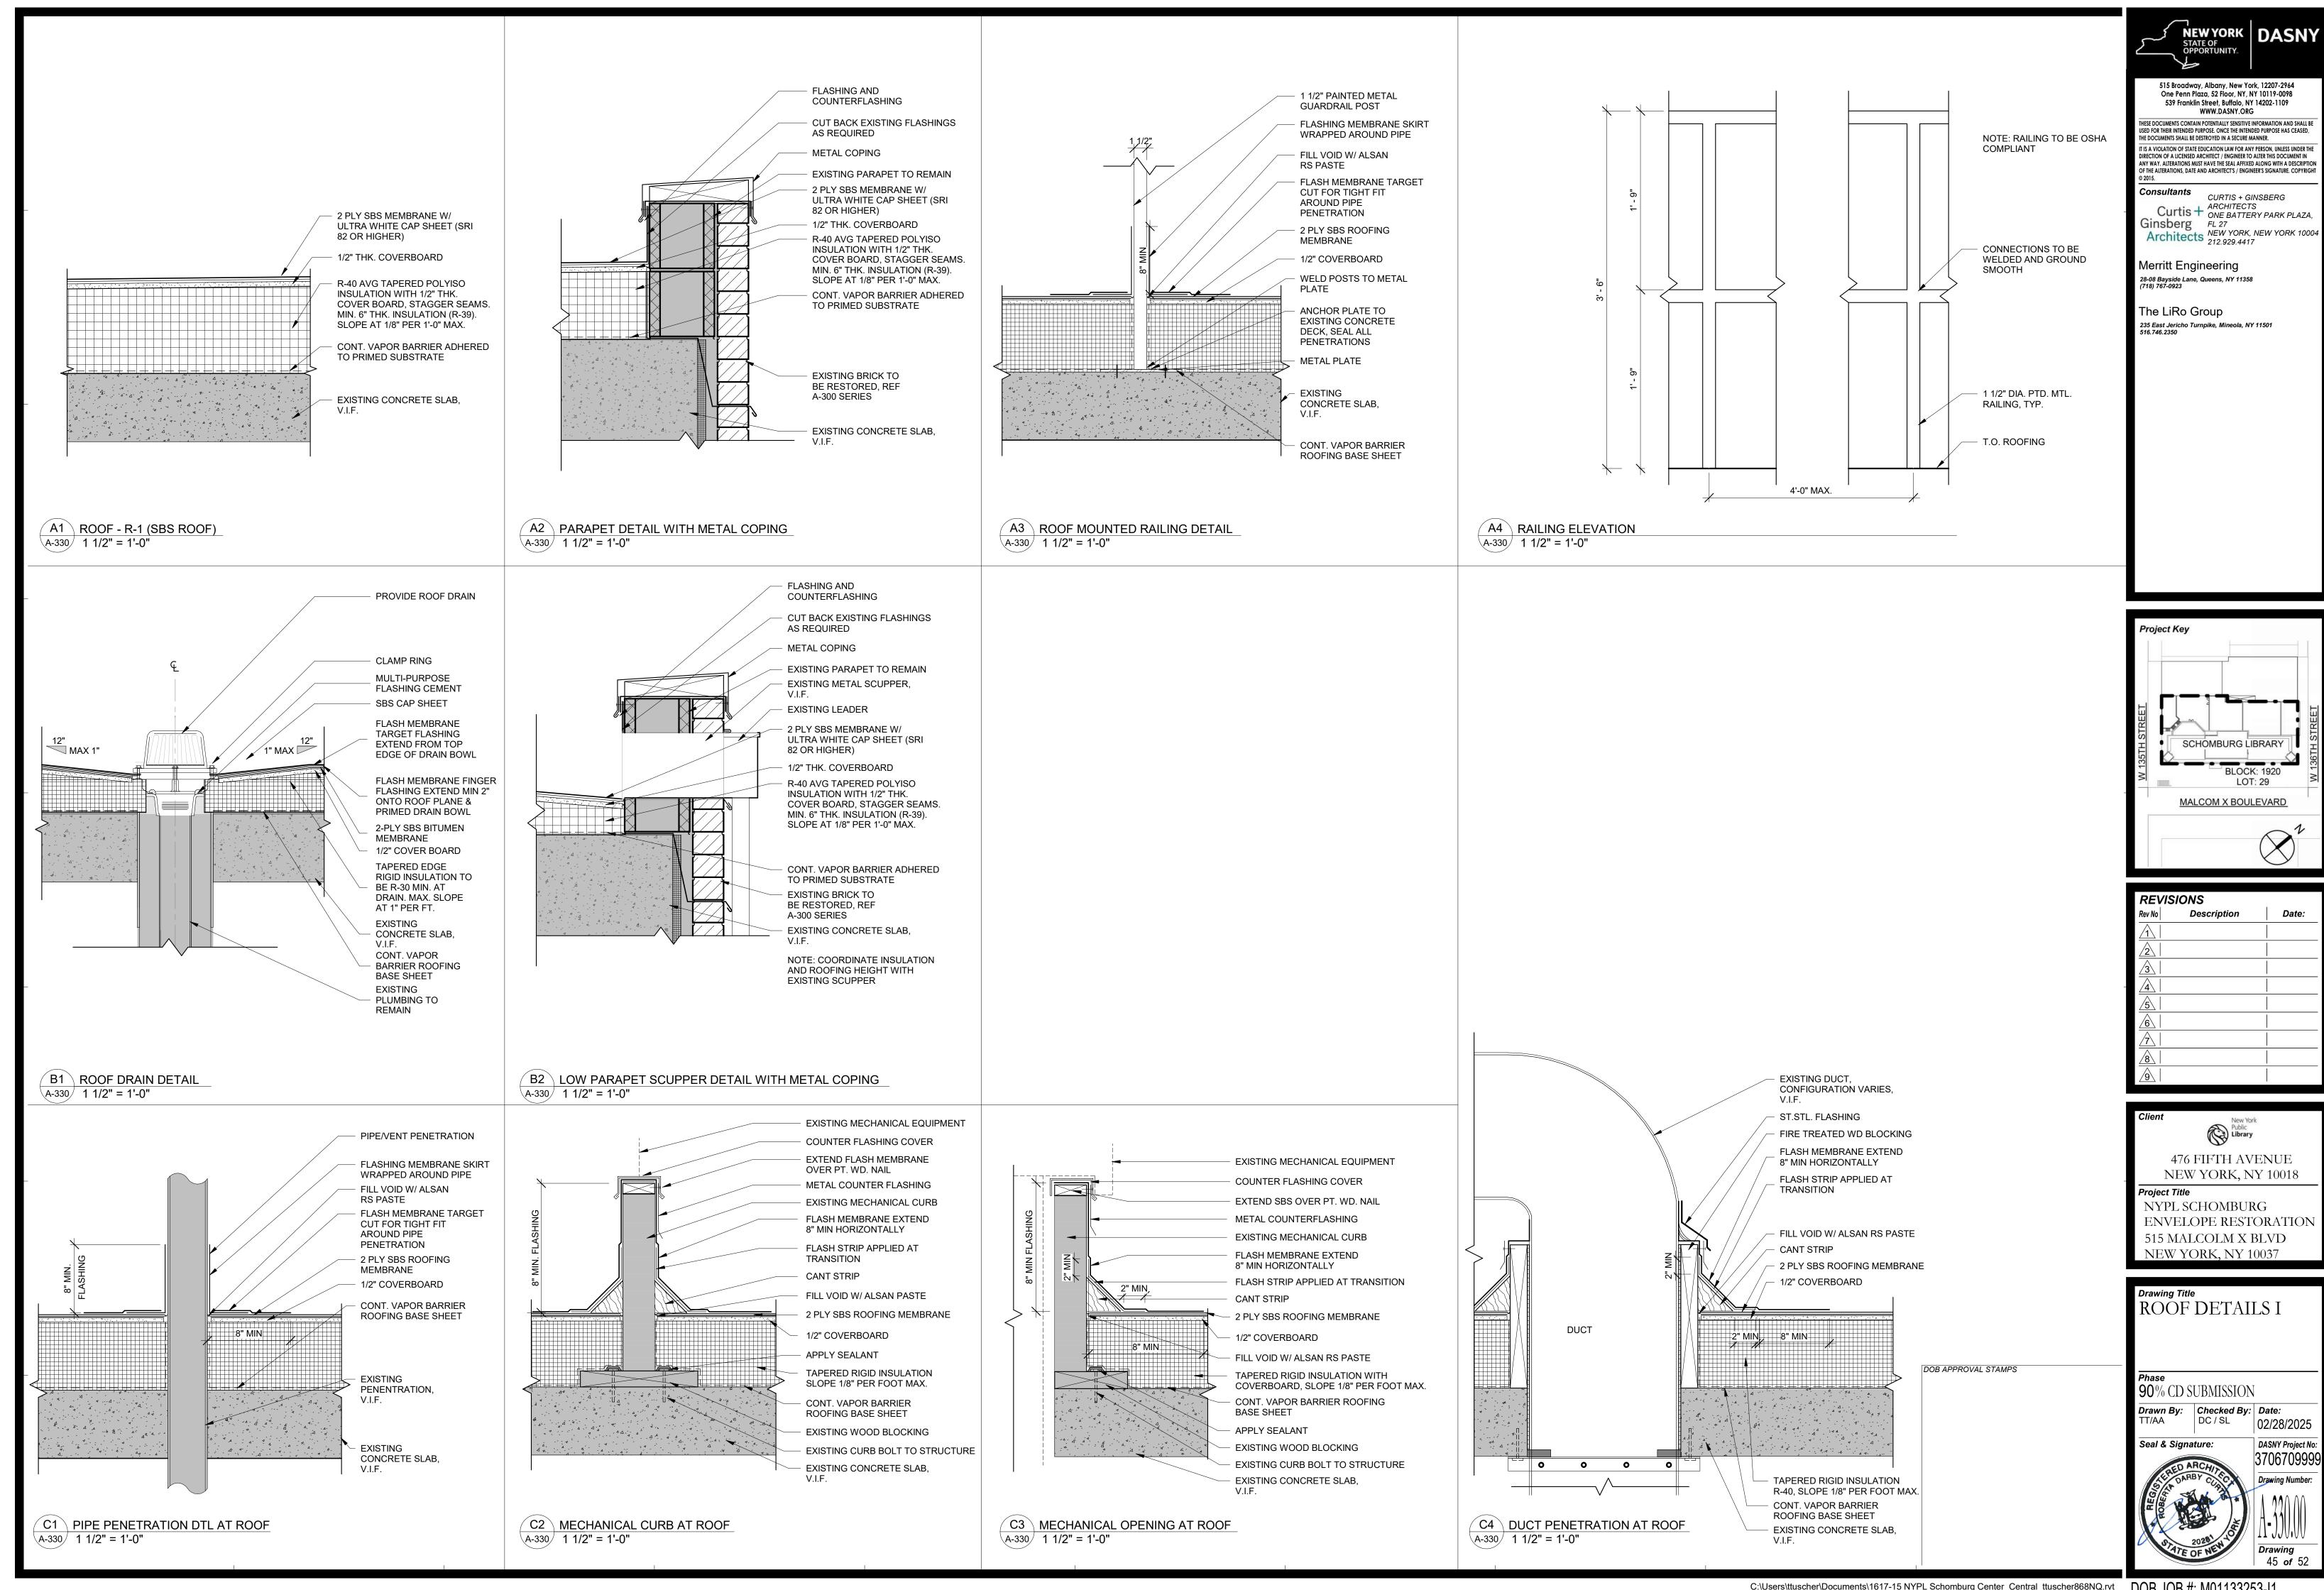

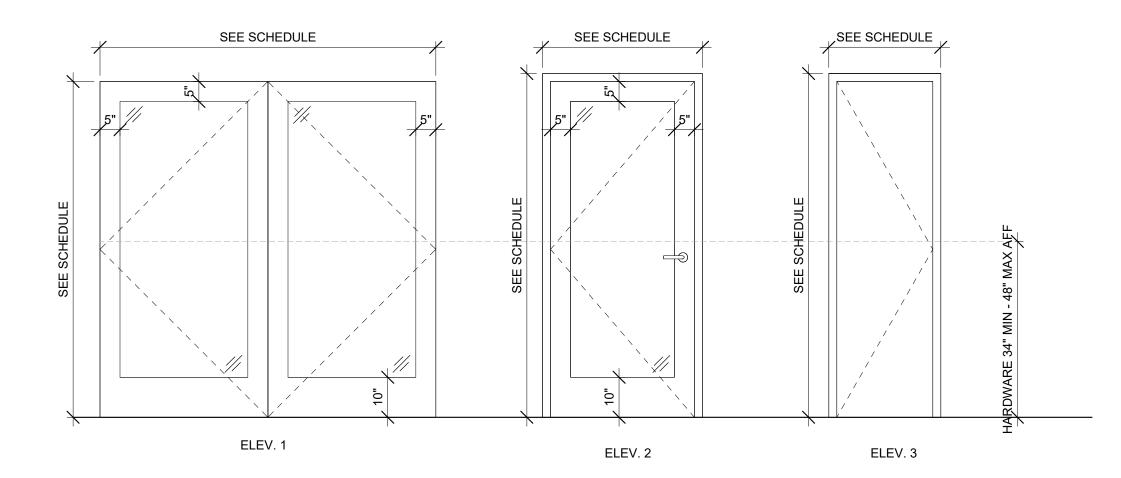


DOOR SCHEDULE

				DOO	R		FR	AME			DETAILS	DETAILS	
TYPE/NO	FROM ROOM - ROOM	ELEV#	MAT'L	WIDTH	HEIGHT	THICKNESS	MAT'L	W/KD	F.P. RATING	HARDWARE	HEAD/JAMB	THRESHOLD	NOTES
CELLAR	•												
129	ENTRANCE TO LIBRARY	1	ALUM	6' - 0"	7' - 5"		ALUM		-	001	B1/A-611	C2/A-611	
130	ENTRANCE TO THEATER LOBBY	2	ALUM	3' - 0"	7' - 0"	0' - 1 3/4"	ALUM			007	B1/A-611	C2/A-611	
131	ENTRANCE TO THEATER LOBBY	2	ALUM	3' - 0"	7' - 0"	0' - 1 3/4"	ALUM			007	B1/A-611	C2/A-611	
1ST FLOOR													
101	MAIN ENTRANCE TO VESTIBULE	1	ALUM	6' - 1"	7' - 3 1/2"		SS		-	003	B2/A-324	A2/A-611	
102	MAIN ENTRANCE TO VESTIBULE	1	ALUM	6' - 1"	7' - 3 1/2"		SS		-	002	B2/A-324	A2/A-611	
103	VESTIBULE TO LIBRARY	1	ALUM	6' - 1"	7' - 3 1/2"		SS		-	006	B2/A-324	A2/A-611	
104	VESTIBULE TO LIBRARY	1	ALUM	6' - 1"	7' - 3 1/2"		SS		-	005	B2/A-324	A2/A-611	
3RD FLOOR		•											
301	LIBRARY TO ROOF	3	HM	2' - 0"	7' - 0"	0' - 1 3/4"	НМ		90 MIN	004	A1/A-611	A2/A-611	

GENERAL NOTES:

1. ALL FIRE RATED DOORS TO BE SELF CLOSING
2. V.I.F. ALL NEW DOORS IN EXISTING FRAMES

515 Broadway, Albany, New York, 12207-2964 One Penn Plaza, 52 Floor, NY, NY 10119-0098 539 Franklin Street, Buffalo, NY 14202-1109 WWW.DASNY.ORG THESE DOCUMENTS CONTAIN POTENTIALLY SENSITIVE INFORMATION AND SHALL BE USED FOR THEIR INTENDED PURPOSE. ONCE THE INTENDED PURPOSE HAS CEASED, THE DOCUMENTS SHALL BE DESTROYED IN A SECURE MANNER. IT IS A VIOLATION OF STATE EDUCATION LAW FOR ANY PERSON, UNLESS UNDER THE DIRECTION OF A LICENSED ARCHITECT / ENGINEER TO ALTER THIS DOCUMENT IN ANY WAY. ALTERATIONS, DATE AND ARCHITECTS / ENGINEER'S SIGNATURE. COPYRIGHT © 2015. Consultants CURTIS + GINSBERG ARCHITECTS ONE BATTERY PARK PLAZA, FL 27 Architects NEW YORK, NEW YORK 10004 212.929.4417 Merritt Engineering 28-08 Bayside Lane, Queens, NY 11358 (718) 767-0923 The LiRo Group 235 East Jericho Turnpike, Mineola, NY 11501 516.746.2350	One Penn Plaza, 52 Floor, NY, NY 10119-0098 539 Franklin Street, Buffalo, NY 14202-1109 WWW.DASNY.ORG THESE DOCUMENTS CONTAIN POTENTIALLY SENSITIVE INFORMATION AND SHALL BE USED FOR THEIR INTENDED PURPOSE. ONCE THE INTENDED PURPOSE HAS CEASED, THE DOCUMENTS SHALL BE DESTROYED IN A SECURE MANNER. IT IS A VIOLATION OF STATE EDUCATION LAW FOR ANY PERSON, UNLESS UNDER THE DIRECTION OF A LICENSED ARCHITECT / ENGINEER TO ALITER THIS DOCUMENT IN ANY WAY. ALTERATIONS MUST HAVE THE SEAL AFFIXED ALONG WITH A DESCRIPTION OF THE ALTERATIONS, DATE AND ARCHITECTS / ENGINEER'S SIGNATURE. COPYRIGHT © 2015. Consultants CURTIS + GINSBERG ARCHITECTS ONE BATTERY PARK PLAZA, FL 27 Architects NEW YORK, NEW YORK 10004 212.929.4417 Merritt Engineering 28-08 Bayside Lane, Queens, NY 11358 (718) 767-0923 The LiRo Group 235 East Jericho Turnpike, Mineola, NY 11501		STATE	YORK OF RTUNITY.	DASNY
USED FOR THEIR INTENDED PURPOSE. ONCE THE INTENDED PURPOSE HAS CEASED, THE DOCUMENTS SHALL BE DESTROYED IN A SECURE MANNER. IT IS A VIOLATION OF STATE EDUCATION LAW FOR ANY PERSON, UNLESS UNDER THE DIRECTION OF A LICENSED ARCHITECT / ENGINEER TO ALTER THIS DOCUMENT IN ANY WAY. ALTERATIONS MUST HAVE THE SEAL AFFIXED ALONG WITH A DESCRIPTION OF THE ALTERATIONS, DATE AND ARCHITECTS / ENGINEER'S SIGNATURE. COPYRIGHT © 2015. Consultants CURTIS + GINSBERG ARCHITECTS ONE BATTERY PARK PLAZA, FL 27 Architects NEW YORK, NEW YORK 10004 212.929.4417 Merritt Engineering 28-08 Bayside Lane, Queens, NY 11358 (718) 767-0923 The LiRo Group 235 East Jericho Turnpike, Mineola, NY 11501	USED FOR THEIR INTENDED PURPOSE. ONCE THE INTENDED PURPOSE HAS CEASED, THE DOCUMENTS SHALL BE DESTROYED IN A SECURE MANNER. IT IS A VIOLATION OF STATE EDUCATION LAW FOR ANY PERSON, UNLESS UNDER THE DIRECTION OF A LICENSED ARCHITECT / ENGINEER TO ALTER THIS DOCUMENT IN ANY WAY. ALTERATIONS MUST HAVE THE SEAL AFFIXED ALONG WITH A DESCRIPTION OF THE ALTERATIONS, DATE AND ARCHITECTS / ENGINEER'S SIGNATURE. COPYRIGHT © 2015. Consultants CURTIS + GINSBERG ARCHITECTS ONE BATTERY PARK PLAZA, FL 27 Architects NEW YORK, NEW YORK 10004 212.929.4417 Merritt Engineering 28-08 Bayside Lane, Queens, NY 11358 (718) 767-0923 The LiRo Group 235 East Jericho Turnpike, Mineola, NY 11501	One	Penn Plazo Franklin St	a, 52 Floor, NY, treet, Buffalo, I	NY 10119-0098 NY 14202-1109
DIRECTION OF A LICENSED ARCHITECT / ENGINEER TO ALTER THIS DOCUMENT IN ANY WAY. ALTERATIONS MUST HAVE THE SEAL AFFIXED ALONG WITH A DESCRIPTION OF THE ALTERATIONS, DATE AND ARCHITECTS / ENGINEER'S SIGNATURE. COPYRIGHT © 2015. Consultants CURTIS + GINSBERG ARCHITECTS ONE BATTERY PARK PLAZA, FL 27 Architects NEW YORK, NEW YORK 10004 212.929.4417 Merritt Engineering 28-08 Bayside Lane, Queens, NY 11358 (718) 767-0923 The LiRo Group 235 East Jericho Turnpike, Mineola, NY 11501	DIRECTION OF A LICENSED ARCHITECT / ENGINEER TO ALTER THIS DOCUMENT IN ANY WAY. ALTERATIONS MUST HAVE THE SEAL AFFIXED ALONG WITH A DESCRIPTION OF THE ALTERATIONS, DATE AND ARCHITECTS / ENGINEER'S SIGNATURE. COPYRIGHT © 2015. Consultants CURTIS + GINSBERG ARCHITECTS ONE BATTERY PARK PLAZA, FL 27 Architects NEW YORK, NEW YORK 10004 212.929.4417 Merritt Engineering 28-08 Bayside Lane, Queens, NY 11358 (718) 767-0923 The LiRo Group 235 East Jericho Turnpike, Mineola, NY 11501	USED FOR THEIR II	NTENDED PURP	OSE. ONCE THE INTE	NDED PURPOSE HAS CEASED,
CURTIS + GINSBERG ARCHITECTS ONE BATTERY PARK PLAZA, FL 27 Architects NEW YORK, NEW YORK 10004 212.929.4417 Merritt Engineering 28-08 Bayside Lane, Queens, NY 11358 (718) 767-0923 The LiRo Group 235 East Jericho Turnpike, Mineola, NY 11501	CURTIS + GINSBERG ARCHITECTS ONE BATTERY PARK PLAZA, FL 27 Architects NEW YORK, NEW YORK 10004 212.929.4417 Merritt Engineering 28-08 Bayside Lane, Queens, NY 11358 (718) 767-0923 The LiRo Group 235 East Jericho Turnpike, Mineola, NY 11501	DIRECTION OF A ANY WAY, ALTER OF THE ALTERATION	LICENSED ARC ATIONS MUST H	HITECT / ENGINEER ' IAVE THE SEAL AFFI)	TO ALTER THIS DOCUMENT IN KED ALONG WITH A DESCRIPTION
28-08 Bayside Lane, Queens, NY 11358 (718) 767-0923 The LiRo Group 235 East Jericho Turnpike, Mineola, NY 11501	28-08 Bayside Lane, Queens, NY 11358 (718) 767-0923 The LiRo Group 235 East Jericho Turnpike, Mineola, NY 11501	Cur	rtis+ erg	ARCHITEC ONE BATTI FL 27	TS ERY PARK PLAZA,
The LiRo Group 235 East Jericho Turnpike, Mineola, NY 11501	The LiRo Group 235 East Jericho Turnpike, Mineola, NY 11501	Merritt	Engin	eering	
235 East Jericho Turnpike, Mineola, NY 11501	235 East Jericho Turnpike, Mineola, NY 11501			ueens, NY 113	58
		The LiF	Ro Gro	oup	
				oike, Mineola, I	NY 11501

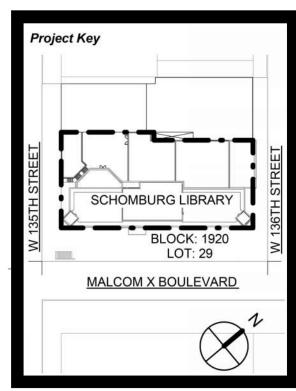

REVIS	IONS	
Rev No	Description	Date:
1		
2		
3		
4		
<u>5</u>		
<u>6</u>		
<u> </u>		
<u>8</u>		
9		

A76 FIFTH AVENUE
NEW YORK, NY 10018

Project Title
NYPL SCHOMBURG
ENVELOPE RESTORATION
515 MALCOLM X BLVD
NEW YORK, NY 10037


Drawing Title
DOOR SCHEDULE


Phase
90% CD SUBMISSION

Prawn By: Checked By: D

Drawn By: Checked By: Date: 02/28/2025

Seal & Signature: DASNY Project No: 3706709998

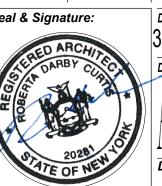


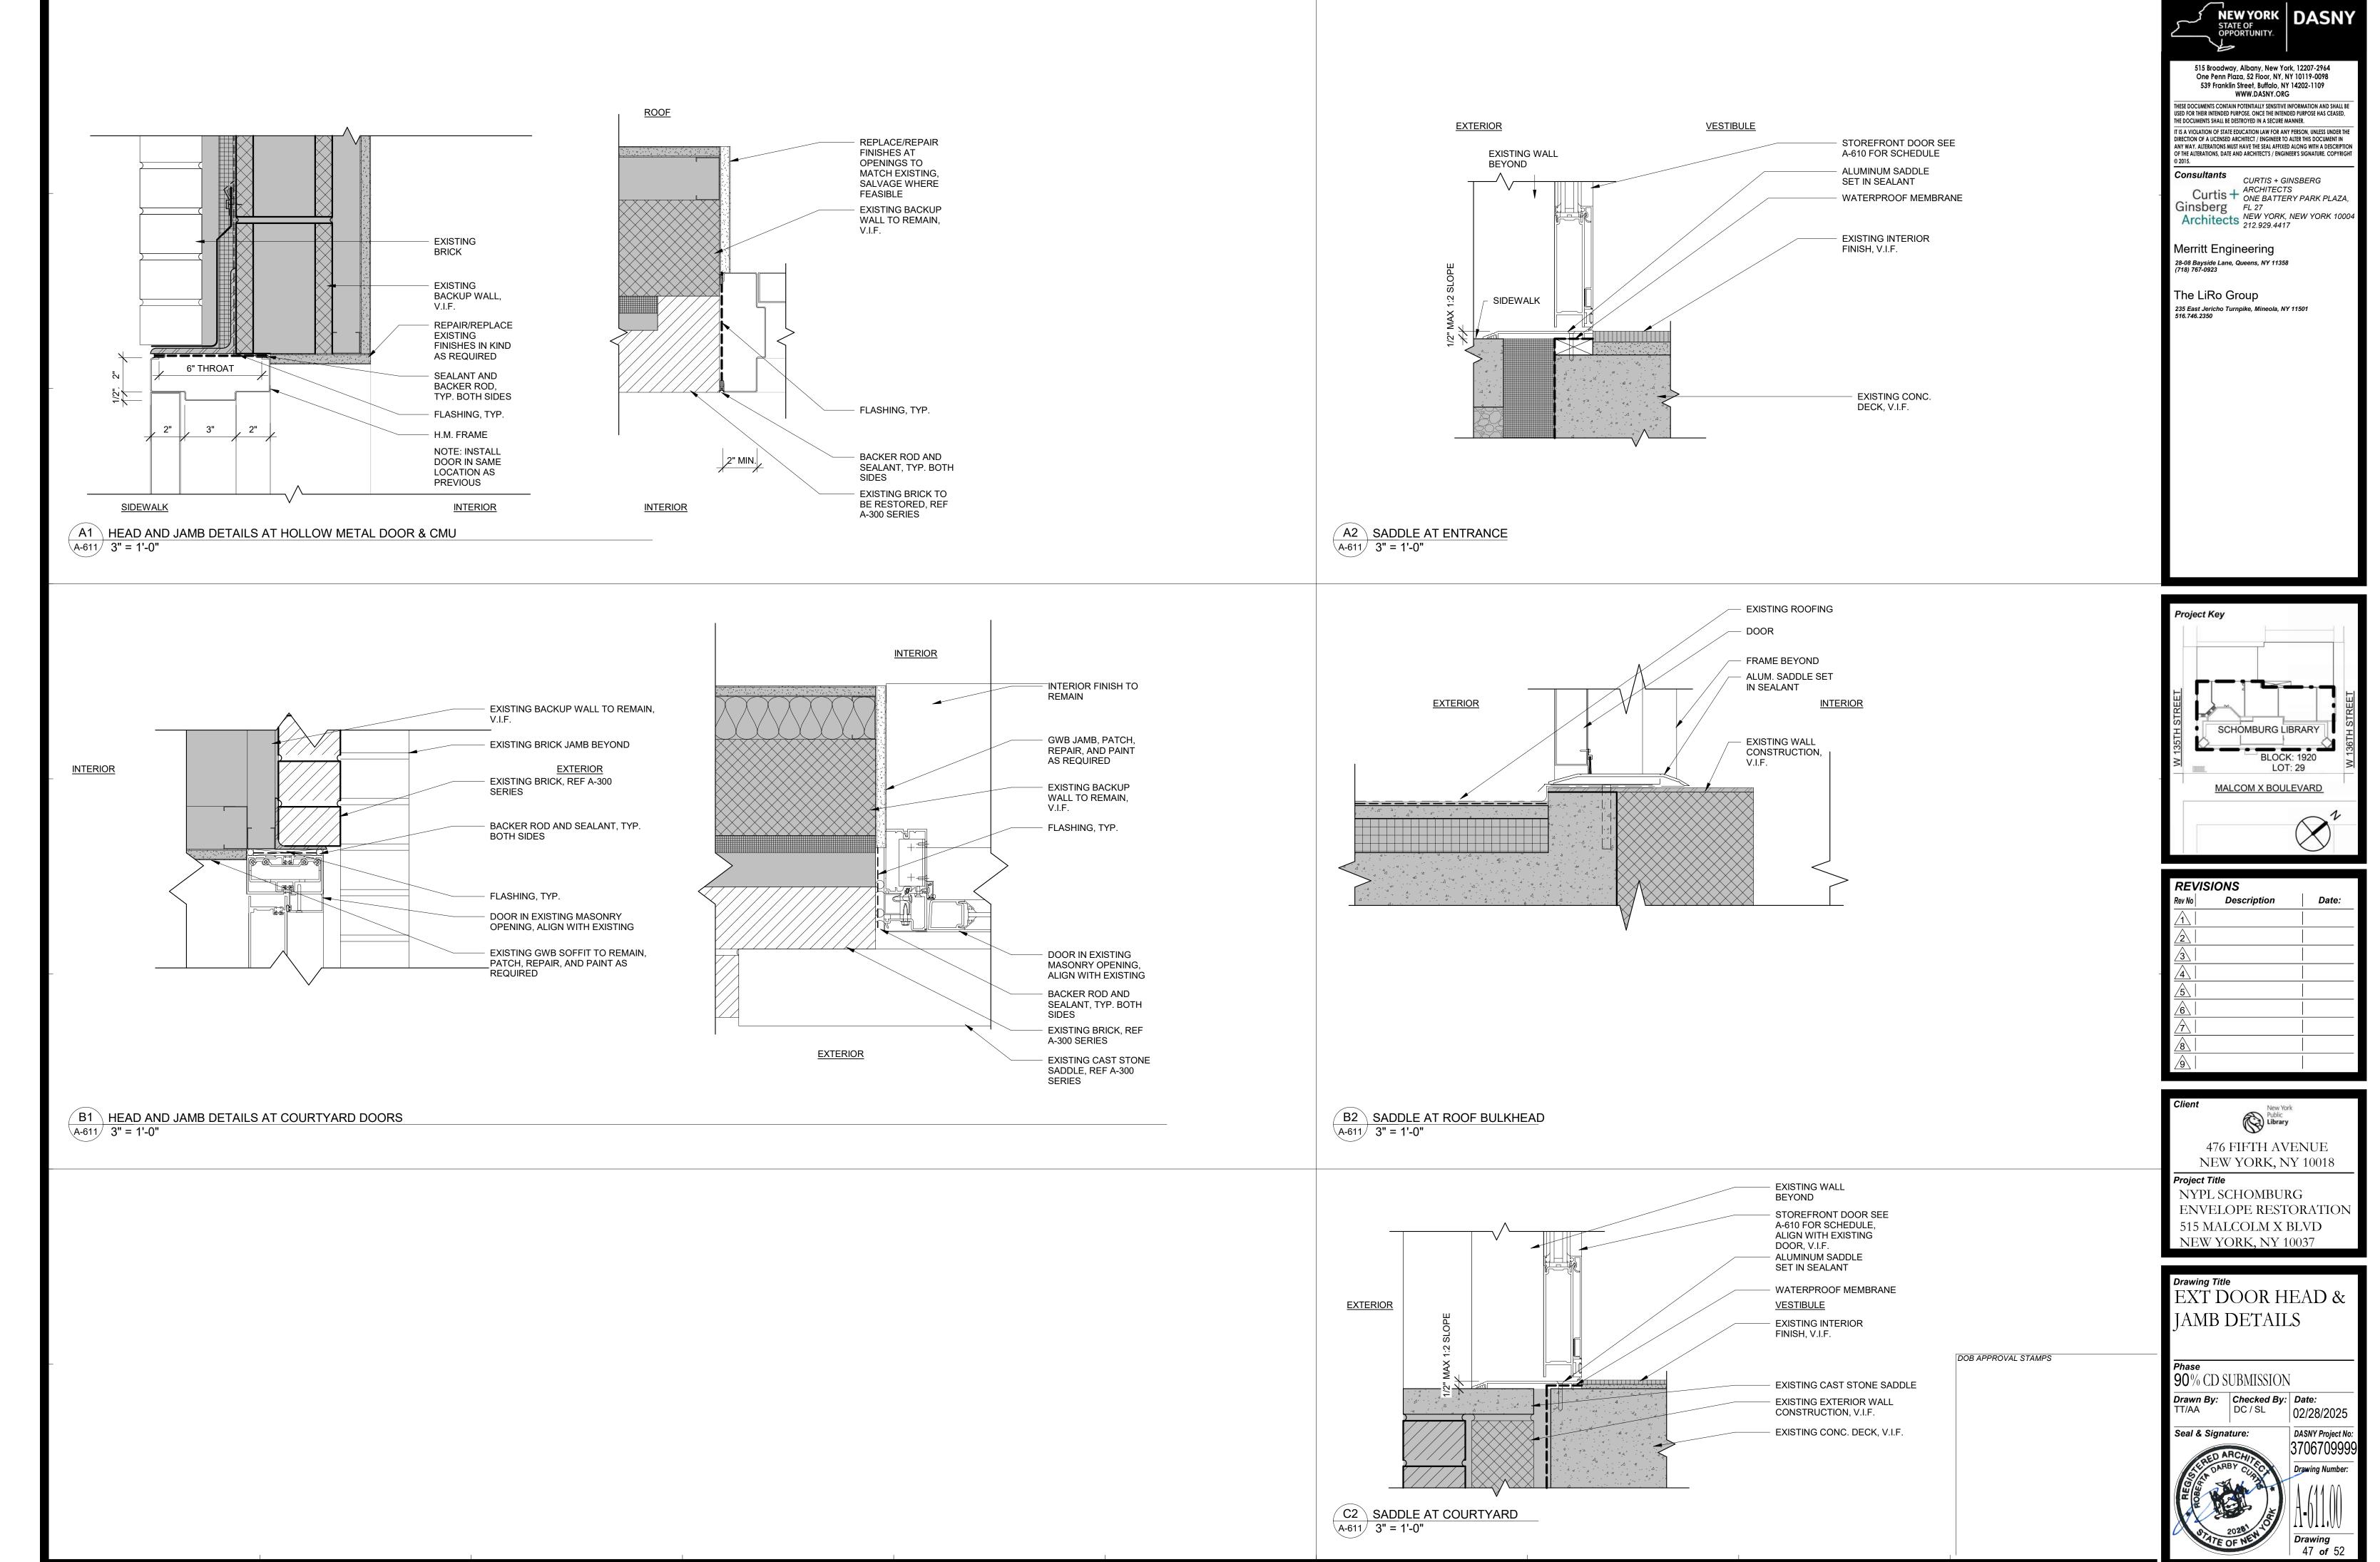



ASBESTOS ABATEMENT GENERAL NOTES, SCOPE OF WORK AND DETAILS


WORK AREA NOTES:


- ALL WORK SHALL BE PERFORMED IN STRICT ACCORDANCE WITH THE PROJECT DOCUMENTS AND NYC DEP TITLE 15 ABATEMENT PROCEDURES, WHERE CONFLICTS OCCURS BETWEEN THE PROJECT DOCUMENTS AND APPLICABLE CODES, RULES AND REGULATIONS, THE MOST STRINGENT SHALL APPLY.
- 2. THE CONTRACTOR SHALL COORDINATE LOCATIONS OF DECONTAMINATION UNITS, EGRESS ROUTES, AND WASTE CONTAINER WITH THE OWNER'S REPRESENTATIVE (S). IN CASE LOCATIONS THAT ARE MORE APPROPRIATE FOR THE DECONTAMINATION UNIT ARE DETERMINED AT ANY TIME DURING THE ABATEMENT, THEY MAY BE RELOCATED.
- 3. THE CONTRACTOR SHALL DEFINE, AS PART OF THEIR PROJECT SPECIFIC WORK PLAN, THE LOCATION OF ACCESSIBLE TEMPORARY POWER AND WATER SUPPLY IN COORDINATION WITH THE OWNER'S REPRESENTATIVE. ABATEMENT CONTRACTOR MAY BE RESPONSIBLE FOR SUPPLYING 55-GALLON DRUMS FOR WATER SUPPLY AND GENERATORS FOR ELECTRIC SUPPLY.
- 4. ALL MATERIALS SHALL BE REMOVED COMPLETELY DOWN TO THE SUBSTRATE, TO A SURFACE THAT IS FREE AND CLEAR OF ALL RESIDUES AND MADE SUITABLE FOR REPLACEMENT MATERIALS. ABATEMENT CONTRACTOR SHALL LEAVE CLEAN DEMARCATIONS AT THE BORDERS OF REMOVALS TO FACILITATE REPLACEMENT MATERIALS.
- 5. PROJECT HAS BEEN PHASED BY THE ARCHITECT / ENGINEER. ABATEMENT CONTRACTOR SHALL BE RESPONSIBLE FOR COORDINATING WITH THE GENERAL CONTRACTOR FOR THE PERFORMANCE OF ABATEMNET RELATIVE TO EACH PHASE OF CONSTRUCTION.
- 6. THE CERTIFIED ASBESTOS PROJECT DESIGNER HAS REVIEWED NYC DEP ATRU REQUIREMENT WORK PERMIT OR FDNY FORMS.
- 7. ANY ASSUMED ACM OR PCB-CONTAINING MATERIALS MAY BE TESTED DURING CONSTRUCTION BY THE OWNER'S ENVIRONMENTAL CONSULTANT TO ASSESS ITS TRUE ASBESTOS / PCB CONTENT, IF ANY.
- 8. LOCATIONS OF ACM ARE SHOWN DIAGRAMMATICALLY AND THE ABATEMENT CONTRACTOR IS RESPONSIBLE FOR COORDINATING WITH OTHER TRADES FOR THE EXACT AND COMPLETE LOCATIONS OF ACM TO BE ABATED PRIOR TO THE PERFORMANCE OF ABATEMENT ACTIVITIES.
- 9. THE CONTRACTOR SHALL FILE THE PROJECT WITH NYC DEP VIA AN ACP-7 FORM. ADDITIONALLY, THE CONTRACTOR SHALL PETITION THE NYC DEP VIA AN ACP-9 VARIANCE FORM FOR THE 1-22(B) SECTION OF THE NYC DEP TITLE 15 REGULATIONS. THE CONTRACTOR'S NYS DOL ASBESTOS PROJECT DESIGNER SHALL PREPARE THE PHASING PLAN AND LETTER AS REQUIRED BY THE NYC DEP.

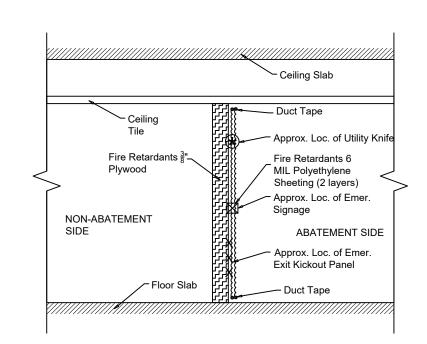


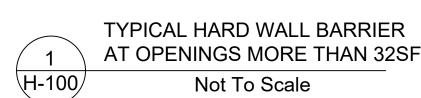

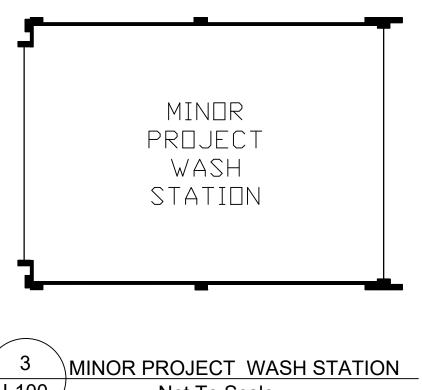

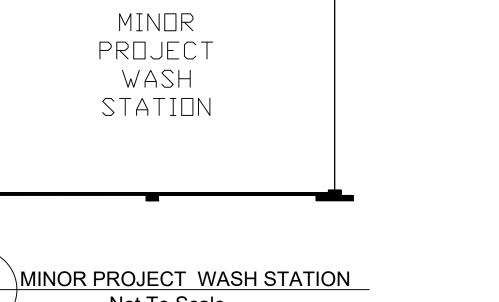

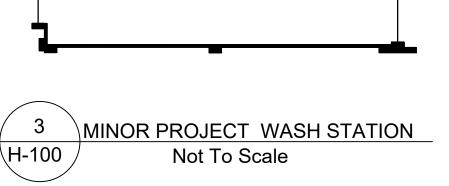

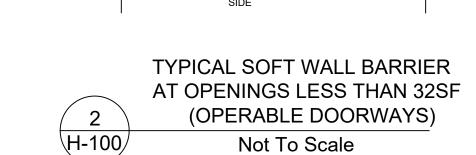


Knife to Facilitate

Emergency Exit


ABATEMENT SIDE


NON-ABATEMENT

Sheeting (2 layers

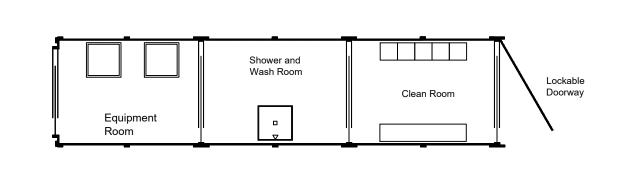




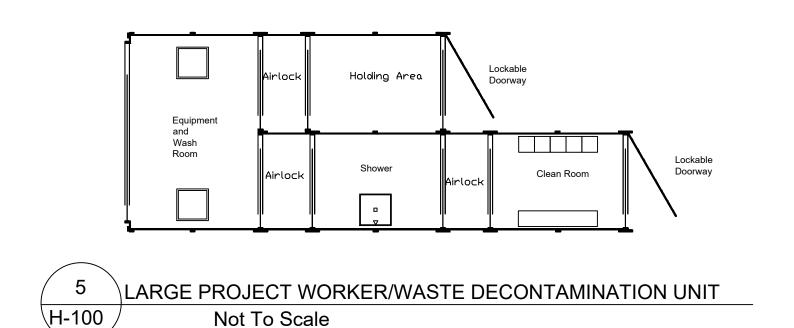


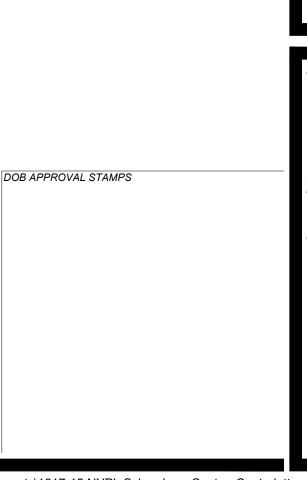



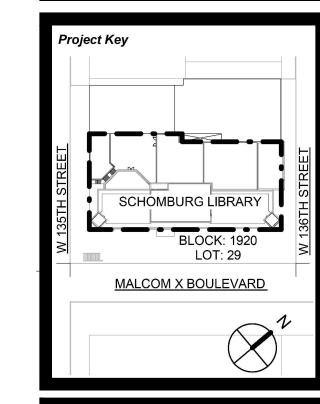

REVIS	SIONS	
Rev No	Description	Date:
1		
2		
3		
4		
<u>5</u>		
<u>6</u>		
$\overline{\triangle}$		
8		
<u> </u>		

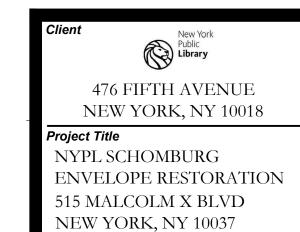



PHASE N/A - ACM SCOPE OF WORK TABLE

Floor/level /location	Work Area Designation	Description of Asbestos Materials	Removal Method(s)	Approximate Quantity (SF/Unit)	Approximate Quantity (LF/Unit)
Penthouse Roof	1	Base Flashing - All Layers (Including Bottom Layer, Top Layer, & Tar Sealant)	1-107	396.0 SF	-
		Mechanical Flashing	1-107	44.0 SF	-
Bulkhead Roof North	2	Base Flashing - All Layers (Including Bottom Layer, Top Layer, & Tar Sealant)	1-107	100.0 SF	-
		Scupper Flashing	1-107	1.0 SF	-
Bulkhead Roof South	3	Base Flashing - All Layers (Including Bottom Layer, Top Layer, & Tar Sealant)	1-107	100.0 SF	-
		Scupper Flashing	1-107	1.0 SF	-
Bulkhead Roof North, Interior	4	Interior Window Caulking	1-106	2.0 SF	-
Bulkhead Roof South, Interior	5	Interior Window Caulking	1-106	2.0 SF	-
Small Roof	6	Drain Flashing & Drain Flashing Tar Mastic	1-107	4.0 SF	-
4th Floor, Ceiling Plenum Below Penthouse Roof	7	Concealed Tar / Waterproofing to Drain Body	1-106	8.0 SF	-
	Total Qua	antity (SF / LF / Units)		658.0 SF	-

PHASE A - ACM SCOPE OF WORK TABLE

Floor/level /location	Work Area Designation	Description of Asbestos Materials	Removal Method(s)	Approximate Quantity (SF/Unit)	Approximate Quantity (LF/Unit)
Reading Room Roof -	8	Assumed ACM Concealed Caulking between Door Frame & Masonry Opening	1-109	1.5 SF	-
Bulkhead Door		Assumed ACM Metal Door Core Insulation	1-105	21.0 SF	-
	Total Qua		22.5 SF	-	

PHASE A - PCB SCOPE OF WORK TABLE

Floor/level /location	Work Area Designation	Description of Materials	Approximate Quantity (SF/Unit)	Approximate Quantity (LF/Unit)
Reading Room Roof - Bulkhead Door	8	Assumed PCB-Containing Concealed Caulking between Door Frame & Masonry Opening	1.5 SF	-
	Total Quantity (SF	1.5 SF	-	

PHASE C - ACM SCOPE OF WORK TABLE

Floor/level /location	Work Area Designation	Description of Asbestos Materials	Removal Method(s)	Approximate Quantity (SF/Unit)	Approximate Quantity (LF/Unit)
1st Floor, Vestibule - Exit Doors to Exterior	9	Assumed ACM Concealed Caulking between Door Frame & Masonry Opening	1-109	3.5 SF	-
4th Floor, Men's Bathroom	10	Glass Block Interior Caulking (Dark Brown)	1-106	6.0 SF	-
4th Floor, Women's Bathroom	11	Glass Block Interior Caulking (Dark Brown)	1-106	6.0 SF	-
Total Quantity (SF / LF / Units)				15.5 SF	<u>-</u>

PHASE C - PCB SCOPE OF WORK TABLE

Floor/level /location	Work Area Designation	Description of Materials	Approximate Quantity (SF/Unit)	Approximate Quantity (LF/Unit)
1st Floor, Vestibule - Exit Doors to Exterior	9	Assumed PCB-Containing Concealed Caulking between Door Frame & Masonry Opening	3.5 SF	-
	Total Quantity (SF	LF / Units)	3.5 SF	-

PHASE D - ACM SCOPE OF WORK TABLE

Floor/level /location	Work Area Designation	Description of Asbestos Materials	Removal Method(s)	Approximate Quantity (SF/Unit)	Approximate Quantity (LF/Unit)
Cellar, Reading Room - Exit Doors	12	Assumed ACM Concealed Caulking between Door Frame & Masonry Opening	1-109	2.0 SF	-
Cellar, Theater Corridor - Exit Doors	13	Assumed ACM Concealed Caulking between Door Frame & Masonry Opening	1-109	3.0 SF	-
Total Quantity (SF / LF / Units)				5.0 SF	-

PHASE D - PCB SCOPE OF WORK TABLE

Floor/level /location	Work Area Designation	Description of Materials	Approximate Quantity (SF/Unit)	Approximate Quantity (LF/Unit)
Cellar, Reading Room - Exit Doors	12	Assumed PCB-Containing Concealed Caulking between Door Frame & Masonry Opening	2.0 SF	-
Cellar, Theater Corridor - Exit Doors	13	Assumed PCB-Containing Concealed Caulking between Door Frame & Masonry Opening	3.0 SF	-
	Total Quantity (SF /	LF / Units)	5.0 SF	-

515 Broadway, Albany, New York, 12207-2964
One Penn Plaza, 52 Floor, NY, NY 10119-0098
539 Franklin Street, Buffalo, NY 14202-1109
WWW.DASNY.ORG

THESE DOCUMENTS CONTAIN POTENTIALLY SENSITIVE INFORMATION AND SHALL BE
USED FOR THEIR INTENDED PURPOSE. ONCE THE INTENDED PURPOSE HAS CEASED,
THE DOCUMENTS SHALL BE DESTROYED IN A SECURE MANNER.

IT IS A VIOLATION OF STATE EDUCATION LAW FOR ANY PERSON, UNLESS UNDER THE
DIRECTION OF A LICENSED ARCHITECT / ENGINEER TO ALTER THIS DOCUMENT IN
ANY WAY. ALTERATIONS MUST HAVE THE SEAL AFFIXED ALONG WITH A DESCRIPTION
OF THE ALTERATIONS, DATE AND ARCHITECTS / ENGINEER'S SIGNATURE. COPYRIGHT

© 2015.


Consultants

CURTIS + GINSBERG
ARCHITECTS
ONE BATTERY PARK PLAZA,
FL 27
Architects
NEW YORK, NEW YORK 10004
212.929.4417

Merritt Engineering
28-08 Bayside Lane, Queens, NY 11358
(718) 767-0923


The LiRo Group
235 East Jericho Turnpike, Mineola, NY 11501
516.746.2350


DOB JOB #: M01133253-I1

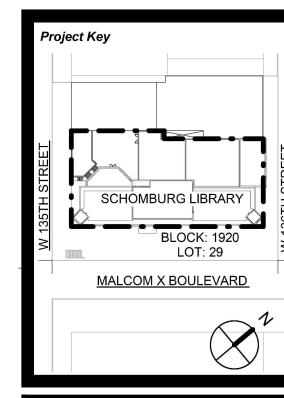


REVIS Rev No	Description	Date:
VEN MO	Description	Date.
<u>1</u>		
2		
3		
4		
<u></u> 5		
<u>6</u>		
<u> </u>		
8		
9\		




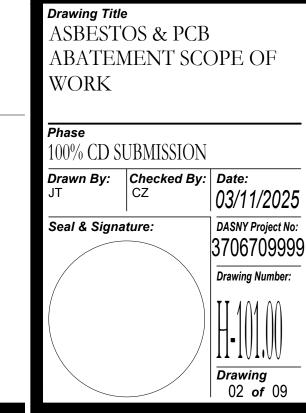


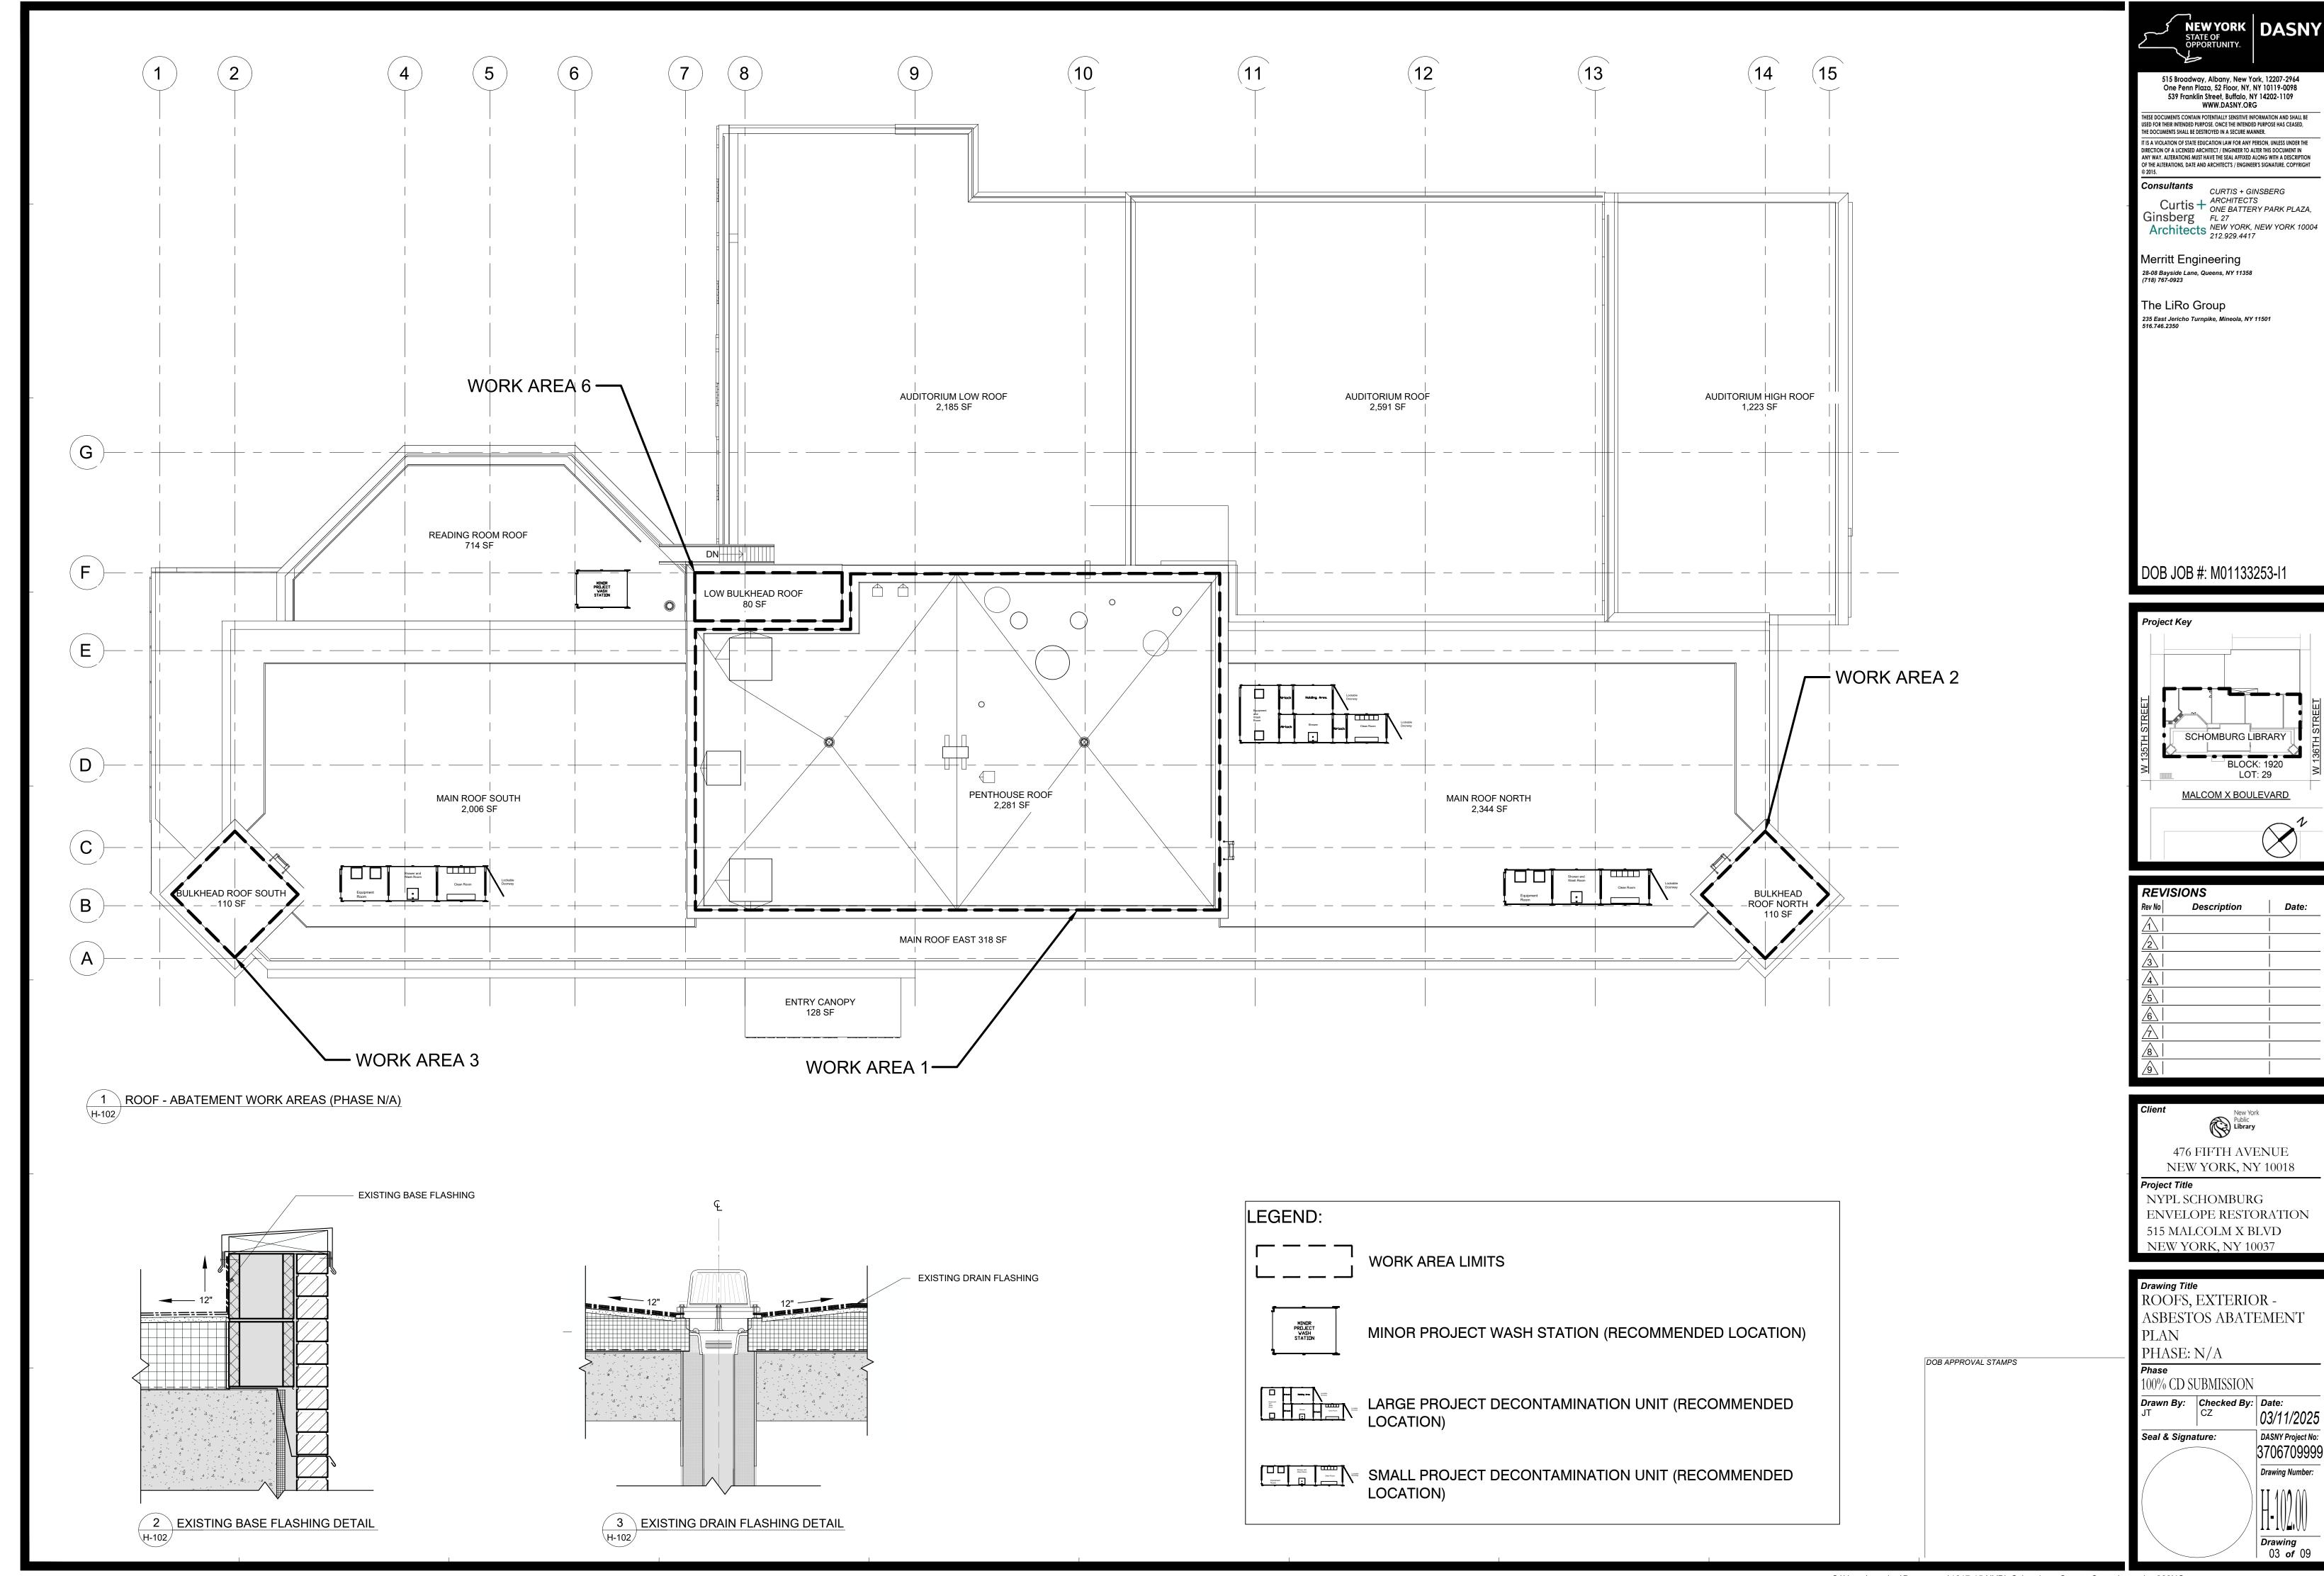

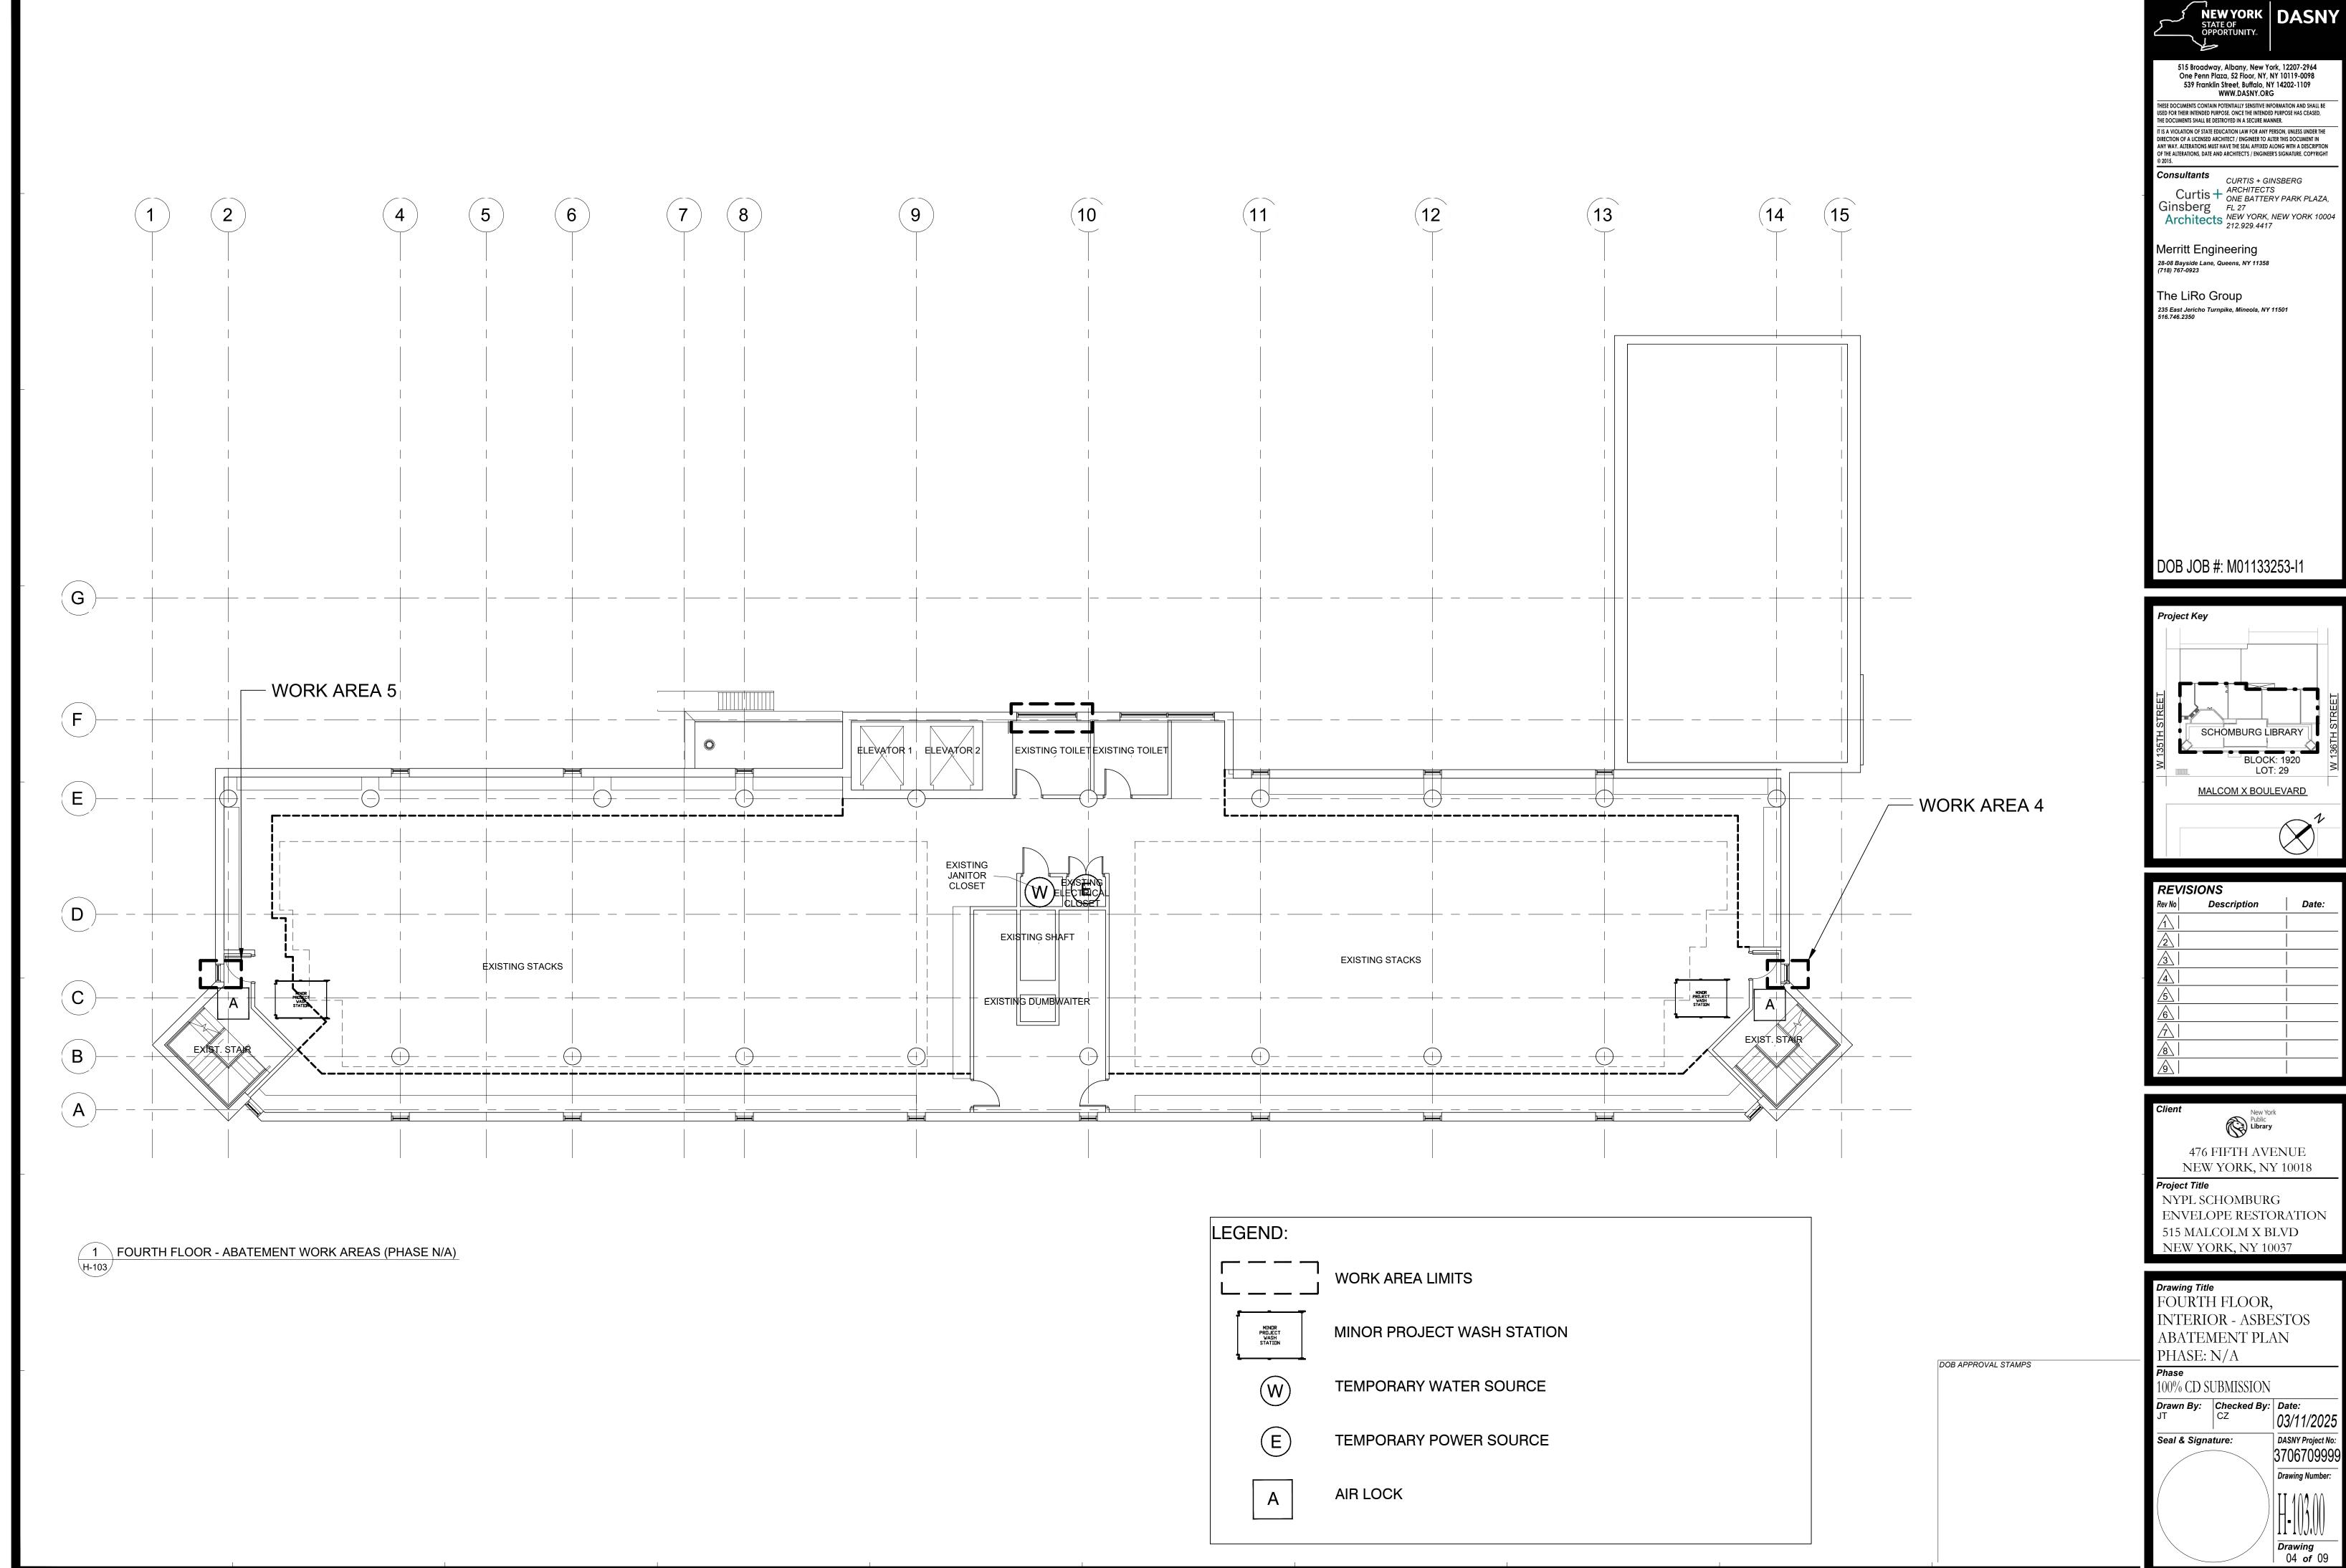


C:\Users\ttuscher\Documents\1617-15 NYPL Schomburg Center_Central_ttuscher868NQ.rvt

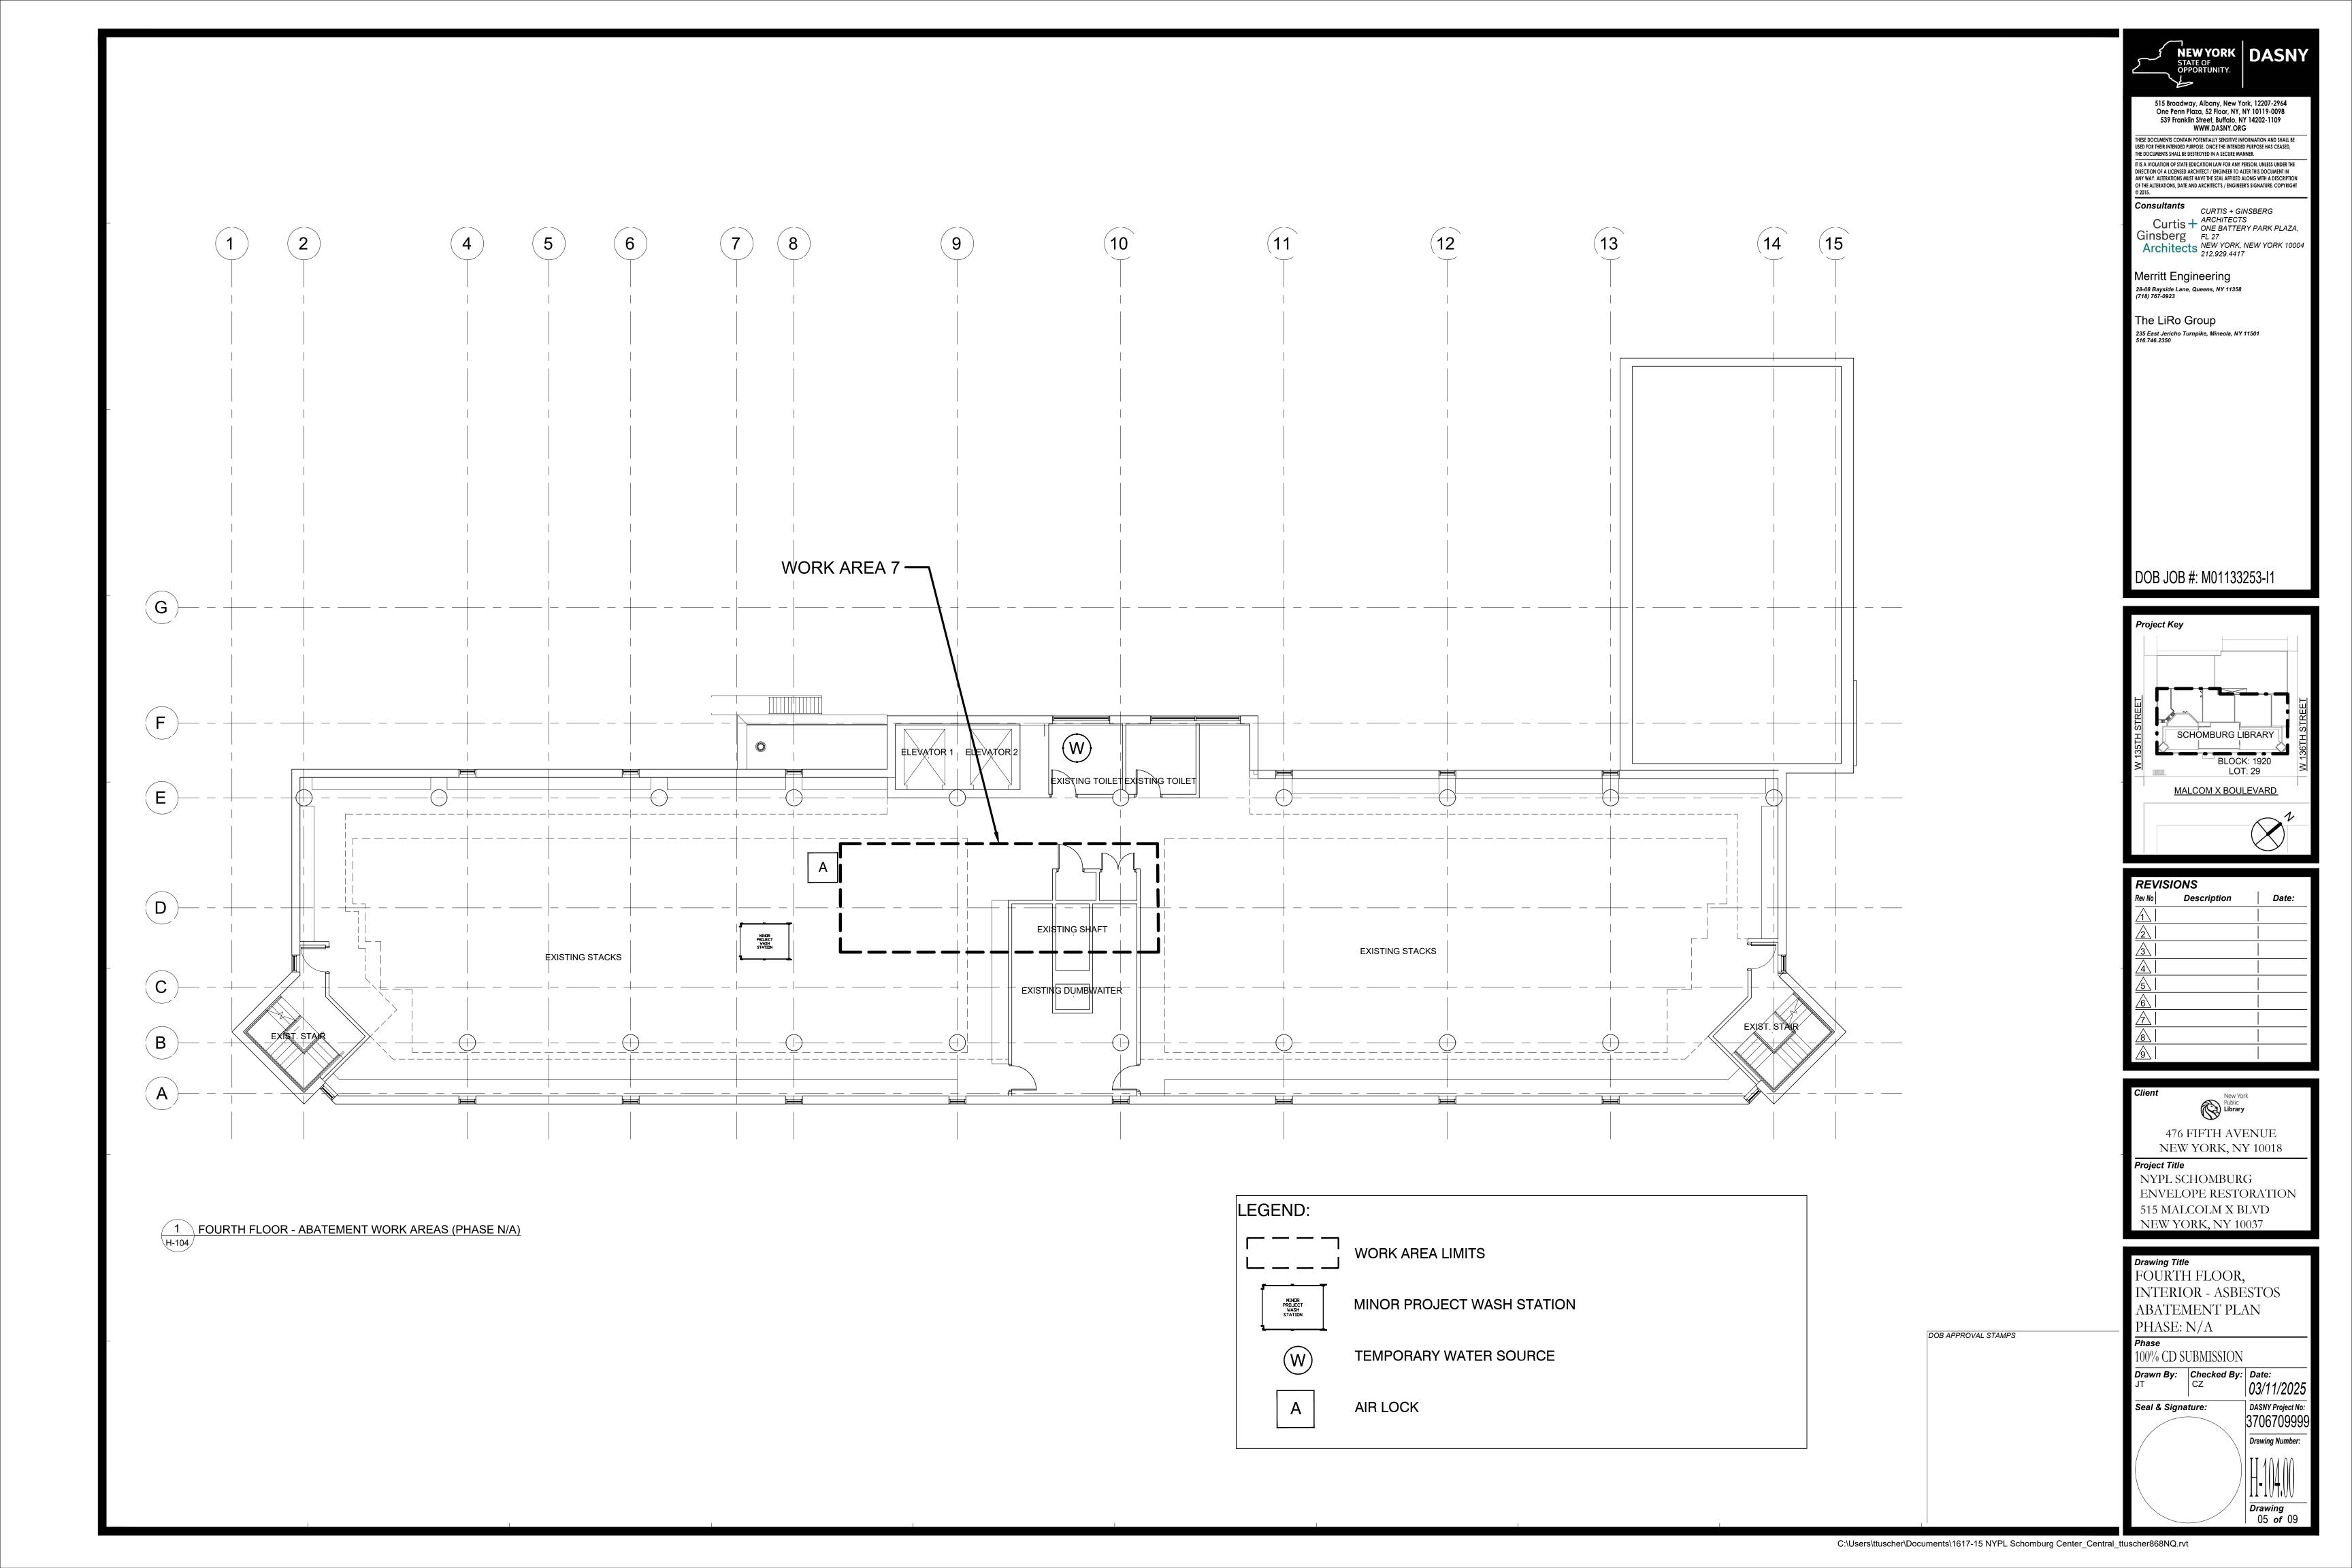


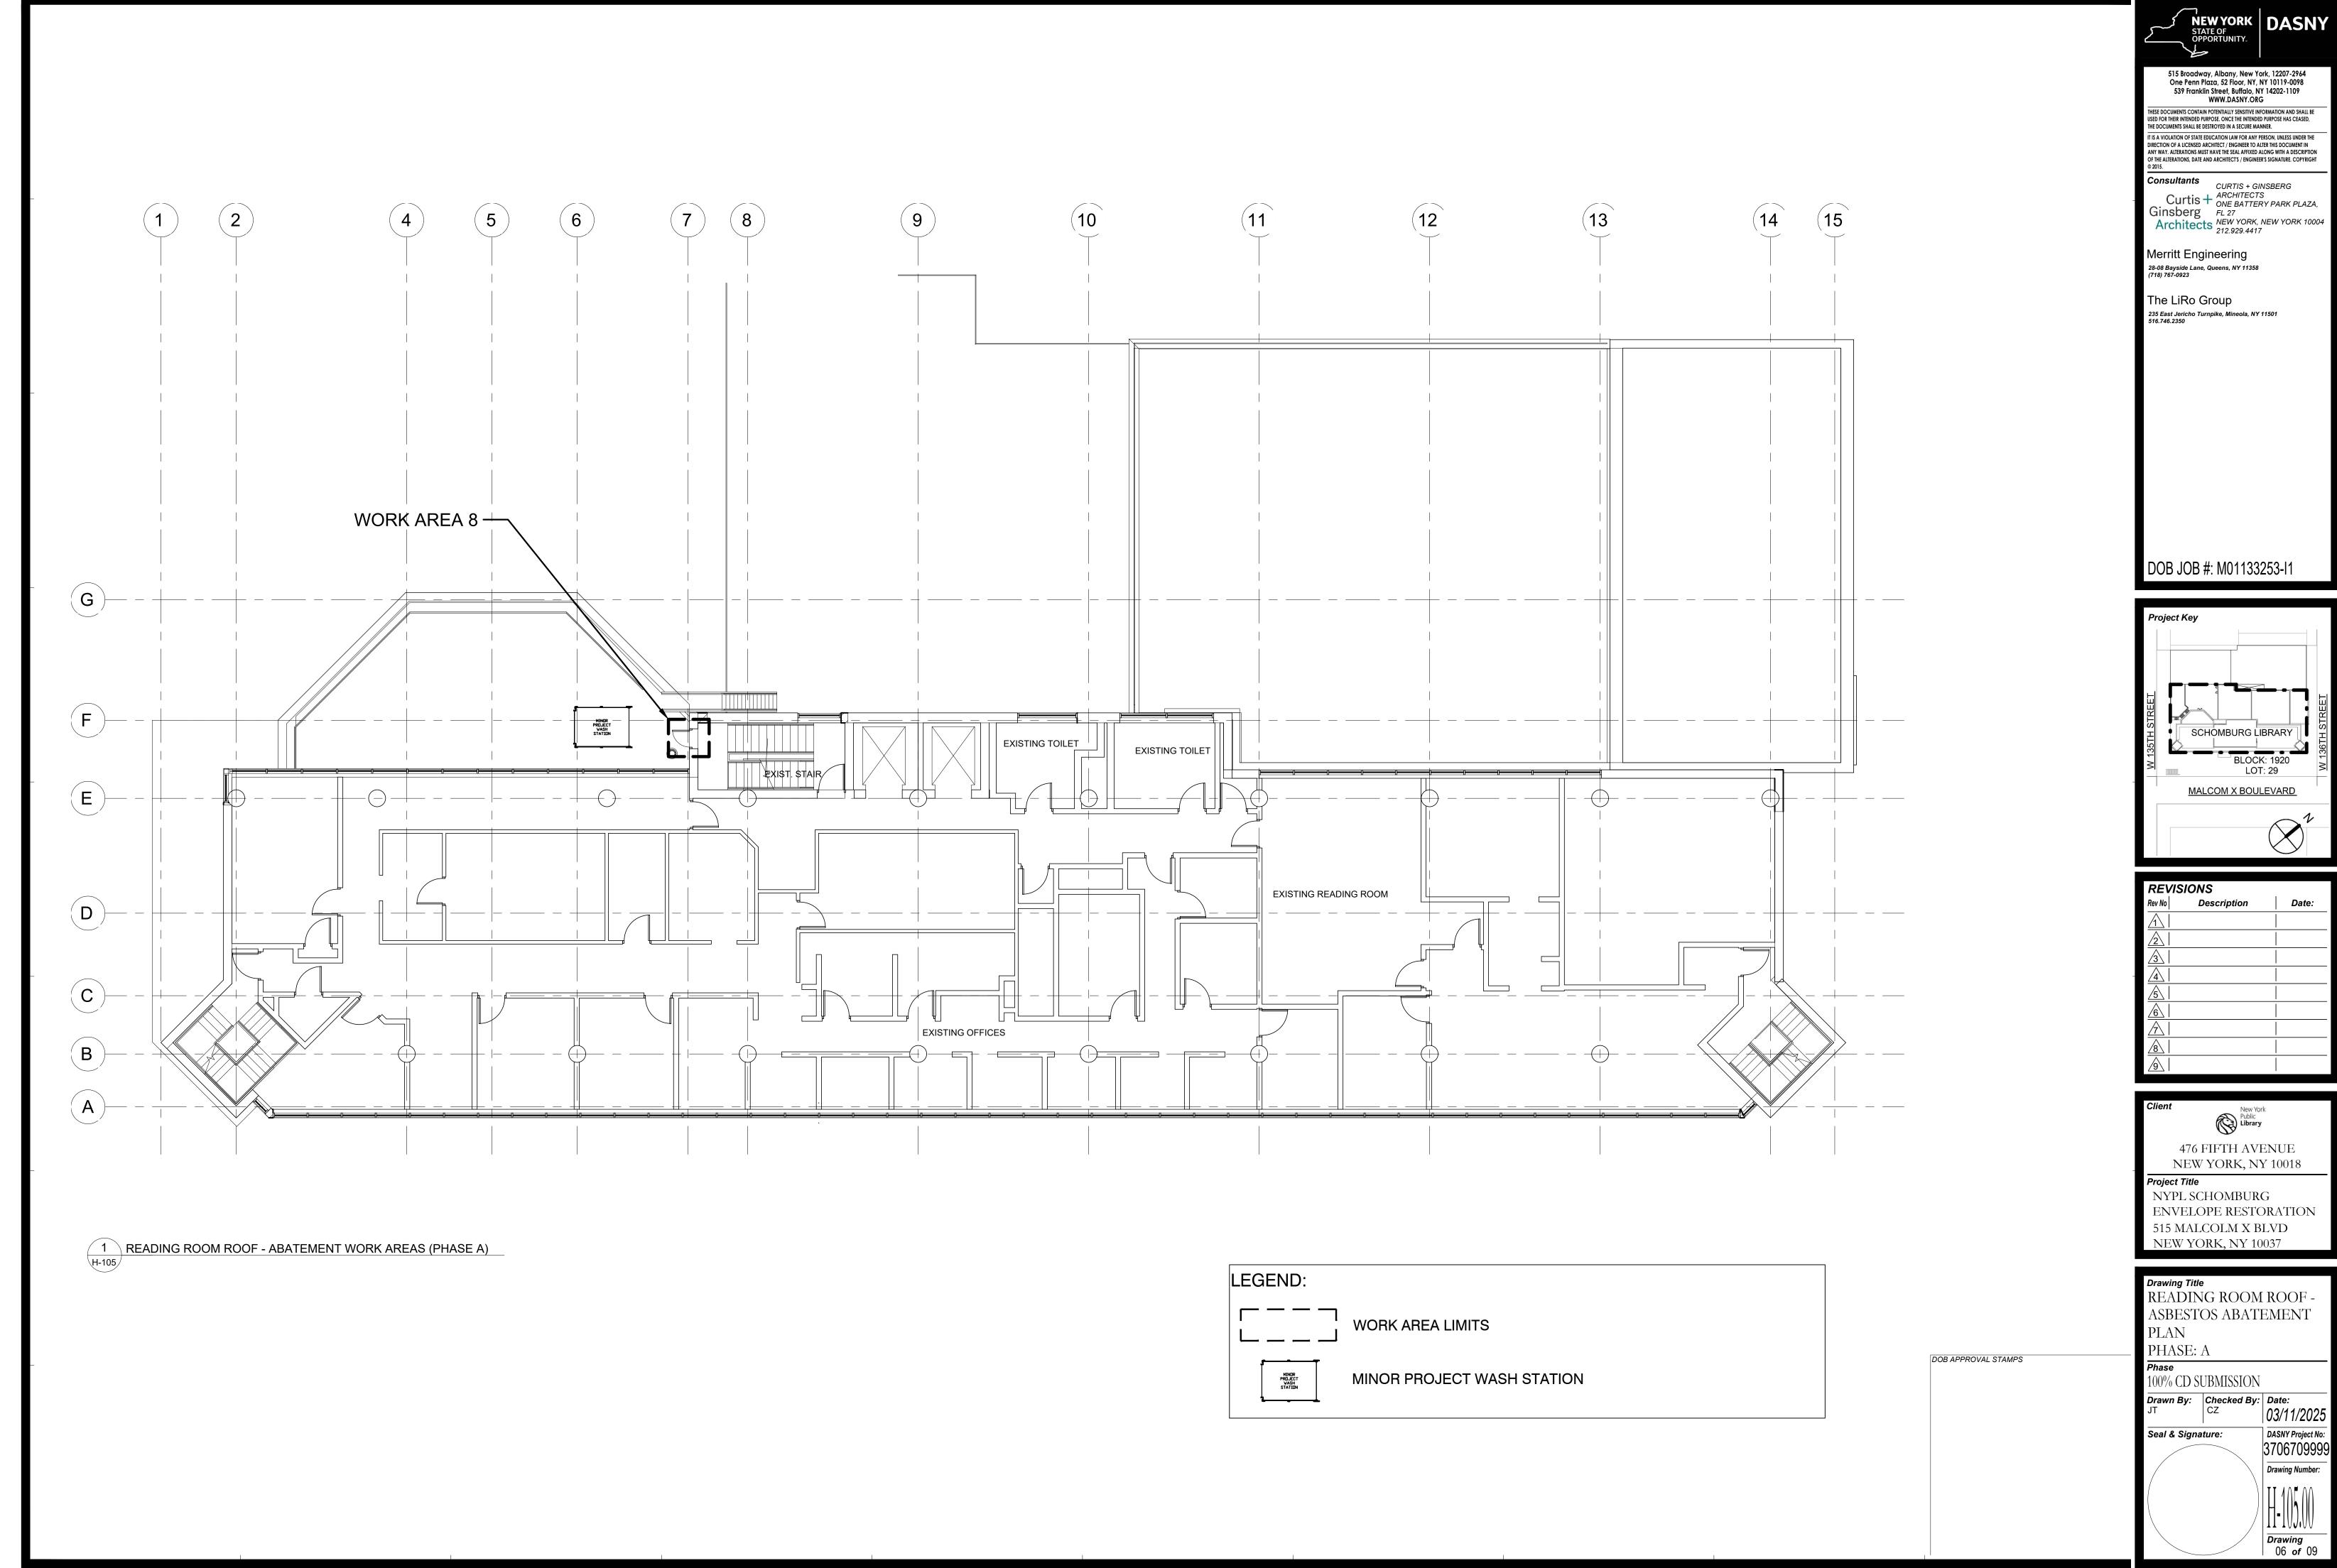


C:\Users\ttuscher\Documents\1617-15 NYPL Schomburg Center_Central_ttuscher868NQ.rvt

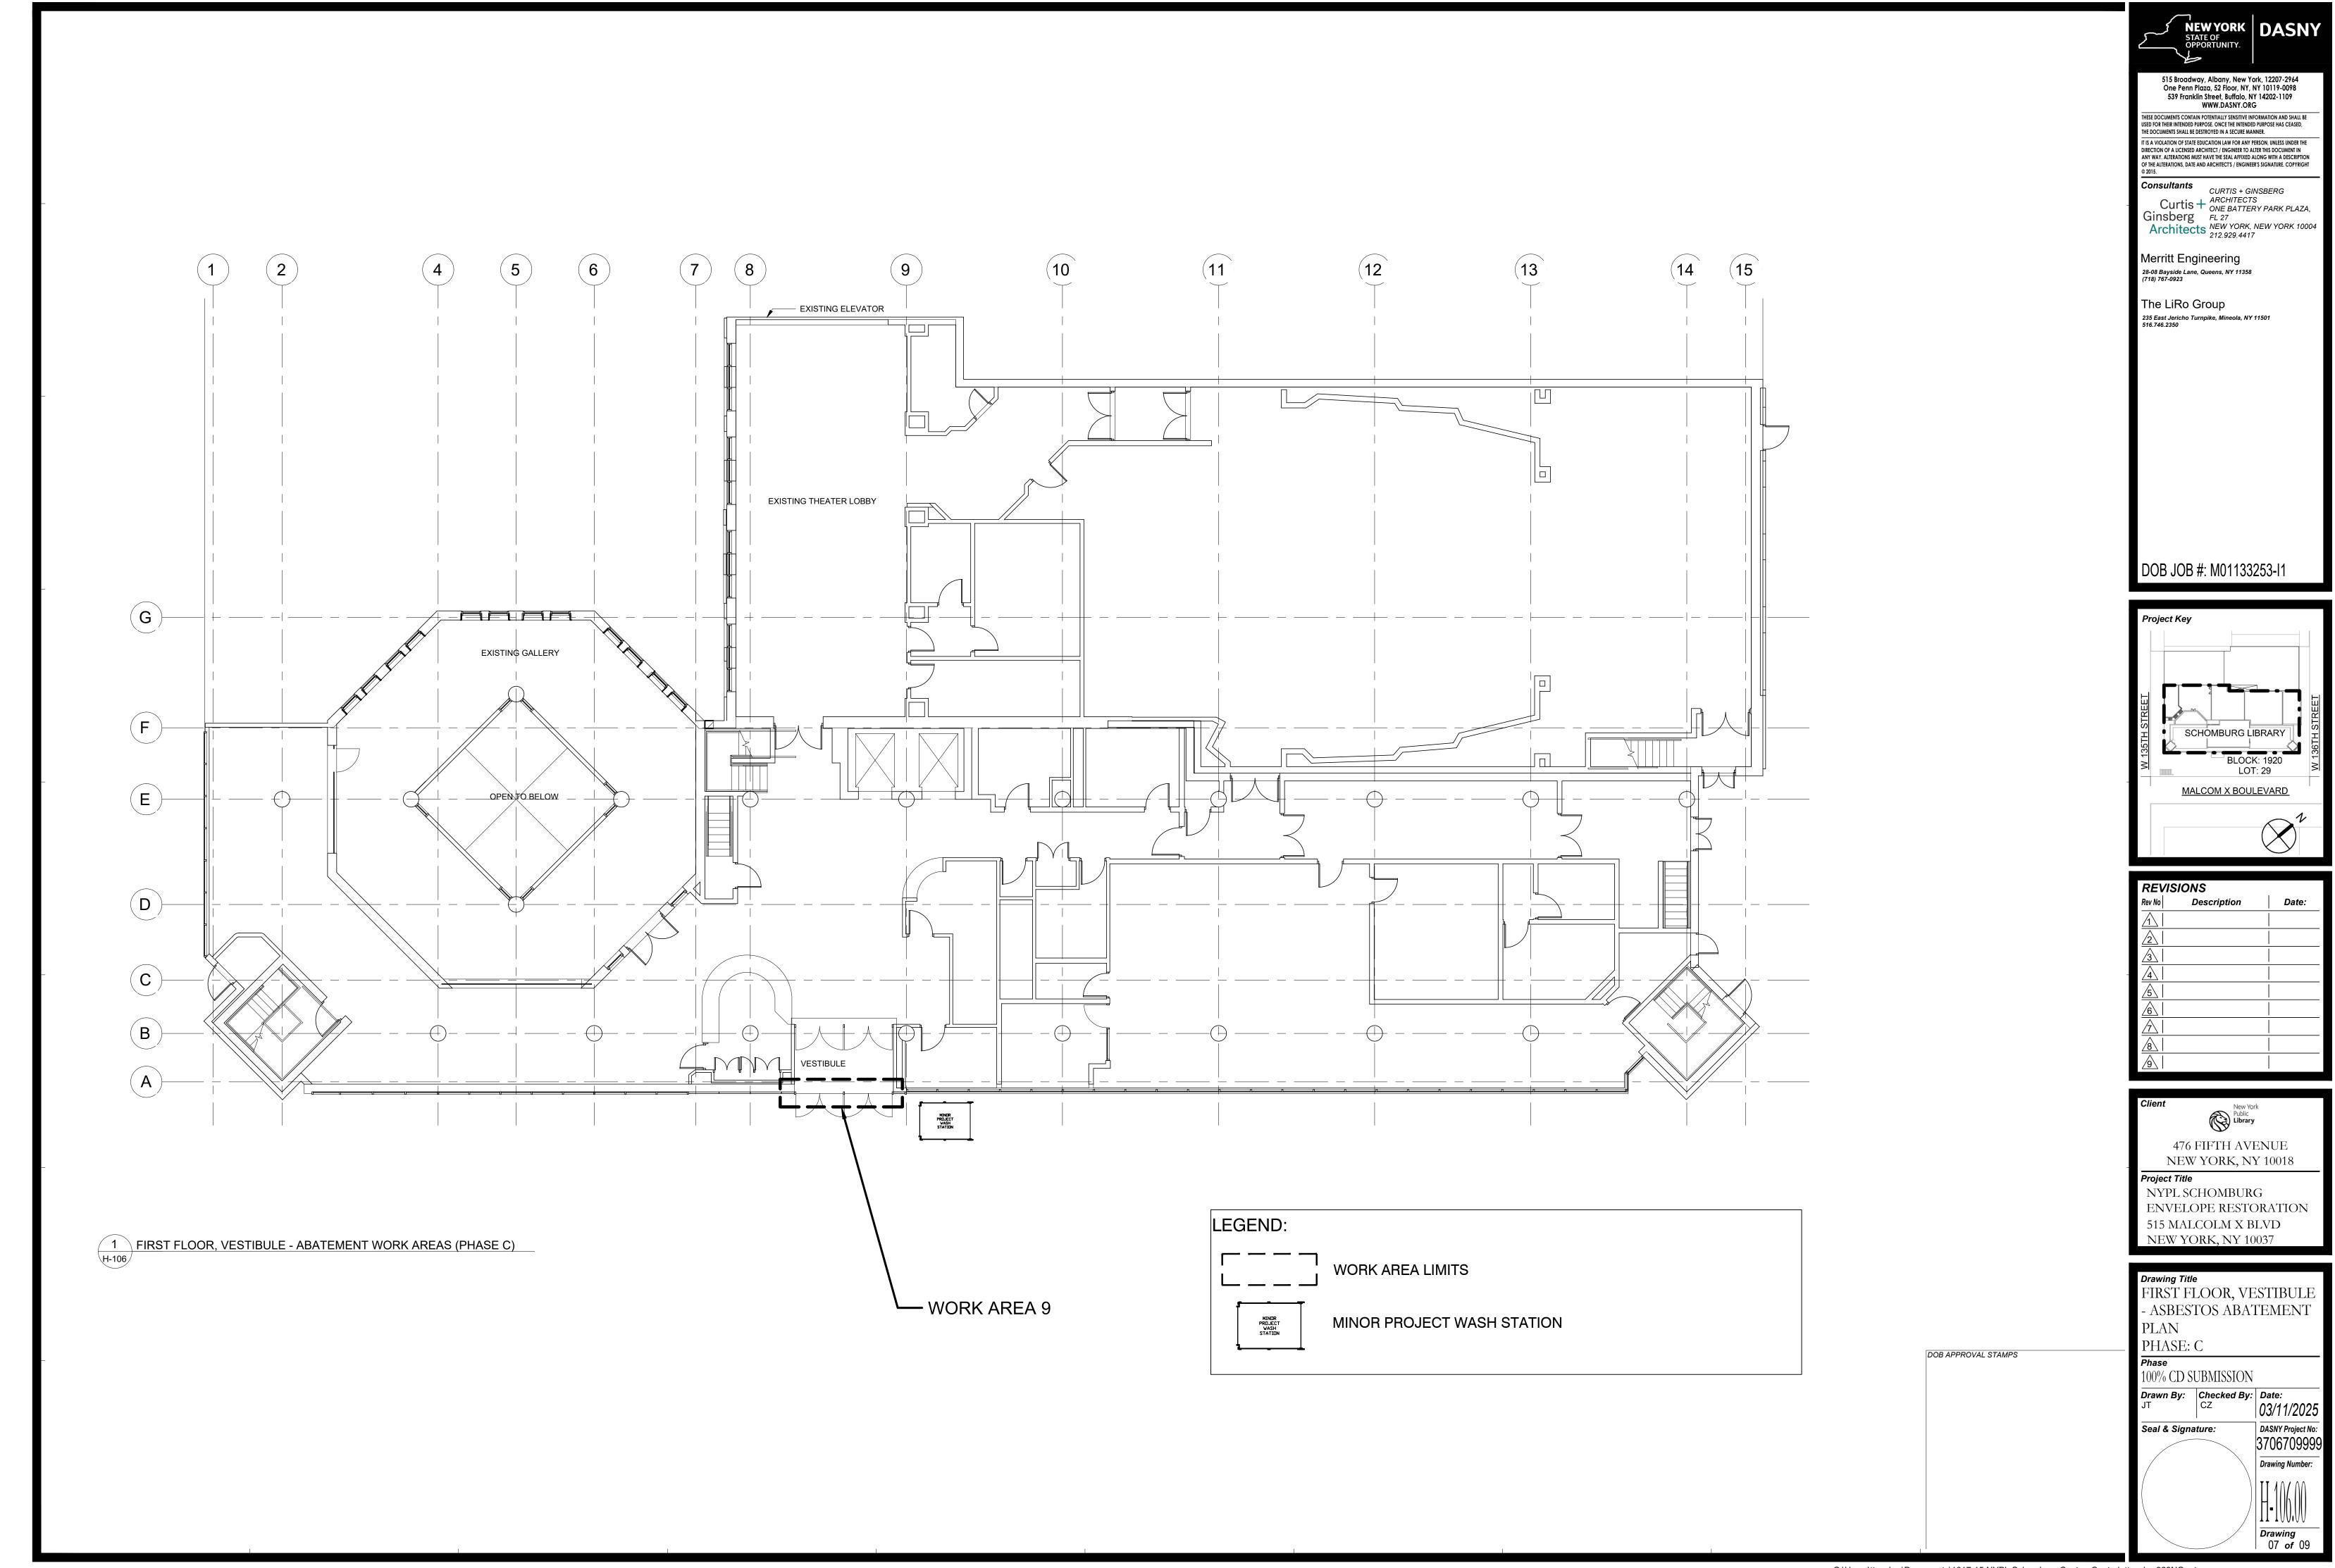

C:\Users\ttuscher\Documents\1617-15 NYPL Schomburg Center_Central_ttuscher868NQ.rvt

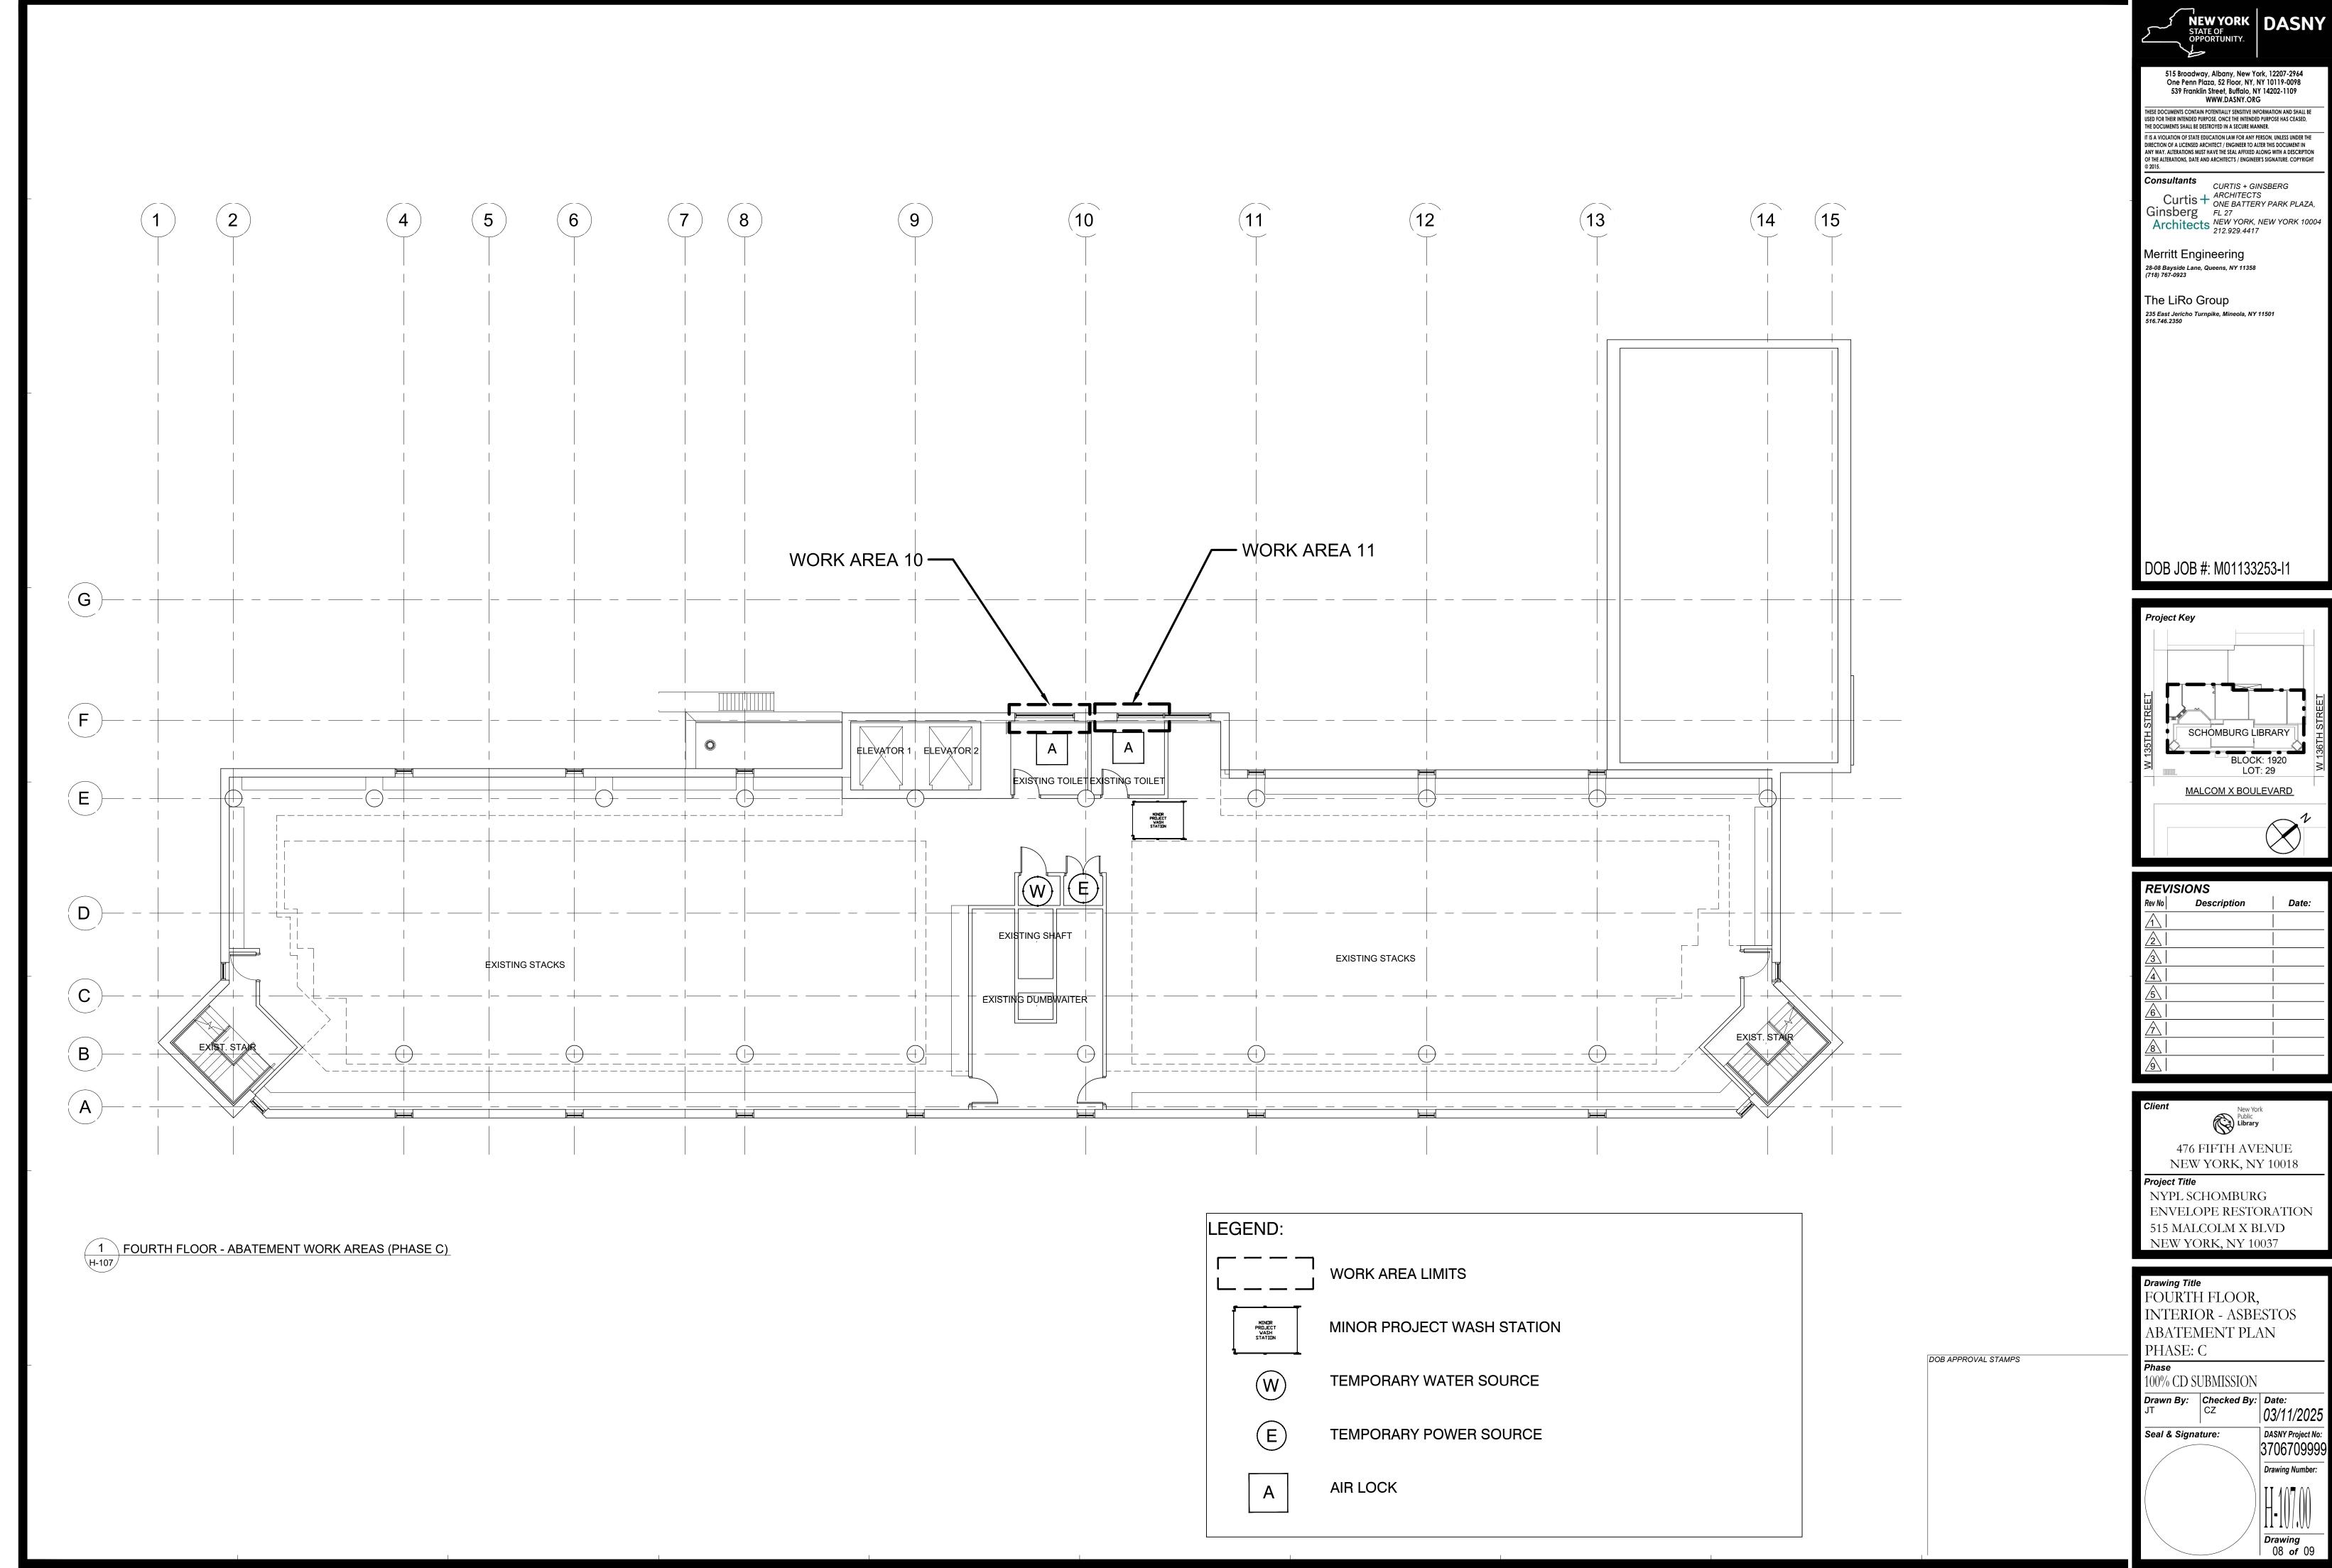

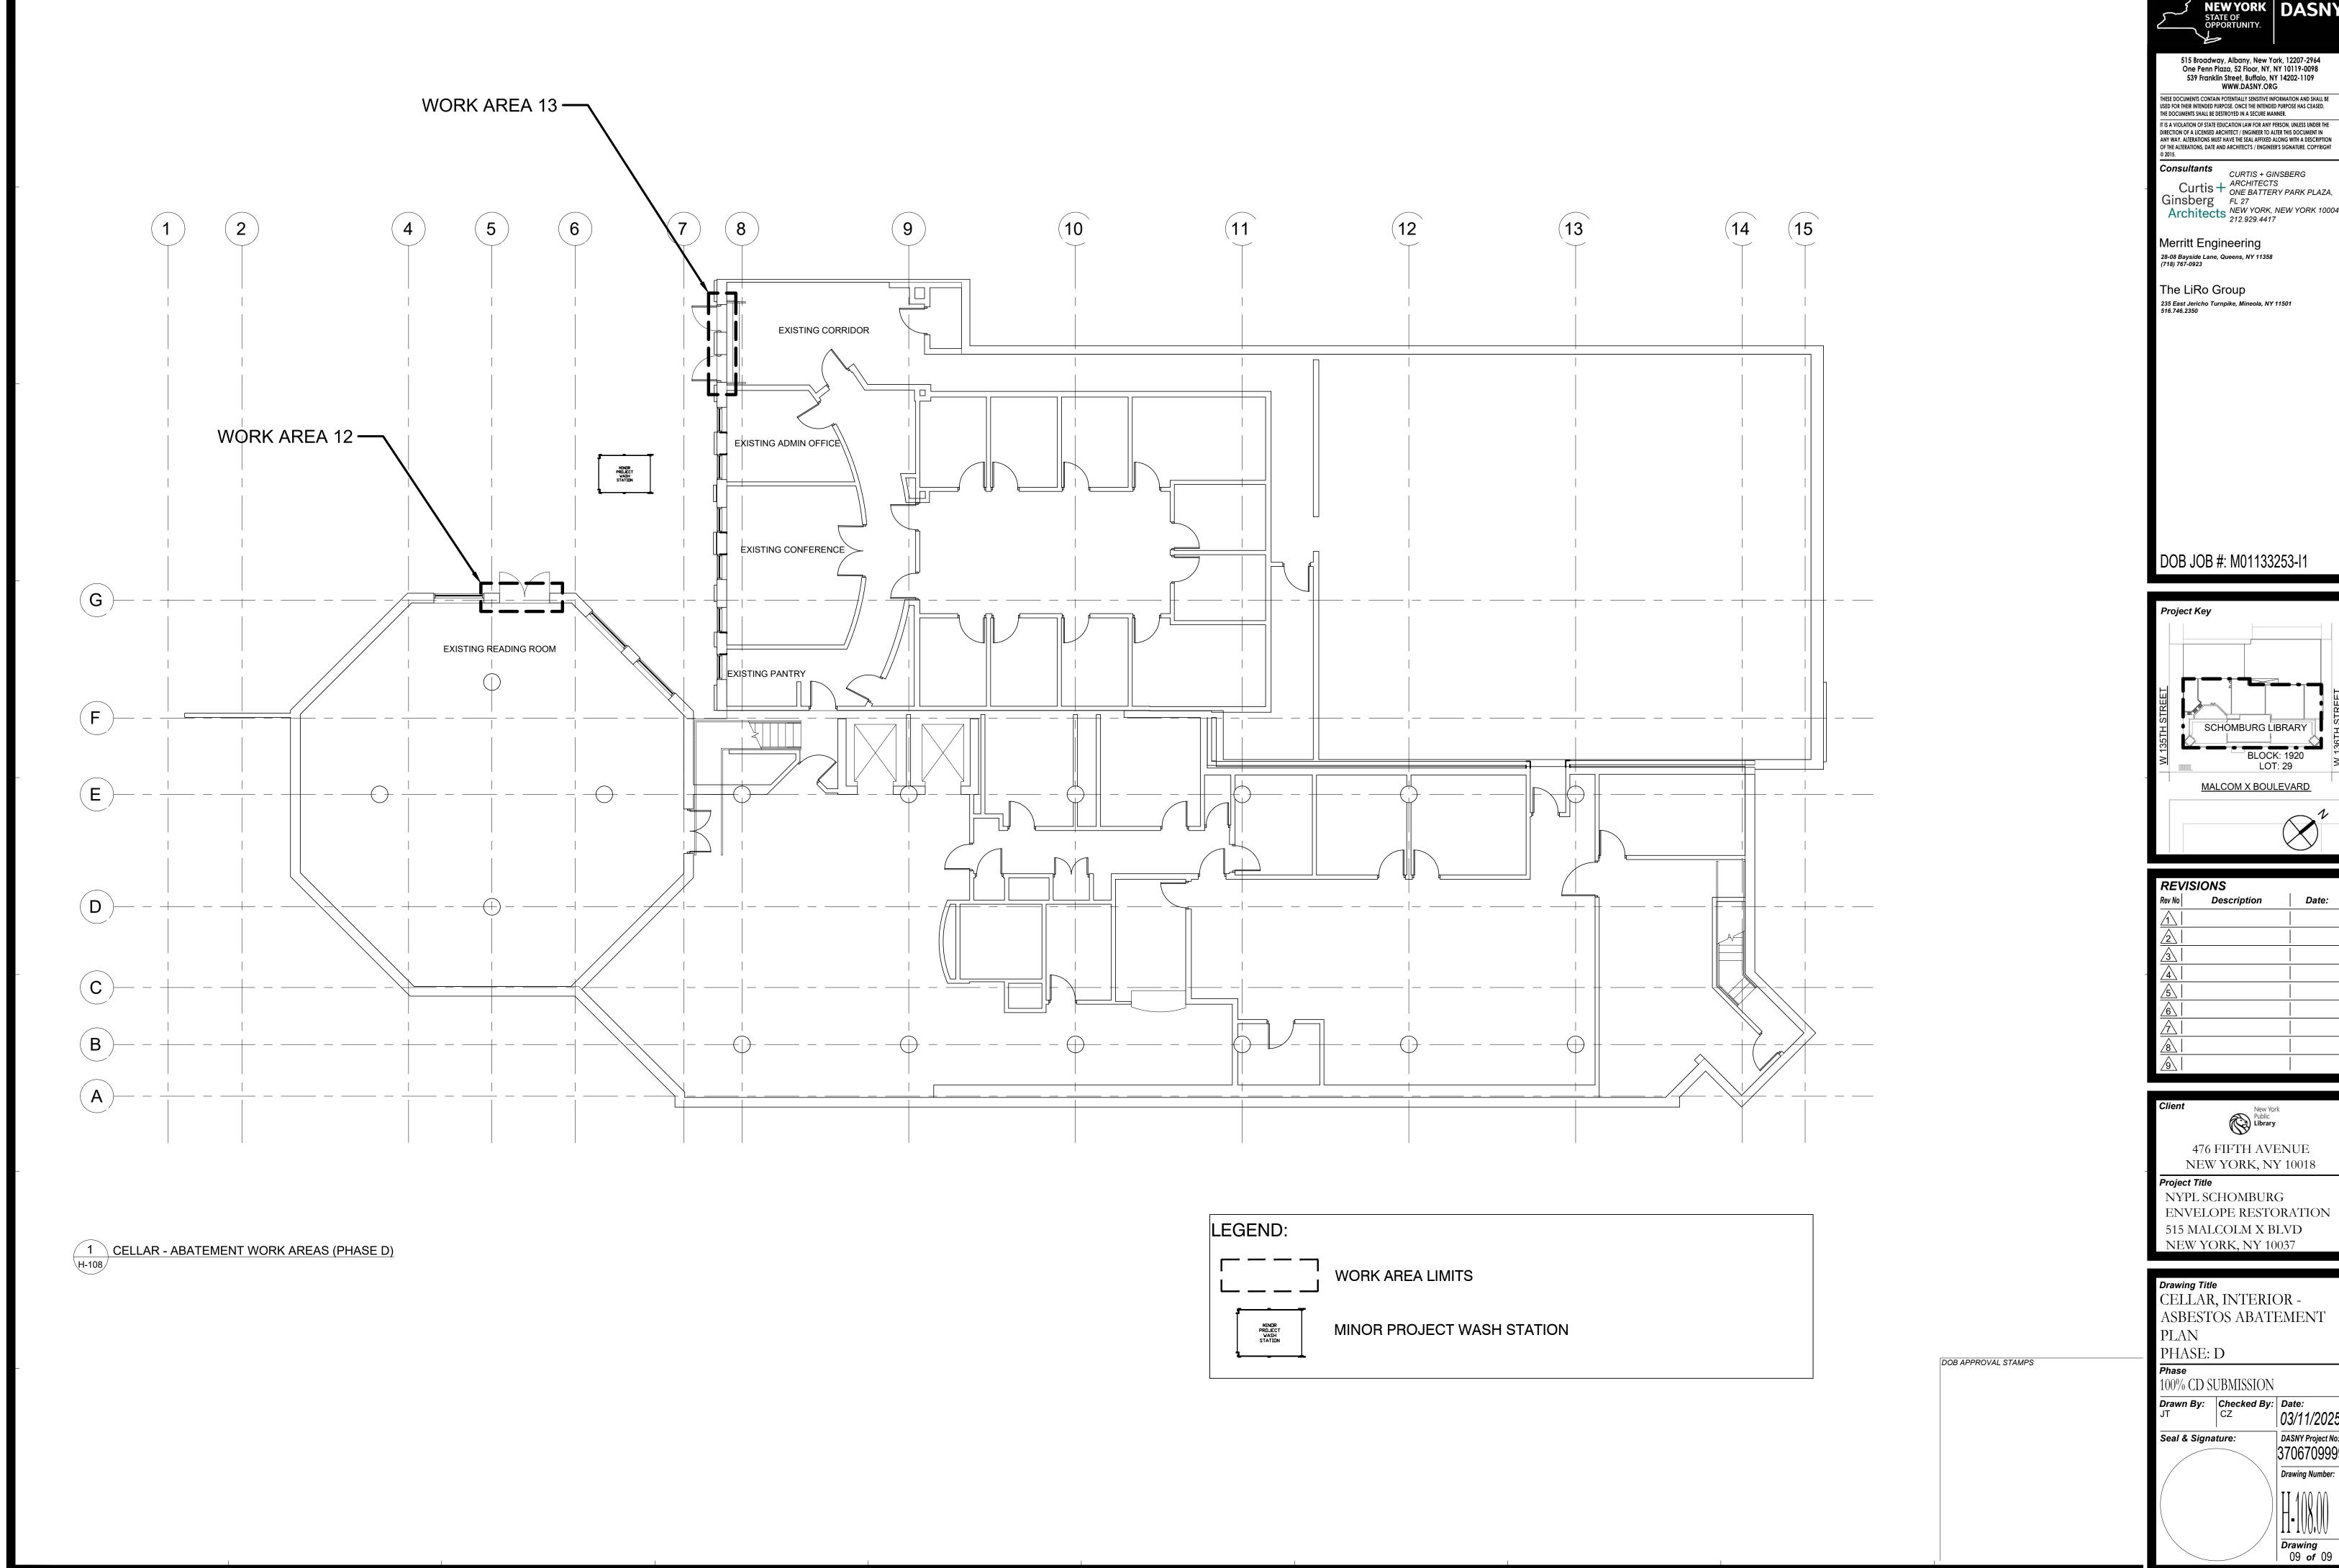


NEW YORK STATE OF OPPORTUNITY. THESE DOCUMENTS CONTAIN POTENTIALLY SENSITIVE INFORMATION AND SHALL BE USED FOR THEIR INTENDED PURPOSE. ONCE THE INTENDED PURPOSE HAS CEASED, THE DOCUMENTS SHALL BE DESTROYED IN A SECURE MANNER. T IS A VIOLATION OF STATE EDUCATION LAW FOR ANY PERSON, UNLESS UNDER THE DIRECTION OF A LICENSED ARCHITECT / ENGINEER TO ALTER THIS DOCUMENT IN ANY WAY. ALTERATIONS MUST HAVE THE SEAL AFFIXED ALONG WITH A DESCRIPTION OF THE ALTERATIONS, DATE AND ARCHITECT'S / ENGINEER'S SIGNATURE. COPYRIGHT Curtis + GINSBERG

Curtis + ARCHITECTS
ONE BATTERY PARK PLAZA,
FL 27

FL 27

NEW YORK NEW YORK 10004 Architects NEW YORK, NEW YORK 10004 212.929.4417

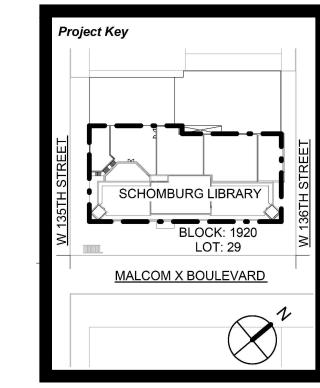

REVIS		1
Rev No	Description	Date:
1		
<u>2</u>		
<u>3</u>		
4		
<u>5</u>		
<u>6</u>		
<u> </u>		
8		
9\		

