



Re BID NO.: 641 PROJECT NAME & LOCATION Advanced Science Research Center
85 St. Nicholas Terrace
New York, NY 10027

Description: **Furnish, Deliver and Install Laser Curtains**

Bid Open Location: DASNY
515 Broadway
Albany, New York

Bid Open Date: October 10, 2019

Bid Open Time: 2:30PM

Contact: Theresa Graffeo at (518) 257-3583

NOTICE TO BIDDERS

MAIL BIDS EARLY

Sealed bids will be received by DASNY at the above address for the items listed in the attached Bid Breakdown and Schedule. When submitting your bid you must:

1. Prepare your bid on the attached Bid Breakdown and Schedule. Return one signed original of the Bid Breakdown and Schedule
2. If your bid deviates from Specifications, explain such deviations or qualifications on your letterhead, setting forth therein such explanations, and attach them to the Bid Breakdown and Schedule.
3. Submission of a bid constitutes full knowledge and acceptance of all provisions of the Notice to Bidders, all information referenced in the Purchasing General Conditions, Supplemental and Detailed Specifications, the Bid Submission and any Supplemental General Requirements contained herein, as well as any addenda issued in relation to the Invitation for Bids.
4. Each bid shall bear on the outside of the envelope the name of the bidder, address, telephone number and designated as a bid for the following:
DASNY Re Bid No. 641
Bid Opening Date: 10/10/2019 @ 2:30PM
Return to:
DASNY
Attn: Purchasing Unit
515 Broadway
Albany, NY 12207-2964



Re Bid No.: 641

When a sealed bid is placed inside another delivery jacket, the bid delivery jacket must be clearly marked on the outside “**BID ENCLOSED**” and “**ATTENTION: PURCHASING UNIT**”. The Dormitory Authority will not be responsible for receipt of bids which do not comply with these instructions.

5. Mail bid responses early in order for them to be received before the time of the bid opening. **Late bids will be automatically rejected.** Individuals submitting bids in person or by private delivery services should allow sufficient time for processing through building security to assure that the bids are received prior to the deadline for submitting bids. All individuals who plan to attend bid openings will be required to present government-issued picture identification to building security officials and obtain a visitor’s pass prior to attending the bid opening.

6. In accordance with State Finance Law § 139-j and 139-k, this solicitation includes and imposes certain restrictions on communications between Dormitory Authority personnel and an Offerer during this procurement process. Designated contact for this solicitation is:
Theresa Graffeo, Purchasing Coordinator , at Dormitory Authority – State of New York, 515 Broadway, Albany, NY 12207,(518) 257-3085. Contacts made to other Dormitory Authority Personnel regarding this procurement may disqualify the Offerer and affect future procurements with governmental entities in the State of New York. Please refer to the Authority’s website www.dasny.org for Authority policy and procedures regarding this law, or the NYS office of General Services website www.ogs.ny.gov/BU/PC/ for more information about this law.



Bid No.: Re Bid 641

If you are not submitting a bid it is requested that you complete and return the lower portion of this form

(Please check all that apply and provide comments in the space provided, if necessary)

- We are not Submitting a bid.
- We Request removal of our name from the mailing list.
- Location of the job site.
- Commodity is not carried by our company.
- Scope is too large.

Other/Additional Explanation: _____

NAME OF BIDDER: _____

ADDRESS : _____

Street Telephone	City	State	Zip
------------------	------	-------	-----

Signature of Bidder

Official Title

CLAUSES PURSUANT TO THE OMNIBUS PROCUREMENT ACT OF 1992

It is the policy of New York State to maximize opportunities for the participation of New York State business enterprises, including minority and woman-owned business enterprises as bidders, subcontractors and suppliers on its procurement contracts.

Information on the availability of New York subcontractors and supplies is available from:

Empire State Development
Small Business Division
30 South Pearl Street, 7th Floor
Albany, NY 12207
Phone: (800) 782-8369

A directory of minority and woman-owned business enterprises is available from:

Empire State Development
Division of Minority and Women Business Development
30 South Pearl Street
Albany, NY 12207
Phone: (518) 292-5250

Online Directory: <https://ny.newnycontracts.com/FrontEnd/VendorSearchPublic.asp>

[DASNY maintains a directory of minority and women-owned business enterprises:
http://www.dasny.org/construc/mwsberreg/index.php](http://www.dasny.org/construc/mwsberreg/index.php)

The contractor acknowledges notice that New York State may seek to obtain offset credits from foreign countries as a result of this contract and agrees to cooperate with the State in these efforts.

DASNY encourages the use of recycled Materials in the manufacturing process. To that end, the recycled product must meet the same codes, specifications and standards the non-recycled materials do, including requirements for cost, installation, aesthetics, availability and maintenance.

The Omnibus Procurement Act of 1992 and § 2879 of the NYS Public Authorities Law require that by signing this bid, contractors certify that whenever the total bid amount is greater than \$1 million:

1. The contractor has made reasonable efforts to encourage the participation of New York State Business Enterprises as suppliers and Subcontractors on this project, and has retained the documentation of these efforts to be provided upon request to the State. If the contractor determines that NYS business enterprises are not available to participate on the contract as subcontractors or suppliers, the contractor shall provide a statement indicating the method by which such determination was made. If the contractor does not intend to use subcontractors, contractor shall provide a statement verifying such;
2. The contractor has complied with the Federal Equal Opportunity Act of 1972 (PL 92-261), as amended;
3. The contractor agrees to make reasonable efforts to provide notification to New York State residents of employment opportunities on this project through listing any such positions with the Job Service Division of the New York State Department of Labor, or providing such notification in such manner as is consistent with existing collective bargaining contracts or agreements. The contractor agrees to document these efforts and to provide said documentation to the State upon request;

DASNY is required by law to notify the NYS Department of Economic Development of any procurement contract for one million dollars or more that is to be awarded to an out-of-state vendor. This notice must be done simultaneous to the notification of award provided to the vendor. A purchase order or contract cannot be issued until fifteen (15) days after such notification is provided.



DASNY

GENERAL SPECIFICATIONS

- (1) The enclosed Purchasing General Conditions are hereby incorporated by reference. Submission of a bid response shall constitute acceptance of such conditions. Any exceptions/clarifications/qualifications to these conditions or other specifications and/or requirements contained herein must be clearly stated in the bid response and, depending upon the nature of such, may be grounds for rejection of your bid.
- (2) Bids must be submitted in the bidder's full legal name, or the bidder's full legal name plus a registered assumed name, if any.
- (3) All NYS bidders are required to be registered to do business with the NYS Department of State or their local County Clerk, whichever is applicable.
- (4) All out-of-state bidders will be required to provide proof of registration to do business in their state. All out-of-state bidders that "do business in New York State" **MUST BE REGISTERED WITH THE NYS DEPARTMENT OF STATE**. Please contact the NYS Department of State at (518) 473-2492. Information is available at the DOS website: www.dos.ny.gov
- (5) DASNY is required by law to notify the Empire State Development of any procurement contract for one million dollars or more that is to be awarded to an out-of-state vendor. This notice must be done simultaneous to the notification of award provided to the vendor. A purchase order or contract cannot be issued until fifteen (15) days after such notification is provided.
- (6) Empire State Development is required by law to identify states and other jurisdictions that impose preferences or other penalties against New York bidders. DASNY is precluded from soliciting bids or entering into procurement contracts with companies that have their principal place of business located in one of the listed jurisdictions, unless the procurement is for a product that is substantially manufactured in New York State or the services are to be performed in New York State. Currently, this list of jurisdictions includes the states of Alaska, Hawaii, Louisiana, South Carolina, West Virginia and Wyoming.
- (7) Unless otherwise indicated, any reference to brands or model numbers is intended to establish a standard. Items of all manufacturers will be considered, provided the item is determined to meet or exceed the required specification. DASNY's decision as to whether a substitute item meets specification will be final. Your attention is directed to Article II-7, Page 5 of the General Conditions. In order to evaluate substitute items, detailed specifications must be submitted for any product that is other than the one(s) specified in the bid.



DASNY

GENERAL SPECIFICATIONS CONTINUED

- (8) Unless otherwise noted, guarantee on all items is to be one year as detailed in Article XVI of the General Conditions
- (9) All upholstered furniture and drapery panels and lining must meet strict flammability requirements. Standards applicable to this bid, if any, will be delineated in the Detailed Specifications.
- (10) LABOR/TRADES - Any labor, materials or means whose employment, or utilization during the course of this contract, shall not in any way cause or result in strike, work stoppages, delays, suspension of work; or similar troubles by workers employed by this contractor or his subcontractors, or by any of the trades working in or about the buildings and premises where work is being performed. Any violation by the contractor of this requirement may in the sole judgment of DASNY be considered as proper and sufficient cause for declaring the contractor to be in default, and for the owner to take action against him as set forth in the Purchasing General Conditions, Article VIII, "Termination", or such other action as DASNY may deem proper.
- (11) Bid results are available on the DASNY website (www.DASNY.org). Bid results will not be given over the phone.
- (12) If you are a NYS Certified Minority or Women Owned Business, please include a copy of your certification with the bid.



DASNY

ANDREW M. CUOMO
Governor

ALFONSO L. CARNEY, JR.
Chair

GERRARD P. BUSHELL, Ph.D.
President & CEO

SUPPLEMENTAL SPECIFICATIONS

The following items are attached for informational purposes. Referenced documents need not be returned with the proposal. These documents are only applicable to the successful bidder and the ensuing procurement contract. Documents are only applicable to the successful bidder and the ensuing procurement contract. Documents applicable to the procurement that will result from this Invitation for Bids are designated by a check box (☒). Unless otherwise indicated, the referenced documents are located at the end of this Invitation for Bids.

- ☒ **Purchasing General Conditions** – The DASNY Purchasing General Conditions contains terms and conditions of purchases made by DASNY. It is recommended that this document be reviewed fully.
- ☒ **M/WBE Utilization Plan and Request for Waiver** - Minority and Women-Owned Business Enterprise (M/WBE) goals for this project are 18% and 12%, respectively. The successful bidder shall be required to complete a Utilization Plan or Request for Waiver, to be approved by DASNY’s Opportunity Programs Group. Reference Purchasing General Conditions, Article XIX, Affirmative Action for Contracts Mr. Michael Clay, DASNY Opportunity Programs Group at (518) 257-3464, is available to assist all bidders in attaining these goals. *Reference the enclosed “Good Faith Efforts Guidelines”.*
- ☒ **Supplemental General Requirements** – Attached (if applicable) are the Supplemental General Requirements (SGRs) which provide important logistical information and additional conditions which govern this procurement. Please read these SGRs carefully.
- ☒ **Form of DASNY Contract** – The procurement resulting from the Invitation for Bids will be executed through a DASNY purchase order and a related contract. The contract executed with the successful bidder will be in the same substantial form as the attached “Form of Contract”. Note that this Invitation for Bids and any response to such will be annexed as binding terms of the purchase agreement.
- ☒ **Certificate of Insurance** (*sample enclosed*) – The successful bidder will be required to provide a Certificate of Insurance pursuant to Article XIV of the enclosed Purchasing General Conditions. The certificate shall name DASNY and other designated parties as additional insureds.

CORPORATE HEADQUARTERS
515 Broadway
Albany, NY 12207-2964

T 518-257-3000
F 518-257-3100

NEW YORK CITY OFFICE
One Penn Plaza, 52nd Floor
New York, NY 10119-0098

T 212-273-5000
F 212-273-5121

BUFFALO OFFICE
539 Franklin Street
Buffalo, NY 14202-1109

T 716-884-9780
F 716-884-9787

DORMITORY AUTHORITY STATE OF NEW YORK

**WE FINANCE, BUILD AND
DELIVER.**

www.dasny.org



DASNY

ANDREW M. CUOMO
Governor

ALFONSO L. CARNEY, JR.
Chair

GERRARD P. BUSHELL, Ph.D.
President & CEO

SUPPLEMENTAL SPECIFICATIONS CONTINUED

- Worker’s Compensation / Disability Insurance** – The successful proposer will be required to provide specific documentation with respect to Worker’s Compensation and Disability Insurance pursuant to Article XIV of the enclosed Purchasing General Conditions. Requirements are detailed in the enclosed “Workers’ Compensation and Disability Benefits Requirements” document.

- Prevailing Wage Schedule** – NYS Labor Law requires all wages paid by contractors and subcontractors on public work projects be paid at the prevailing wage rates. Enclosed is the current rate schedule for the appropriate county. Contractors and Subcontractors are responsible for obtaining current rates throughout the course of the project. The NYS Department of Labor (NYS DOL) updates these rates on July 1st of each year. Current rates can be obtained on the NYS DOL website (www.labor.state.ny.us) or by fax at (518) 485-1870. Note that an executed Contractor and Subcontractor Certification and certified payrolls, which include the hours and days worked by each workman, laborer or mechanic, the occupation at which he worked, the hourly wage rate paid and the supplements paid or provided, must be submitted with each and every payment requisition. **DASNY will not process an invoice without this information.** Forms are available on the DASNY website:
<http://www.dasny.org/construc/forms2/vendors.php>

- Labor and Material Payment Bond** – The successful bidder must be prepared to provide surety bonds prior to award in accordance with Article XIV of the DASNY Purchasing General Conditions. The costs of these bonds are to be separately stated in the total bid price as indicated on the Bid Breakdown and Schedule.

- Performance Bond** – The Successful bidder must be prepared to provide surety bonds prior to award in accordance with Article XIV of DASNY Purchasing General Conditions. The costs of these bonds are to be separately stated in the total bid price as indicated on the Bid Breakdown and Schedule.

- Standard Vendor Responsibility Questionnaire (SVRQ)** – The successful proposer, in accordance with Article XXII of DASNY Purchasing General Conditions, will be required to complete the enclosed SVRQ. The award of a contract will be subject to a review of the information contained in these forms.

CORPORATE HEADQUARTERS
515 Broadway
Albany, NY 12207-2964

T 518-257-3000
F 518-257-3100

NEW YORK CITY OFFICE
One Penn Plaza, 52nd Floor
New York, NY 10119-0098

T 212-273-5000
F 212-273-5121

BUFFALO OFFICE
539 Franklin Street
Buffalo, NY 14202-1109

T 716-884-9780
F 716-884-9787

DORMITORY AUTHORITY STATE OF NEW YORK

**WE FINANCE, BUILD AND
DELIVER.**

www.dasny.org



DASNY

ANDREW M. CUOMO
Governor

ALFONSO L. CARNEY, JR.
Chair

GERRARD P. BUSHELL, Ph.D.
President & CEO

SUPPLEMENTAL SPECIFICATIONS CONTINUED

- NYS Uniform Contracting Questionnaire (UCQ)** – The successful proposer will be required to complete the enclosed UCQ. The award of a contract will be subject to a review of the information contained in these forms.

- DASNY Contractor and Consultant Questionnaire (CCQ)** – The successful proposer will be required to complete the enclosed CCQ. The award of a contract will be subject to a review of the information contained in these

CORPORATE HEADQUARTERS
515 Broadway
Albany, NY 12207-2964

T 518-257-3000
F 518-257-3100

NEW YORK CITY OFFICE
One Penn Plaza, 52nd Floor
New York, NY 10119-0098

T 212-273-5000
F 212-273-5121

BUFFALO OFFICE
539 Franklin Street
Buffalo, NY 14202-1109

T 716-884-9780
F 716-884-9787

DORMITORY AUTHORITY STATE OF NEW YORK

**WE FINANCE, BUILD AND
DELIVER.**

www.dasny.org



DASNY

ANDREW M. CUOMO
Governor

ALFONSO L. CARNEY, JR.
Chair

GERRARD P. BUSHELL, Ph.D.
President & CEO

SUPPLEMENTAL GENERAL REQUIREMENTS

Requests for Information:

All questions pertaining to Re-Bid No. 641 – Furnish, Deliver and Install Laser Curtains are due no later than 4:00 p.m. on September 25, 2019 to tgraffeo@dasny.org. RFI Responses will be posted via Addenda to DASNY's Website in the Attachments Section of the Bid Opportunity Page for Re-Bid No. 641.

CORPORATE HEADQUARTERS
515 Broadway
Albany, NY 12207-2964

T 518-257-3000
F 518-257-3100

NEW YORK CITY OFFICE
One Penn Plaza, 52nd Floor
New York, NY 10119-0098

T 212-273-5000
F 212-273-5121

BUFFALO OFFICE
539 Franklin Street
Buffalo, NY 14202-1109

T 716-884-9780
F 716-884-9787

DORMITORY AUTHORITY STATE OF NEW YORK

**WE FINANCE, BUILD AND
DELIVER.**

www.dasny.org



DASNY

ANDREW M. CUOMO
Governor

ALFONSO L. CARNEY, JR.
Chair

GERRARD P. BUSHELL, Ph.D.
President & CEO

SCOPE OF WORK

Furnish, deliver and install new Laser Curtains and furnish and deliver an Integrated Laser Entry Control System per the bid documents and as follows:

Furnish and Install Items:

- 1) Furnish and installation of new heavy-duty Laser track with supports fastened to structure above.
- 2) C-15 Certificates and tags for each room.
- 3) Shop drawings of all rooms with curtains.
- 4) 8 Window Covers at 25.5" x 31.25"
- 5) 8 Window Covers at 25.5" x 48.5"

Furnish ONLY items: (installation by General Contractors Electrician):

- 1) 6 of Entry Guard Control Panels
- 2) 13 of Entry Guard illuminated dual status signs
- 3) 21 of Entry Guard magnetic safety interlocks
- 4) 21 of Entry Guard dual interlock receptacles
- 5) 42 of Entry Guard interlock connector plugs
- 6) 21 of Entry Guard emergency stop switches

CORPORATE HEADQUARTERS
515 Broadway
Albany, NY 12207-2964

T 518-257-3000
F 518-257-3100

NEW YORK CITY OFFICE
One Penn Plaza, 52nd Floor
New York, NY 10119-0098

T 212-273-5000
F 212-273-5121

BUFFALO OFFICE
539 Franklin Street
Buffalo, NY 14202-1109

T 716-884-9780
F 716-884-9787

DORMITORY AUTHORITY STATE OF NEW YORK

**WE FINANCE, BUILD AND
DELIVER.**

www.dasny.org



DASNY

ANDREW M. CUOMO
Governor

ALFONSO L. CARNEY, JR.
Chair

GERRARD P. BUSHELL, Ph.D.
President & CEO

DETAILED SPECIFICATIONS and DRAWINGS

See attached

CORPORATE HEADQUARTERS

515 Broadway
Albany, NY 12207-2964

T 518-257-3000
F 518-257-3100

NEW YORK CITY OFFICE

One Penn Plaza, 52nd Floor
New York, NY 10119-0098

T 212-273-5000
F 212-273-5121

BUFFALO OFFICE

539 Franklin Street
Buffalo, NY 14202-1109

T 716-884-9780
F 716-884-9787

DORMITORY AUTHORITY STATE OF NEW YORK

**WE FINANCE, BUILD AND
DELIVER.**

www.dasny.org

SECTION 11 5363
LASER SAFETY EQUIPMENT

PART 1 - GENERAL

1.1 SECTION INCLUDES

- A. Laser curtain, track, and hardware.
- B. Laser entry control system.

1.2 REFERENCE STANDARDS

- A. ANSI Z136.1 - Safe Use of Lasers.

1.3 SUBMITTALS

- A. Product Data:
 - 1. For laser curtain and track. Include data on physical characteristics, durability, fade resistance, and performance and flame-resistance characteristics.
 - 2. For laser entry control system: Include product data electrical requirements.
- B. Shop Drawings: Indicate locations and mounting details for laser curtain track and entry control system.
 - 1. For laser curtain and track. Include plans, details, and locations.
 - 2. For entry control system. Submit plans, details, locations, wiring and control diagrams, and design and testing data.
- C. Samples: In sets for each color, texture, and pattern specified.
- D. Certificate: Submit manufacturer's documentation that curtain meets specified requirements.
- E. Maintenance Data: Include operation and maintenance information for laser curtains and laser entry control system in the operation and maintenance manual.

1.4 QUALITY ASSURANCE

- A. Installer Qualifications: Installers shall have minimum five years of documented experience for installation of products of this Section.
 - 1. Laser Entry Control System: Installers shall be approved by system manufacturer.
- B. Single Source: Provide laser curtains and track assemblies by a single manufacturer.

1.5 PROJECT CONDITIONS

- A. Environmental Limitations: Do not install laser curtains and laser entry control system until spaces are enclosed and weatherproof, wet work in spaces is complete and dry, work above ceilings is complete, and ambient temperature and humidity conditions are maintained at the levels indicated for Project when occupied for its intended use.

PART 2 - PRODUCTS

2.1 LASER CURTAIN AND TRACK

- A. Manufacturers: Provide products by one of the following:
 - 1. Beamstop'r Laser Barriers, Inc.: www.beamstopr.com.
 - 2. Kentek; Flex-Guard: www.kentek-laser.com.
 - 3. Rockwell Laser Industries, Inc.: www.rli.com.
- B. Laser Curtain Fabric: Oil and water resistant and permanently flame resistant, with double-vinyl black color laminated to back for opacity.
- C. Curtain Performance:
 - 1. Flame Resistance: Meet requirements of State of California test and in accordance with NFPA Standard No. 701-2010, test methods 1 and 2.
 - 2. Rating: 100 Watts/sq. cm.
 - 3. Threshold limit for beam penetration through the curtain at the minimum distance indicated on the Drawings shall not be exceeded for exposure time of 60 seconds.
 - 4. No part of curtain or track shall release toxic fumes following laser exposure.
- D. Extruded Aluminum Track: Minimum 1-1/4 inches wide by 3/4 inch high, with minimum wall thickness of 0.062 inch.
 - 1. Finish: Satin anodized.
- E. Track Accessories: Fabricate splices, corners, end caps, connectors, end stops, coupling and joining sleeves, wall flanges, brackets, ceiling clips, Velcro strips, and other accessories from same material and with same finish as track.
- F. Curtain Carriers: Two nylon rollers and nylon axle with rustproof wire and bead chain and chrome-plated steel or aluminum hook.
- G. Exposed Fasteners: Stainless steel.
- H. Concealed Fasteners: Hot-dip galvanized.
- I. Curtain Fabrication:
 - 1. Curtain Size: Make curtains at least 10 percent wider than track length and long enough to overlap finished floor minimum 2 inches. Bottom of curtain shall be weighted.
 - a. Provide curtains with front and rear valances for light trap. Valances shall be same material as curtains with sewn-on Velcro strip for mounting.
 - b. Curtains shall conform to ANSI Z136.1 "Safe Use of Lasers"
 - 2. Construction: Sewn flat with 10 percent fullness.
 - 3. Curtain Lengths: 1/4 inch above finished floor.
 - 4. Seams: French-style with no visible raw edges.
 - 5. Top Hem: Heavy gauge fabric reinforcing strip in top hem; brass grommets at 8 inches o.c.
 - 6. Bottom Hem: Weighted.
 - 7. Edges: Provide hook and loop sealing strips at outside vertical edges to provide light trap overlaps attachment to walls.
 - 8. Sew curtains using lock stitch and in a manner so that fabric is not pierced in a way that will allow light through the needle holes.
 - 9. Sew side and bottom hems French style with no visible raw edges. Crooked or selvaged edges in lieu of side or bottom hems are prohibited. Overlap vertical seams and provide with Velcro strips to facilitate "light-trap" overlaps.

10. Provide stay-put type fasteners as indicated on Drawings.
- J. Provide laser curtain interlock assembly as indicated on Drawings.

2.2 LASER ACCESS CONTROL SYSTEM

- A. Manufacturers:
 1. Kentek Corporation: www.kentek-laser.com. Basis of design as follows:
 - a. Control Module: ETG-CP Entry-Guard.
 - b. Status Sign: ETG-DLS-2 Entry-Guard.
 - c. Emergency Stop Switch: ETG-ES-F Entry-Guard.
 - d. Safety Interlock: ETG-INLK Entry-Guard.
 - e. Dual Interlock Receptacle: ETG-X1 Entry-Guard.
 - f. Interlock Connector Plug: ETG-X2 Entry-Guard.
 2. Rockwell Laser Industries, Inc.: www.rli.com.
- B. Laser Access Control System: Integrated system to control entry to and egress from laser operation areas and laser emission to areas where there is accessible or exposed laser energy, meeting requirements of ANSI Z136.1.
- C. System Components:
 1. Main Control Module: Wall-mounted, painted metal enclosure with front-mounted controls, housing microprocessor controller. Front panel controls include the following:
 - a. Key lock.
 - b. System power key switch.
 - c. Start, Stop, Exit, and Emergency Stop buttons.
 - d. System status indicators including, but not limited to, Power On, Entryway/Doors Closed, and Interlock/Maglock On.
 2. Magnetic door locks.
 3. Entry keypads.
 4. Remote pushbuttons.
 5. Emergency access switches.
 6. Emergency stop buttons.
 7. Laser interlock or shutter.
 8. Illuminated safety signs.
 - a. Metal, lighted sign box with translucent plastic laser status signs; back-mounted or edge-mounted as required.
 - b. Two-way and two color to indicate Safe - No Laser Hazard and Danger - Laser Radiation.
 9. Nondefeatable safety latches.
 10. Circuitry.
 11. Accessories: Manufacturer's standard.
- D. Entry Laser System Operation and Controls:
 1. Emergency stop and external emergency access controls.
 2. Isolated, normally open, relay closures for control of laser interlocks and shutters.
 3. Isolated, normally open/normally closed, auxiliary laser interlock relays.
 4. Isolated, magnetic, door latch relay.
 5. Universal interface to entry key cards or dedicated key pads.
 6. Automated, illuminated laser safety sign control.
 7. Audible indicator for interlock timeout and exit delay (defeatable).
 8. Adjustable exit delay; 5 to 90 seconds.
 9. Automatic shutdown of lasers and unlocking of doors by building fire or evacuation alarm.

10. Automatic shutdown of lasers when access parameters are violated.
11. Optically isolated external inputs.
12. Two, automatic, warning sign modes.
13. Easy remote of system Enable and Exit Request controls.
14. External computer/access controller monitor interface.
15. Full function diagnostic indicators.
16. Built-in, low voltage power supply.

PART 3 - EXECUTION

3.1 INSTALLATION

- A. General: Install tracks level and plumb, according to manufacturer's written instructions. Provide track fabricated from one continuous length, up to 16 feet.
- B. Track Accessories: Install splices, corners, end caps, connectors, end stops, coupling and joining sleeves, and other accessories as required for a secure and operational installation.
- C. Curtain Carriers: Provide enough curtain carriers for 6 inch spacing along full length of curtain plus an additional carrier.

3.2 CLEANING AND ADJUSTING

- A. Press curtain material to remove folds, creases, and wrinkles.
- B. Repair or remove and replace defective work. Repairs shall be indistinguishable from undamaged curtain and track.
- C. Clean curtains and tracks. Touch up damaged track finish.

END OF SECTION

THE CITY UNIVERSITY OF NEW YORK

ASRC/CCNY SCIENCE RESEARCH CENTER

The City College of New York

New York, New York

DASNY Project Number:
257110
Flad Project Number:
05432-82


ASRC PHOTONICS LABORATORY RENOVATIONS

June 11th, 2019

Drawing Sheet Index

Project Sheet No.	NYC DoB Sheet No.	Sheet Name	5/6/2019	6/11/2019
GN General				
GN-000	T 000.00	COVER SHEET, DRAWING LIST & PLOT PLAN	x	x
GN-001	G 001.00	PLOT PLAN & BUILDING NOTES	x	
GN-101	G 101.00	PARTIAL LIFE SAFETY PLAN - GROUND LEVEL	x	
GN-220	G 220.00	LIFE SAFETY PLAN - LEVEL 2	x	
DM Plans				
AD-221	DM 220.00	PARTIAL DEMOLITION FLOOR PLAN - LEVEL 2 - SOUTH	x	
AD-222	DM 221.00	PARTIAL DEMOLITION FLOOR PLAN - LEVEL 2 - NORTH	x	
DPL-221	DM 222.00	DEMOLITION PLAN SECOND LEVEL SOUTH	x	
DPL-222	DM 223.00	DEMOLITION PLAN SECOND LEVEL NORTH	x	
DM-018	DM 018.00	DEMOLITION PLAN 1ST LEVEL (+125.00) INTERSTITIAL AREA 4	x	
DM-221	DM 224.00	DEMOLITION PLAN SECOND LEVEL SOUTH	x	
DM-222	DM 225.00	DEMOLITION PLAN SECOND LEVEL NORTH	x	
A Plans				
AE-014	A 014.00	PARTIAL LABORATORY PLAN - GROUND LEVEL	x	
AE-221	A 221.00	PARTIAL LABORATORY FLOOR PLAN - LEVEL 2 - SOUTH	x	
AE-222	A 222.00	PARTIAL LABORATORY FLOOR PLAN - LEVEL 2 - NORTH	x	
AB-221	A 321.00	PARTIAL REFLECTED CEILING PLAN - LEVEL 2 - SOUTH	x	
AB-222	A 322.00	PARTIAL REFLECTED CEILING PLAN - LEVEL 2 - NORTH	x	
AE-600	A 600.00	EQUIPMENT LIST	x	
AE-850	A 850.00	INTERIOR ELEVATIONS	x	x
AE-900	A 900.00	SCHEDULES AND DETAILS	x	x
AE-901	A 901.00	DETAILS	x	x
AE-902	A 901.00	DETAILS	x	
P Plans				
PL-000	P 000.00	PLUMBING SYMBOLS AND ABBREVIATIONS	x	
PL-014	P 014.00	FLOOR PLAN GROUND LEVEL (+117.00) AREA 4	x	
PL-018	P 018.00	FLOOR PLAN 1ST LEVEL (+125.00) INTERSTITIAL AREA 4	x	
PL-221	P 221.00	FLOOR PLAN SECOND LEVEL SOUTH	x	
PL-222	P 222.00	FLOOR PLAN SECOND LEVEL NORTH	x	
M Plans				
M-000	M 000.00	MECHANICAL SYMBOLS AND ABBREVIATIONS	x	
M-014	M 014.00	FLOOR PLAN GROUND LEVEL (+117.00) AREA 4	x	
M-018	M 018.00	FLOOR PLAN 1ST LEVEL (+125.00) INTERSTITIAL AREA 4	x	
M-221	M 221.00	FLOOR PLAN SECOND LEVEL SOUTH	x	
M-222	M 222.00	FLOOR PLAN SECOND LEVEL NORTH	x	
M-300	M 300.00	MECHANICAL DETAILS	x	
M-400	M 400.00	PARTIAL FLOOR PLAN SHAFT AND EXHAUST RISER	x	
M-500	M 500.00	MECHANICAL SCHEDULES	x	
M-600	M 600.00	MECHANICAL LAB CONTROL DIAGRAMS	x	
E Plans				
E-000		ELECTRICAL SYMBOLS AND ABBREVIATIONS	x	
E-400		ELECTRICAL PANEL SCHEDULES	x	
E-401		ELECTRICAL PANEL SCHEDULES	x	
E-402		ELECTRICAL PANEL SCHEDULES	x	

Project Sheet No.	NYC DoB Sheet No.	Sheet Name	5/6/2019	6/11/2019
EL (Lighting) Plans				
DEL-014		DEMOLITION PLAN LIGHTING GROUND LEVEL (+117.00) AREA 4	x	
DEL-221		DEMOLITION PLAN LIGHTING SECOND LEVEL SOUTH	x	
DEL-222		DEMOLITION PLAN LIGHTING SECOND LEVEL NORTH	x	
EL-014		FLOOR PLAN LIGHTING GROUND LEVEL (+117.00) AREA 4	x	
EL-221		FLOOR PLAN LIGHTING SECOND LEVEL SOUTH	x	
EL-222		FLOOR PLAN LIGHTING SECOND LEVEL NORTH	x	
EP (Power) Plans				
DEP-014		DEMOLITION PLAN POWER GROUND LEVEL (+117.00) AREA 4	x	
DEP-221		DEMOLITION PLAN POWER SECOND LEVEL SOUTH	x	
DEP-222		DEMOLITION PLAN POWER SECOND LEVEL NORTH	x	
EP-014		FLOOR PLAN POWER GROUND LEVEL (+117.00) AREA 4	x	
EP-221		FLOOR PLAN POWER SECOND LEVEL SOUTH	x	
EP-222		FLOOR PLAN POWER SECOND LEVEL NORTH	x	
FA Plans				
DEF-014	DM 014.00	DEMOLITION PLAN FIRE ALARM GROUND LEVEL (+117.00) AREA 4	x	
DEF-221	DM 221.00	DEMOLITION PLAN FIRE ALARM SECOND LEVEL SOUTH	x	
DEF-222	DM 222.00	DEMOLITION PLAN FIRE ALARM SECOND LEVEL NORTH	x	
EF-014	FA 014.00	FLOOR PLAN FIRE ALARM GROUND LEVEL (+117.00) AREA 4	x	
EF-221	FA 221.00	FLOOR PLAN FIRE ALARM SECOND LEVEL SOUTH	x	
EF-222	FA 222.00	FLOOR PLAN FIRE ALARM SECOND LEVEL NORTH	x	
FA-515	FA 515.00	ELECTRICAL MODIFICATION TO EXISTING PRE-ACTION SYSTEM PARTIAL LABORATORY PLAN GROUND LEVEL	x	
SP Plans				
FX-001	SP 001.00	SPRINKLER NOTES, KEY OF SYMBOL, PLOT PLAN AND DRAWING LIST	x	
FX-002	SP 002.00	SPRINKLER NOTES AND SPECIFICATIONS	x	
FX-003	SP 003.00	FLOOD INSURANCE RATE MAP 3604970079G	x	
FX-004	SP 004.00	FLOOD INSURANCE RATE MAP 3604970079F	x	
FX-014	SP 014.00	SPRINKLER PARTIAL LABORATORY PLAN GROUND LEVEL	x	
FX-100	SP 100.00	SPRINKLER DEMOLITION PARTIAL REFLECTED CEILING PLAN LEVEL-2 SOUTH	x	
FX-101	SP 101.00	SPRINKLER DEMOLITION PARTIAL REFLECTED CEILING PLAN LEVEL-2 NORTH	x	
FX-220	SP 320.00	SPRINKLER PARTIAL REFLECTED CEILING PLAN LEVEL-2 SOUTH	x	
FX-221	SP 321.00	SPRINKLER PARTIAL REFLECTED CEILING PLAN LEVEL-2 NORTH	x	
FX-400	SP 400.00	SPRINKLER RISER DIAGRAM	x	
FX-401	SP 401.00	SPRINKLER PRE-ACTION NOTES & SEQUENCE OF OPERATION (FOR REFERENCE ONLY)	x	
FX-501	SP 501.00	SPRINKLER SCHEDULES & DETAILS	x	

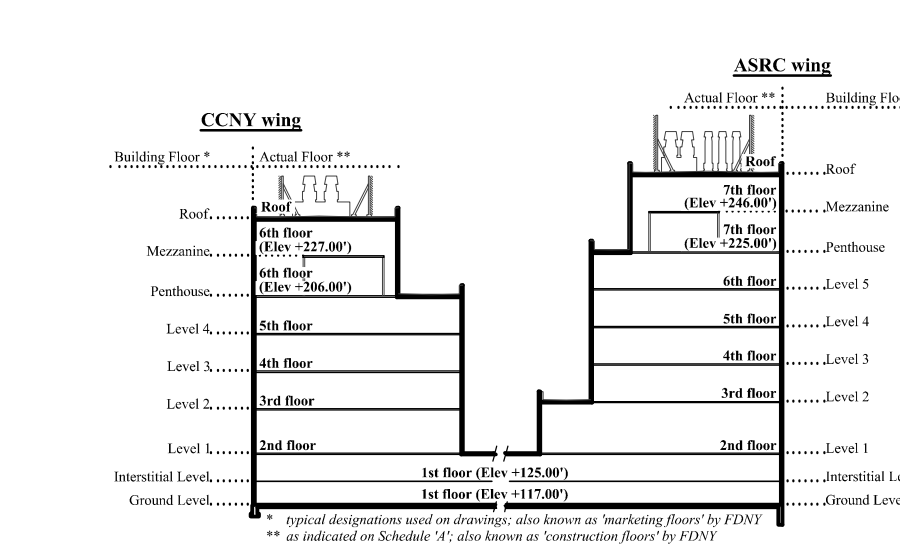


Flad Architects
Facility Leaders in Architectural
Engineering Design, P.C.
201 4th Avenue, Ste. 510
New York, NY 10003
Tel: 212-697-2000
Fax: 212-697-4000
www.flad.com

AEI
Affiliated Engineers, P.C.

Crescent Associates

Rev	Date	Description of Issue
01	06/11/19	ADDENDUM 01
0	05/06/19	CONSTRUCTION DOCUMENTS

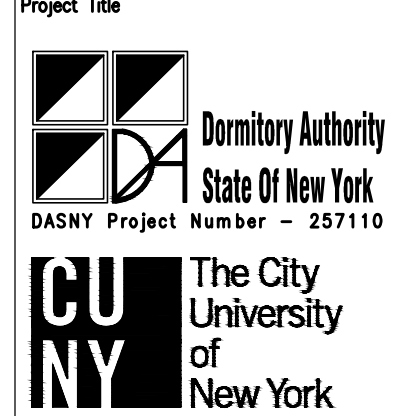

ASRC Photonics Lab Renovations

The City College of New York

85 St Nicholas Terrace
New York, NY 10027

DASNY #
257110

Scale
N/A

Company Drawn By
Flad Architects

Project Phase
CONSTRUCTION DOCUMENTS

Date
06/11/2019
Drawn By
KS

Flad Project Number
05432-82
Checked By
DH

Sheet Title
Cover Sheet & Drawing List

Sheet Number
GN-000

NYC DOB Sheet Number
T-000.00

Page No.
1 OF 1

Application No.

DOB ESCAN

GENERAL CONSTRUCTION NOTES

- 1.1 The following list of general notes is intended to set a quality standard and an expectation of reasonable care to be exercised when working on projects at The City University of New York (CUNY).
1.2 The following General Notes shall be included in all DASNY/CUNY Project Drawing sets. Any notes that, in the opinion of the Consultant are inappropriate for the project shall be brought to the attention of the Project Manager for resolution.

DESIGN REQUIREMENTS

- 2.1 All work shall be done in accordance with the rules, regulations and procedures of DASNY/CUNY Design Requirements.
2.2 The general notes contained herein are part of the Drawings and Specifications and are to be complied with in all respects. More restrictive notes located elsewhere in the Contract Documents are to take precedence over those listed below.
2.3 The best trade practices and governmental authorities having jurisdiction over the work including, but not limited to, New York City Department of Buildings (DOB), the Board of Fire Underwriters, the New York City Fire Department and OSHA shall apply.
2.4 Prior to the commencement of the work, Contractor shall secure all required permits, approvals, etc. and obtain all necessary licenses etc. having jurisdiction and submit one (1) copy of such to the DASNY/CUNY Project Manager.

- 2.5 Contractor shall be responsible for the protection of and safety in and around the jobsite and adjacent properties. Provide and maintain protective flooring along traffic route for interior deliveries, materials, etc. to be installed in accordance to Owner's (DASNY/CUNY) Project Manual. All existing work from damage or loss for the duration of the project. Any damaged or stolen items shall be replaced to like new condition at no cost to the Owner.
2.6 Except for the area under construction, Owner will occupy site and existing buildings during entire construction period. Cooperate with Owner during construction operations to minimize conflicts and advance of activities that will affect Owner's operations.
2.7 Owner reserves the right to occupy and to install furniture and equipment in completed portions of the Work prior to substantial completion of the Work. Such placement and limited occupancy does not constitute acceptance of the Work.
2.8 Coordinate all Work with Project Manager that may result in high levels of noise and vibration, odors, or other disruption to Owner. Notify Owner not less than 5 working days in advance of proposed disruptive activities.
2.9 Smoking is not permitted within the Campus or within 50 feet of entrances, operable windows, or outdoor air intakes.
2.10 Use of tobacco or other controlled substances within the existing building is not permitted.
2.11 Contractor shall provide a schedule of required shop drawings/specs/cut sheets for approval within 7 working days from Project Kickoff. See specific trade notes and specifications for list of required submittals.
2.12 The contractor shall verify all existing conditions and dimensions in the field, whether or not specifically noted, and shall report any discrepancies between the Drawings and field conditions to the Project Manager and Architect prior to starting work.
2.13 Do not scale the Drawings.

- 2.14 Repetitive features may be drawn only once and shall be provided as if drawn in full.
2.15 Minor details not usually shown or specified, but necessary for proper construction of any part of the work shall be indicated as if they were indicated in the Drawings.
2.16 Contractor shall coordinate all trades, including Trade Work provided directly by the Owner, small plumbing and electrical work shall be performed by professionals licensed in their trades, who shall arrange for and obtain inspections and required signoffs.
2.17 Contractor shall keep temporary and permanent structural loading within intended limits.
2.18 Contractor shall be responsible for all cutting, fitting, or patching that may be required to complete the Work or to make its several parts fit together properly, and fit to receive or be received by work of others. Contractors shall submit shop drawings/specs/cut sheets for approval to the Architect and Engineer.
2.19 Contractor shall patch and repair floor finishes, walls, and ceiling finishes in accordance with the manufacturer's recommendations. No gypsum based floor patching or leveling shall be allowed. Patch and repair finishes where existing pipe and duct hangers and other appurtenances have been removed.
2.21 Seal all openings encountered during demolition - relocation of duct shafts or pipe chases, or removal of partitions or fixtures.
2.22 All areas affected by demolition of existing construction are to be patched to match new construction, and/or provide substrate to support new finish. Coordinate with new finishes to be applied as areas affected by demolition work.
2.23 Contractor shall lay out his own work and shall provide all dimensions required for other trades. The layout of partitions and openings shall be verified by the Architect prior to securing floor channels. Any work performed without Architect's approval does not relieve the contractor's responsibility for conforming with the Contract Documents.
2.24 All new construction shall match up with adjacent structures. Patch all cracks, holes and other imperfections to provide continuous smooth surface for joining new work.
2.25 The integrity of existing fireproofing shall always be restored and maintained.
2.26 Existing fire separations shall be maintained at all times, and if found compromised, shall be restored. Firestop all penetrations (new and existing) using acceptable firestop materials, means and methods.

- 2.27 All fire-rated spaces are to be fire stopped 20" O.C. horizontally and 8'-0" vertically per the New York City Building Code.
2.28 Where fire division or separations are being removed the contractor shall provide temporary rated construction to match existing rating to ensure that currently occupied spaces will not be exposed to any increased hazard of fire or smoke spread.
2.29 Ducts, pipes and conduits passing through rated construction shall have spaces not exceeding 1/2" be packed with mineral wool and closed off with close-fitting metal enclosures UON or specified in the Drawings or Specifications. Provide firestop assembly data showing required rating.
2.30 Where pipes, wires, conduits, ducts, etc. penetrate fire protection of individually applied encased structures, the penetration shall be sealed with fire-rated caulking or fire-rated sealant shall be closed off with close fitting metal enclosures or plates, as per New York City Building Code.
2.31 All corridors shall be 3'-8" minimum clear in compliance with the New York City Building Code.
2.32 All wood to be used as blocking or other specified purposes shall be fire retardant treated in compliance with the New York City Building Code UON.

- 2.33 Refer to Specifications for materials, assemblies, and products not specified on Drawings.
2.34 The contractor is to supply flush finished access doors where required, UON, and is responsible for providing all necessary hardware, electrical, sprinkler or other such devices installed or located above the ceiling or in the walls. Contractor to receive approval for all access door locations and sizes prior to ordering doors.
2.35 Contractor to provide 7 days notice for all building services shutdown requests (mechanical/HVAC, fire alarm, etc.) to the Project Manager and the Owner. All building services shutdown requests shall be coordinated with the convenience of Owner daily operations, not necessarily the convenience of the Contractor.
2.36 Contractor is not responsible for providing or installing final locksets UON. The Contractor is responsible for obtaining the correct templates from Owner provided shops and coordinating cutouts for sets. Owner's locksets to provide and install entry locksets and permanent cylinders.
2.37 Premises are to be turned over to the Owner at completion of work perfectly clean, including windows. All tile floors cleaned and waxed, bases wiped clean, carpets vacuumed, etc.

2014 TENANT PROTECTION PLAN NOTES - BC 28-104-8.4

- 1. Means of Egress: At all times during the course of construction, the egress from the various floors of the building will be maintained. Required egress shall not be obstructed at any time. All existing means of egress shall be maintained and kept clear at all times.
2. Fire Safety: All precautions shall be observed to maintain fire safety. As well as additional safety measures necessitated by the construction shall be strictly observed. All necessary laws and controls including those with respect to occupied dwellings shall be strictly observed.
3. Health Requirements: Dust shall be kept to a minimum and shall be removed after completion of each work day. Disposal of construction debris shall be done in the same manner. Contractor shall be responsible for the safe handling, use, storage, and disposal of all hazardous materials. All work created to all other areas within the building. Maintain sanitary facilities. Control pests at all times. Contractor shall comply with applicable laws relating to lead and asbestos. If observed, immediately contact Owner or Architect.
4. Compliance with Housing Standards: The requirements of the New York City Housing Maintenance Code shall be strictly adhered to. Services involving the building including plumbing, tenant control, construction operations shall not involve interruption of heating, water, or electrical services to other occupants of the building without proper posted notice. The New York State Multiple Dwelling Law shall be strictly observed.
5. Structural Safety: No structural work is contemplated for this alteration. Channelling of building members, including beams, columns, the structural floor slabs and exterior masonry walls shall not be permitted.

BUILDING DEPARTMENT NOTES

- 1. All work shall be constructed in conformance with the 2014 New York City Building Code and applicable sections of Local Law 26 of 2004.
2. All work shall be constructed in conformance with the Building Department rules and regulations of the New York City Building Department's Administrative Code and Local Law No. 78 of the City of New York, Latest Edition.
3. All necessary electrical work approvals shall be obtained from the Bureau of Electrical Control. Individual licenses in the trade and any pertinent regulations of the New York City Department of Buildings shall be strictly observed. All Department of Buildings permits are to be conspicuously posted, open to public inspection, until the completion of the use and operation of the equipment, or until the permit's expiration.
4. Contractors are to file Workmen's Compensation certificates and all other insurance certificates and one copy of the Building Department's permit may be required to conduct the work.
5. All OSHA requirements are to be complied with, including, but not limited to the provisions pertaining to safety barriers/baricades at all openings, existing or new, temporary due to removals.
6. The contractor shall coordinate all work procedures with requirements of local agencies and contractors to file the Building Department's permit.
7. All OSHA requirements are to be complied with, including, but not limited to the provisions pertaining to safety barriers/baricades at all openings, existing or new, temporary due to removals.
8. The contractor shall coordinate all work procedures with requirements of local agencies and contractors to file the Building Department's permit.
9. All materials, assemblies, forms and methods of construction and service equipment shall have been accepted for use under the prescribed test methods by the Commissioner or approved by the Board of Standards and Appeals (BSA).
10. Upon completion of the work, the contractor shall apply for Certificate of Occupancy or related permits and shall arrange for Department of Buildings inspections and signoffs required to obtain same.
12. Refer to Specification Section 01 4000 Quality and Code Requirements for additional requirements.

SPECIAL INSPECTIONS

- 1. DASNY (Owner) is responsible for engaging the testing agency that will be providing any and all Special Inspections and Tests, except where noted.
2. The following work items are subject to Special Inspections and Tests - are to be made and witnessed by or under the direct supervision of an architect or engineer retained by the Owner. Test reports and certificates of inspection shall be filed with the Building Department as required:
a. Sprayed Fire-Resistant Materials BC 1704.11
b. Mechanical Systems and Joints BC 1704.16
c. Fire-Resistant Penetrations and Joints BC 1704.27
d. Progress Inspections BC 1103.4
e. Fire-Resistance Rated Construction BC 1103.5
f. Final Fire-Resistance Rated Construction BC 1103.3
3. Energy Code Progress Inspections
a.1. HVAC and Service Water Heating Equipment IB3
a.2. HVAC and Service Water Heating System Controls IB4
a.3. HVAC Insulation and Sealing IB5
a.4. Electrical Energy Consumption IC1
a.5. Interior Lighting Power IC2
a.6. Lighting Controls IC5
4. Refer to Specification Section 01 4000 Quality and Code Requirements for additional requirements.

ENERGY CODE COMPLIANCE

To the best of my knowledge, belief, and professional judgment, the drawings and specifications, which comprise the construction documents for this project are in conformance with NYC EOC 2016.


ECC ANALYSIS

Table with columns: NYC Building Code, 2004 NYC EOC, and 2004 NYC EOC ANALYSIS. Contains detailed analysis of code compliance for various building systems.

Table with columns: NYC Building Code, 2004 NYC EOC, and 2004 NYC EOC ANALYSIS. Contains detailed analysis of code compliance for various building systems.


ARCHITECTURAL ABBREVIATIONS

Table listing architectural abbreviations such as ALUM, CAB, CHASIR, GLG, CMU, COL, CON, CORR, CR, CSK, etc. with their corresponding full names.

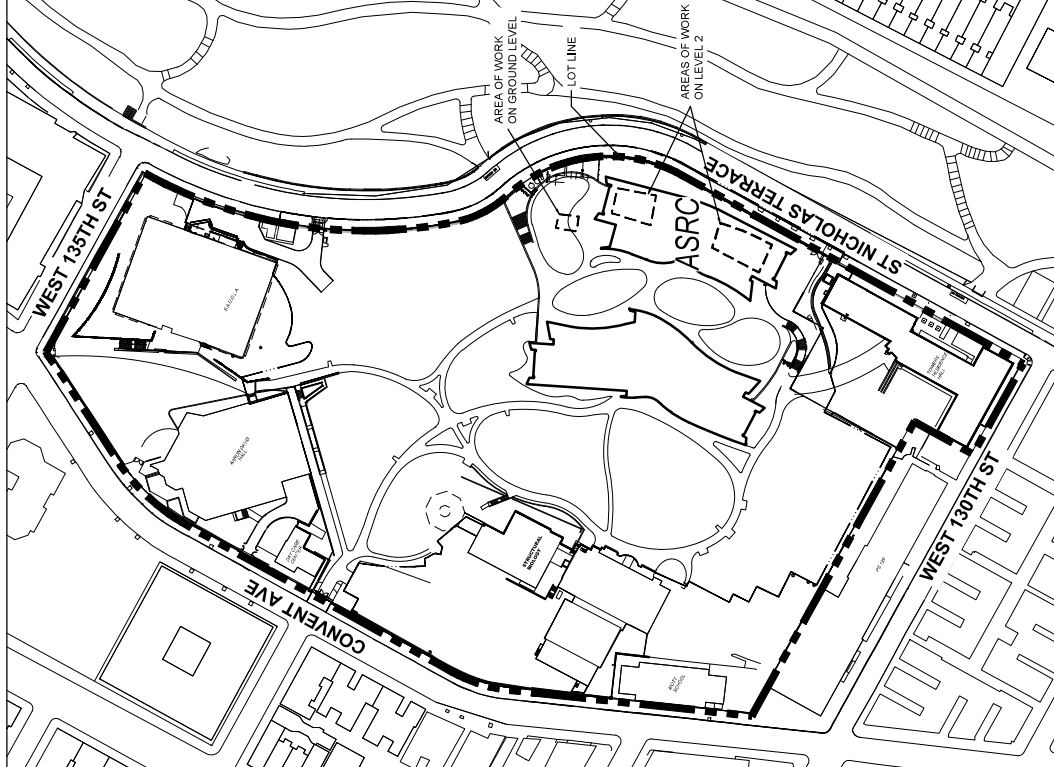

2 PLOT PLAN NTS

National Flood Hazard Layer FIRMette

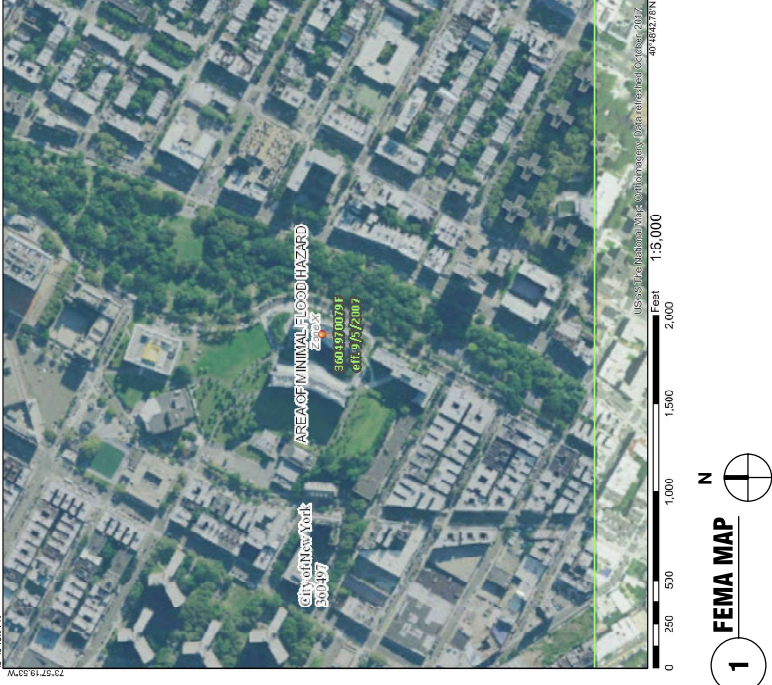

1 FEMA MAP N

PROPERTY DATA: 85 ST NICHOLAS TERRACE, NEW YORK, NY 10027. Includes block, lot, zone, map, BBN, occupancy, use group, construction, classification, no. of stories, and building height.

Flad Architects logo and contact information: 85 St Nicholas Terrace, New York, NY 10027. Phone: (212) 697-1000.

AEL Affiliated Engineers, P.C. logo and contact information: 1088659, 168-47.

Table with columns: No., Date, Description of Issues. Lists construction documents and their dates.

City of New York logos: Disability Authority, The City University of New York, ASRC Photonics Lab Renovations.


The City College of New York logo and address: 85 St Nicholas Terrace, New York, NY 10027.

Table with columns: Company Drawn By, Scale, Project Name, Date, Drawn By, Checked By. Lists project details.

Sheet Title: Plot Plan & Building Notes. Includes sheet number GN-001 and title G-001.00.

Sheet information: Sheet Number GN-001, Title G-001.00, Page No. 1 OF 1, Application No., and DOB BSNM.

Legend and notes for the flood hazard map. Includes symbols for Special Flood Hazard Areas, Other Areas, and Map Panels. Includes a note about FEMA map accuracy.

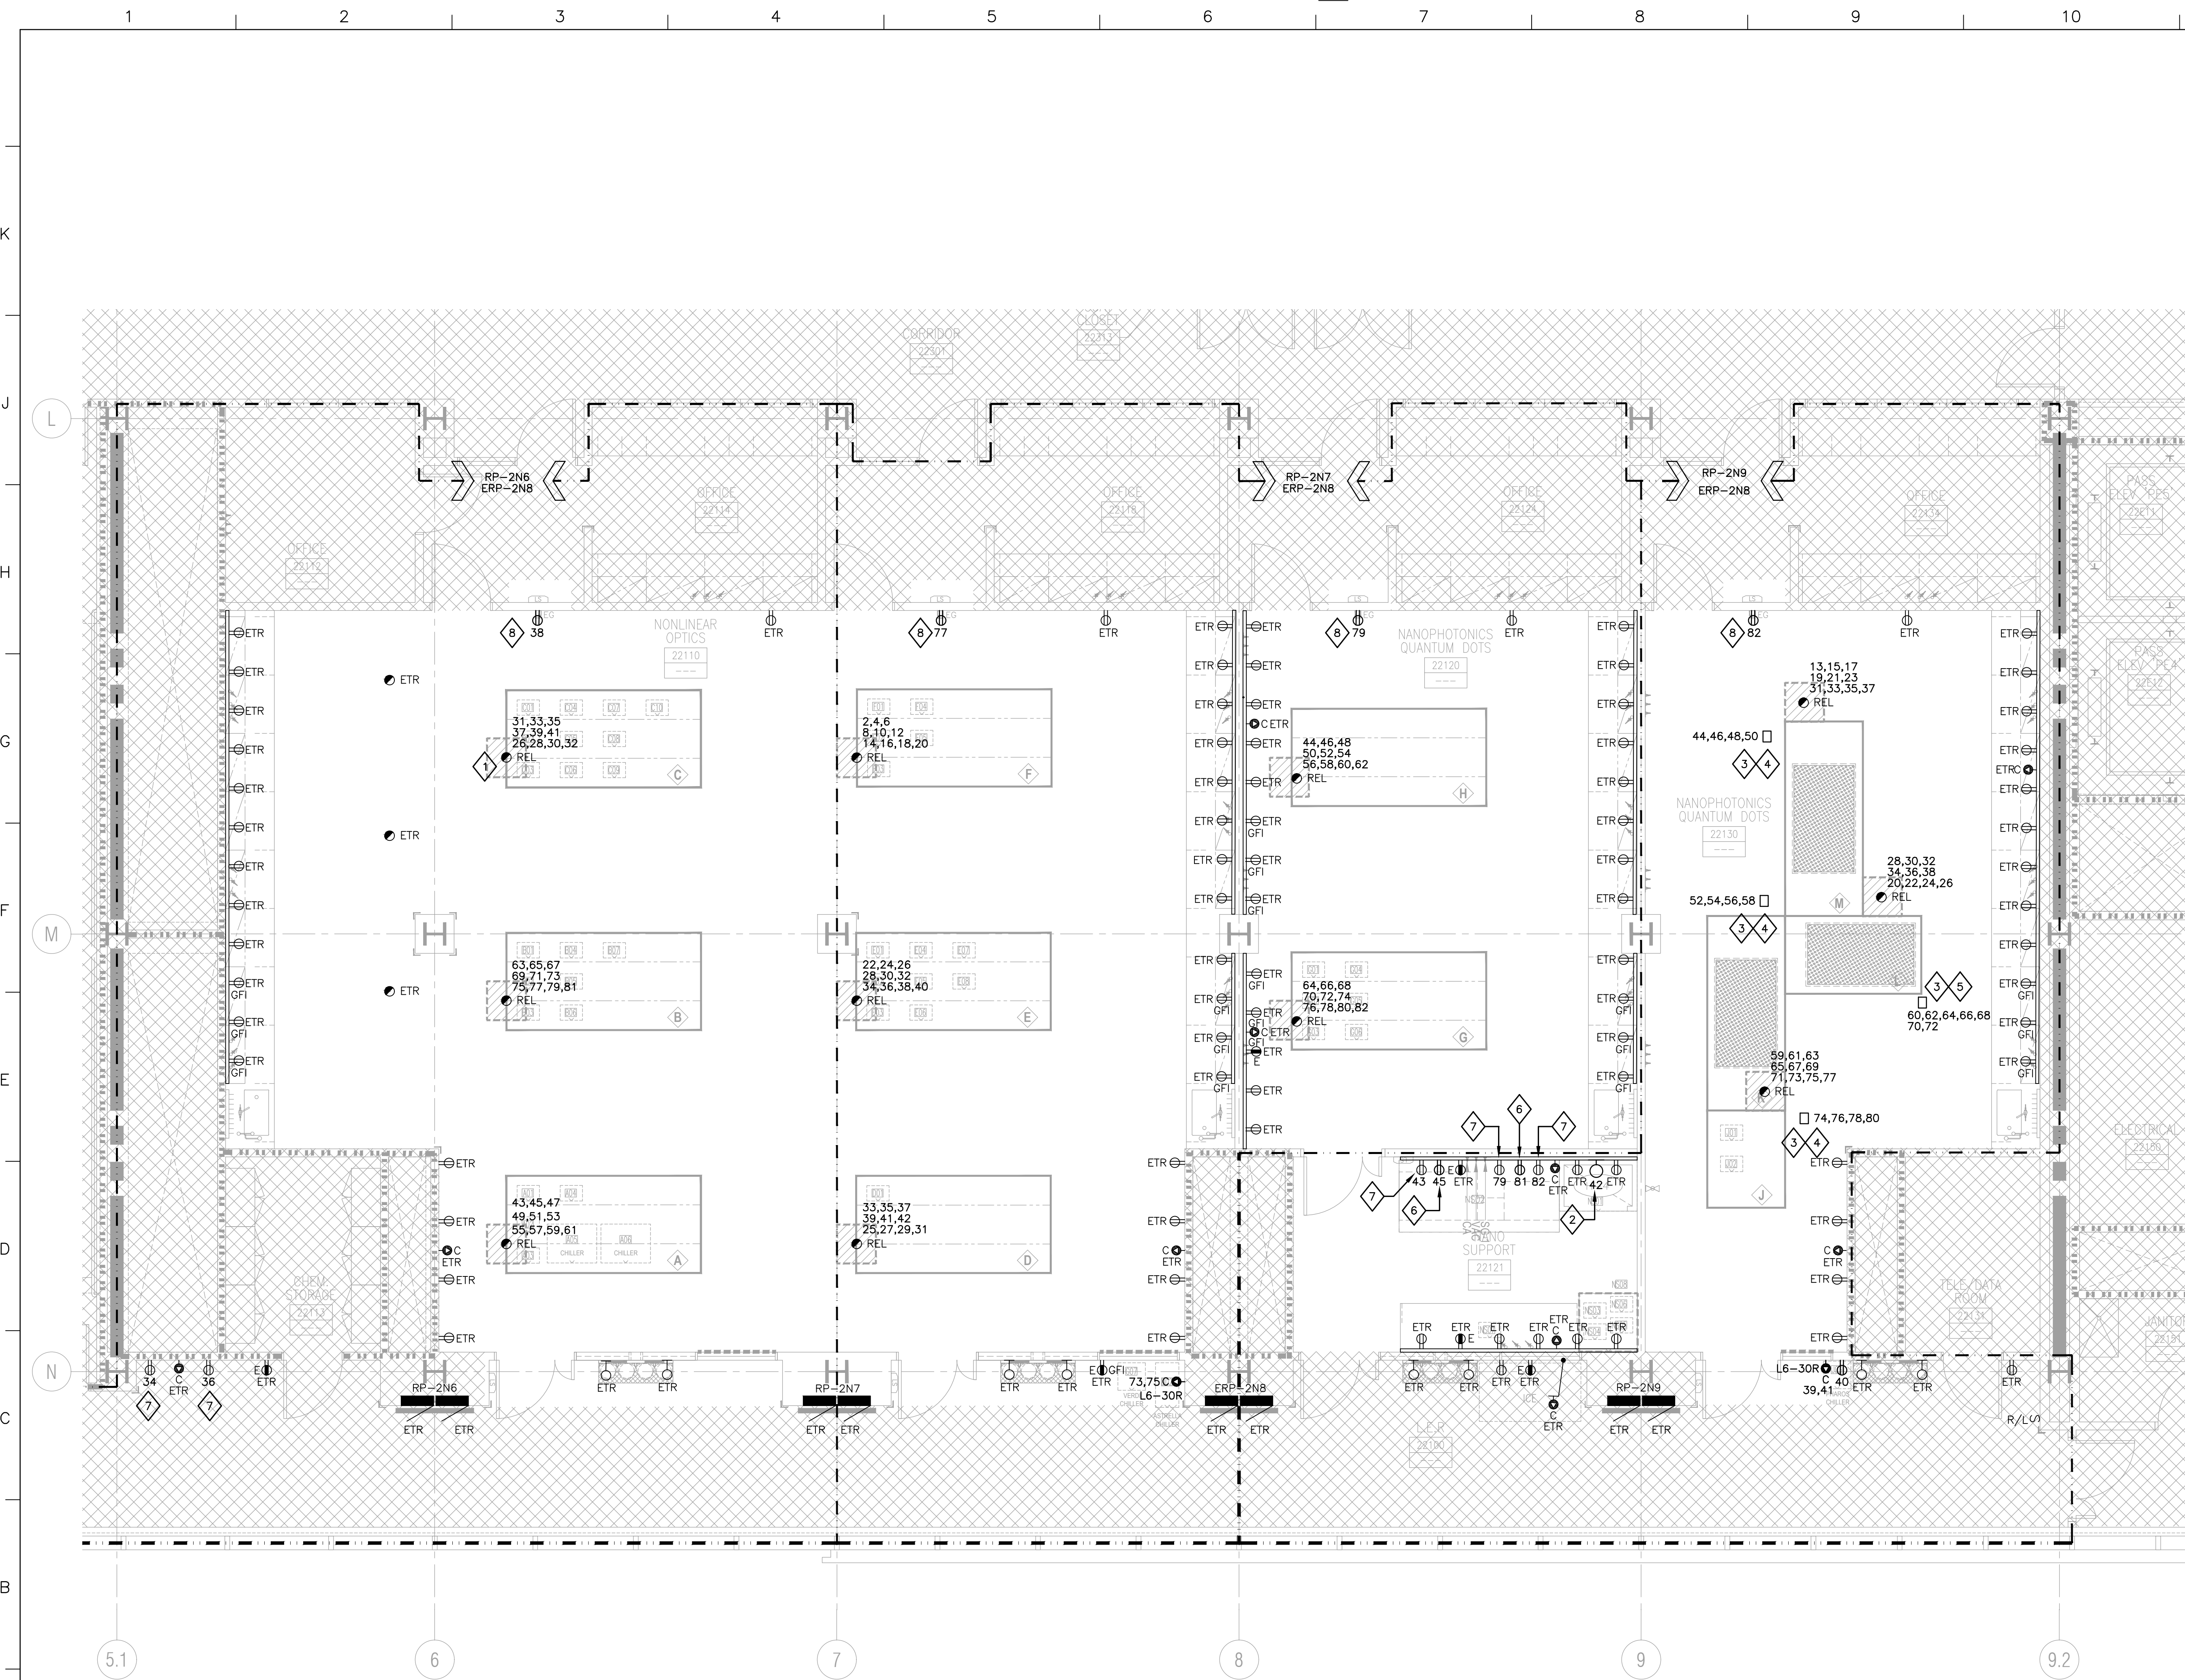


- GENERAL NOTES:**
1. REFER TO SHEET E-000 FOR SYMBOLS AND ABBREVIATIONS.
 2. CIRCUITING SHALL BE MAINTAINED TO DEVICES INDICATED AS EXISTING TO REMAIN. RELOCATE OR EXTEND EXISTING CONDUIT AND CONDUCTORS AS REQUIRED TO MAINTAIN CIRCUITING.
 3. CIRCUIT NUMBERS INDICATE QUANTITY OF RECEPTACLES PER CIRCUIT.
 4. REFER TO ARCHITECTURAL AND LAB ELEVATIONS FOR MOUNTING HEIGHT OF ABOVE COUNTER RECEPTACLES AND SURFACE MOUNTED RACEWAY.
 5. PROVIDE GFI PROTECTION FOR RECEPTACLES LOCATED WITHIN 6' OF LABORATORY SINKS, WHETHER SHOWN ON PLAN OR NOT.
 6. NUMBER ADJACENT TO POWER CONNECTION SYMBOL IS INTENDED CIRCUIT NUMBER. REFER TO PANEL DIVISION LINES FOR SOURCE PANELBOARD.
 7. ALL 120V, 20A BRANCH CIRCUITS IN LABS SHALL HAVE A DEDICATED NEUTRAL UNLESS NOTED OTHERWISE.
 8. PROVIDE 120V POWER CONNECTION TO FIRE/SMOKE DAMPER CONTROL TRANSFORMER. CIRCUIT TO 20/1 BREAKER IN NEAREST 208V LIFE SAFETY PANEL. REFER TO M-SERIES DRAWINGS FOR DAMPER LOCATION. PROVIDE 1 CIRCUIT FOR UP TO 10 DAMPERS.

- SHEET KEYNOTES:**
1. TYPICAL: CEILING SERVICE PANEL RELOCATED FROM SECOND FLOOR. PROVIDE (6) 120V, 20A AND (2) 208V, 1 PHASE, 30A CIRCUITS TO RECESSED CEILING SERVICE PANEL FOR POWER TO LASER TABLE. ELECTRICAL CONTRACTOR SHALL INSTALL (1) RECEPTACLE PER CIRCUIT AND (2) DATA CABLE CONNECTIONS TO EXISTING JACKS IN EACH DATA BACKBOX IN CEILING SERVICE PANEL. RECEPTACLES FACE PLATES AND SERVICE PANELS ARE PROVIDED BY LAB EQUIPMENT SUPPLIER.
 2. PROVIDE A 120V HARDWIRE CONNECTION TO FUME HOOD. COORDINATE EXACT LOCATION OF HARDWIRE CONNECTION WITH FUME HOOD CONTRACTOR PRIOR TO INSTALL.
 3. PROVIDE BLANK ALUMINIUM TWO-COMPARTMENT POLE WITH CAPACITY FOR UP TO A 60A DEVICE OR UP TO 12 RECEPTACLES. MINIMUM HEIGHT 10'-2" TO EXTEND ABOVE SUSPENDED CEILING. MOUNT RECEPTACLES ON LOWER HALF OF POLE. COORDINATE EXACT MOUNTING HEIGHT AND ORIENTATION OF POLE FACE CONTAINING RECEPTACLES WITH THE OWNER PRIOR TO INSTALLATION. BASIS OF DESIGN: WIREMOLD NP800C-10-2B OR EQUAL.
 4. PROVIDE (4) NEMA 5-20R RECEPTACLES IN POLE, CIRCUITS AS INDICATED.
 5. PROVIDE (5) NEMA 5-20R AND (1) NEMA 6-20R RECEPTACLES IN POLE, CIRCUITS AS INDICATED.
 6. INSTALL NEW RECEPTACLES IN EXISTING SURFACE MOUNTED RACEWAY.
 7. RE-CIRCUIT EXISTING RECEPTACLE AS INDICATED TO PROVIDE DEDICATED CIRCUIT.
 8. POWER FOR ENTRY-GUARD CONTROL PANEL. PROVIDE LOW VOLTAGE WIRING AND DOOR SENSOR SHOWN ON ARCHITECTURAL DRAWINGS. COORDINATE WITH KENTEK INSTALLATION INSTRUCTIONS.

1 Floor Plan Power - Second Level - South
1/4" = 1'-0"

Flad Architects
Facility Leaders in Architectural
Engineering Design, P.C.
201 West Avenue, Ste. 910
New York, NY 10014
Tel: 212-697-0000
Fax: 212-613-0000
www.flad.com

AEI
Affiliated Engineers, P.C.

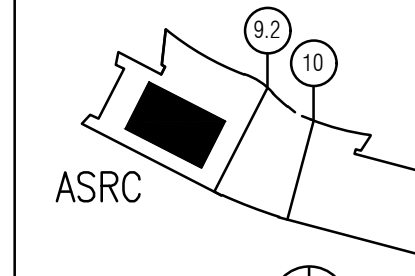

BY: _____

Rev	Date	Description of Issue
0	05/06/19	Construction Documents

Dormitory Authority
State Of New York
DASHNY Project Number - 257110
The City University of New York

**ASRC
Photonics Lab
Renovations**

**The City College
of New York**
85 St Nicholas Terrace
New York, NY 10027


DASHNY # 257110

Company Drawn By Affiliated Engineers	
Project Phase CONSTRUCTION DOCUMENTS	
Date 05/06/2019	Drawn By AEI
Flad Project Number 05432-82	Checked By AEI

**Floor Plan Power
Second Level
South**

Sheet Number
EP-221
NYC DOB Sheet Number

Page No.
Application No.
DOB BSCAM

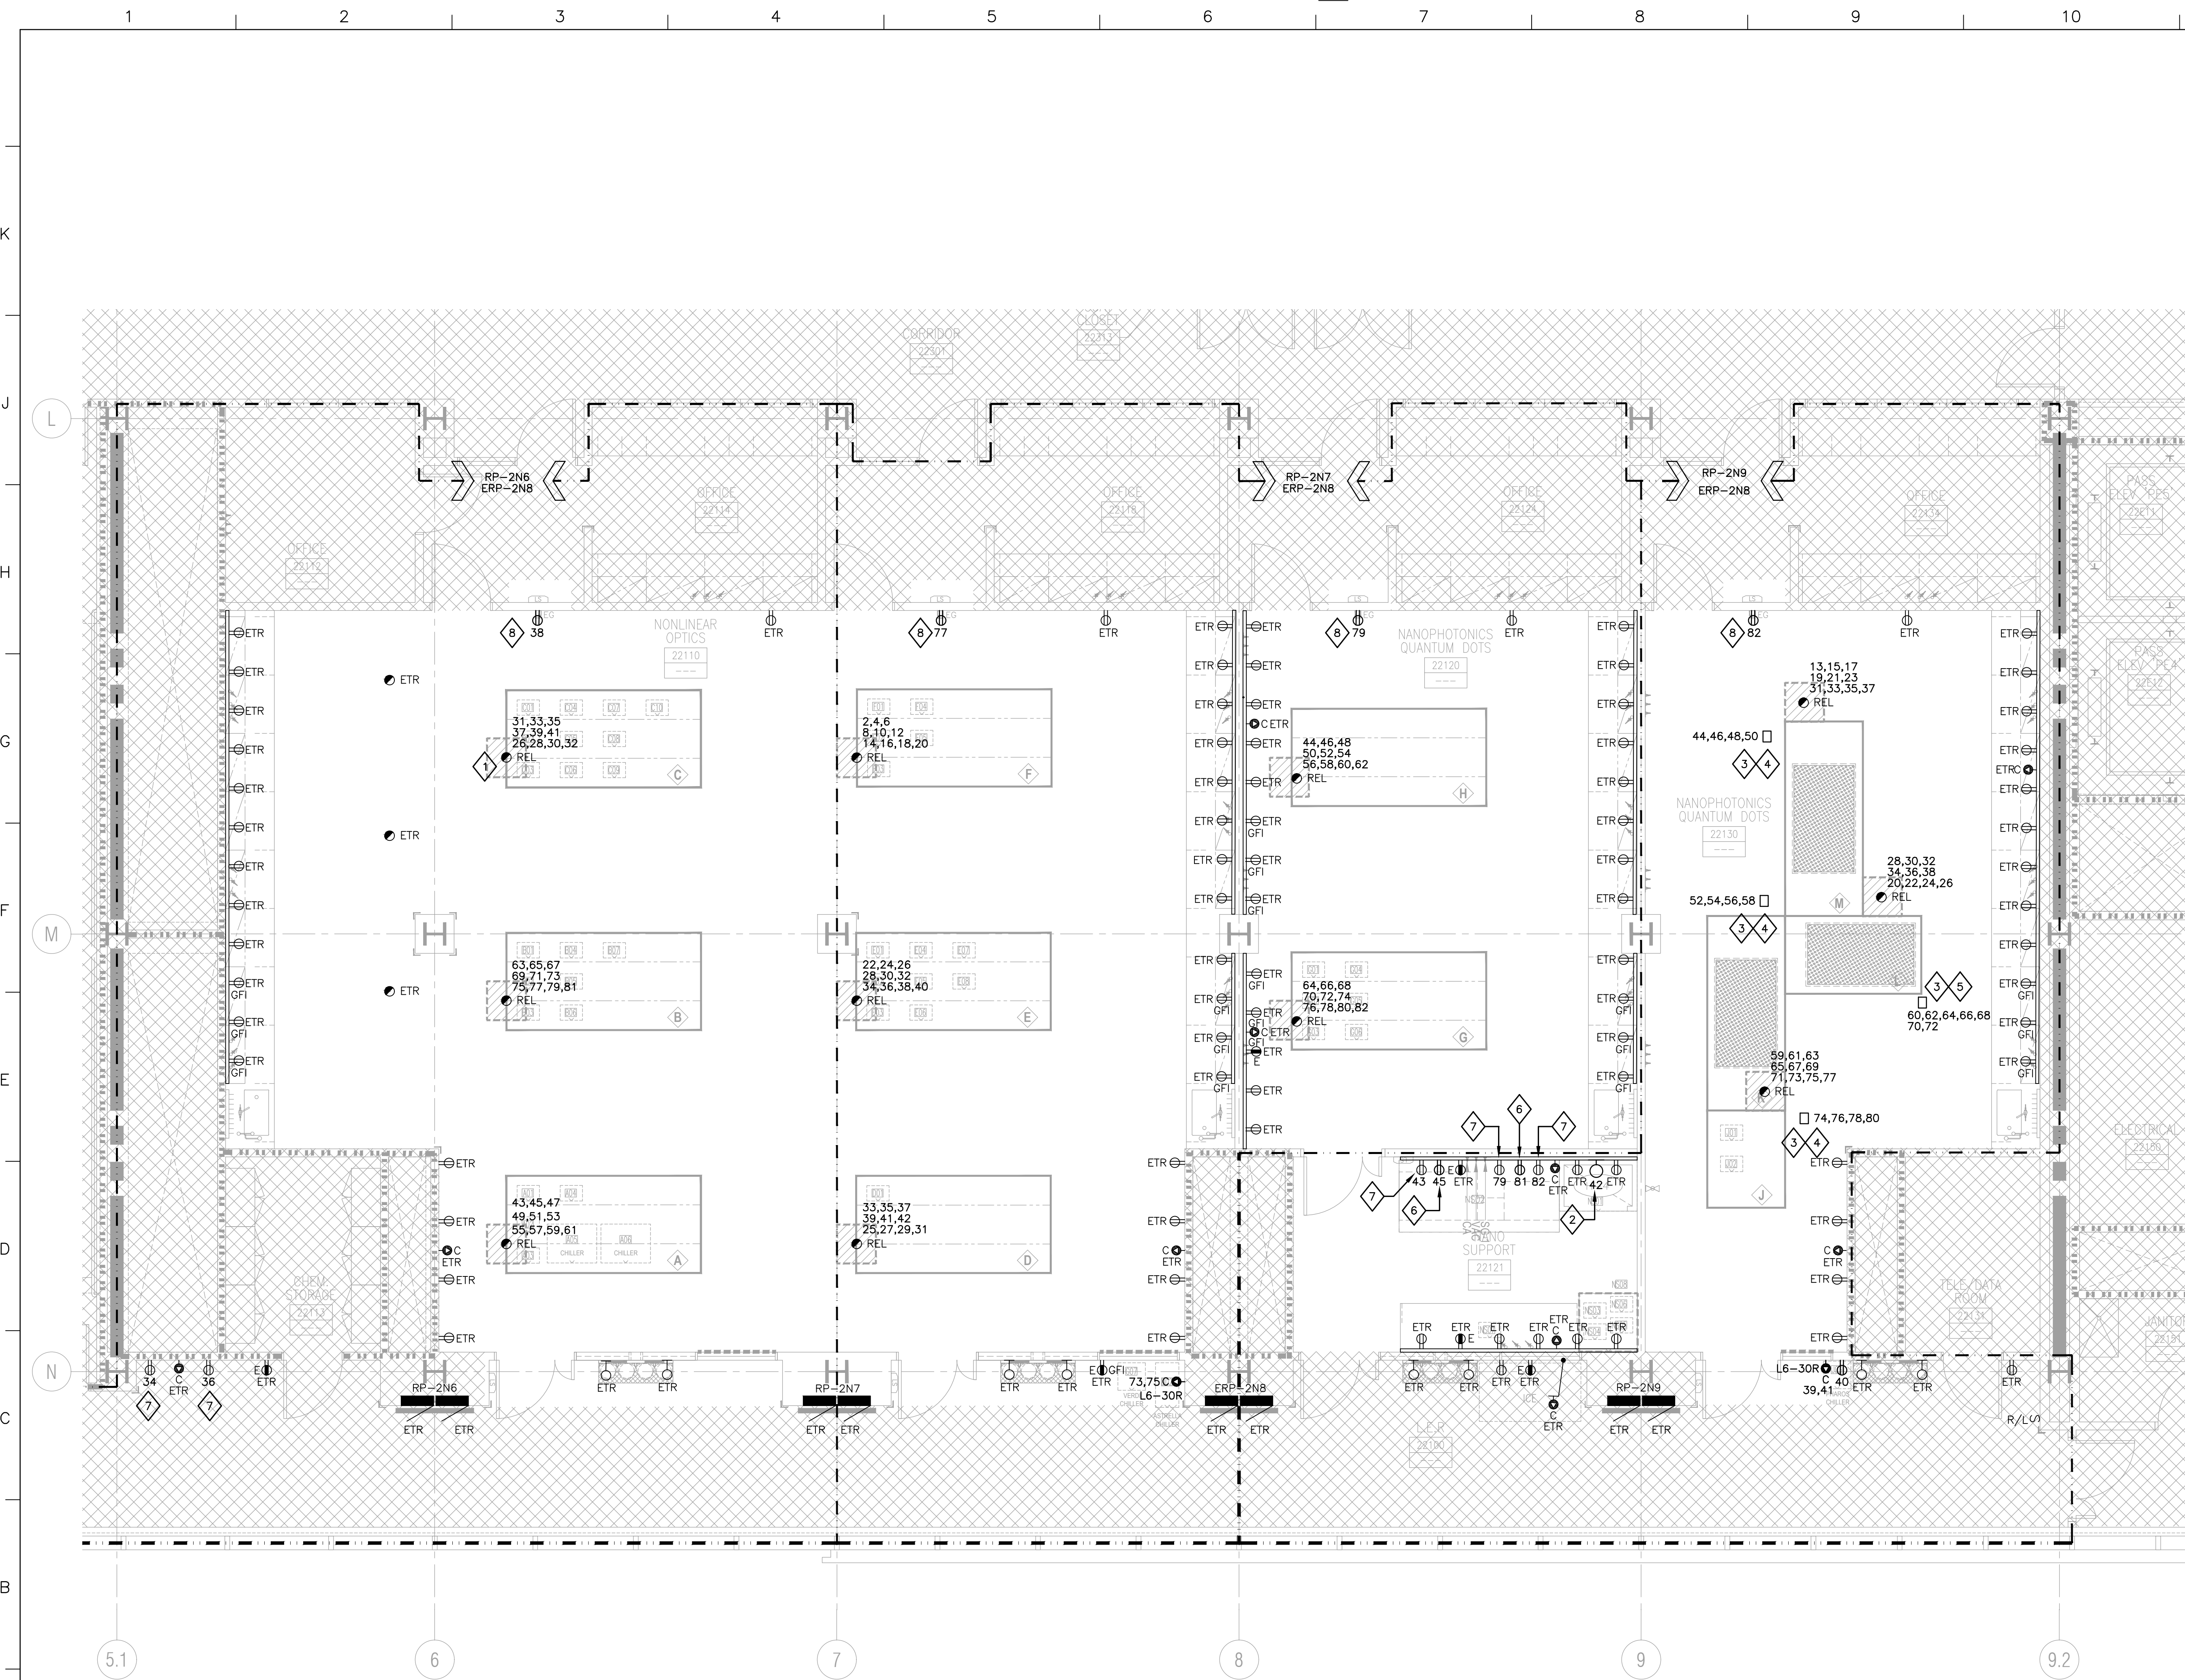


- GENERAL NOTES:**
- REFER TO SHEET E-000 FOR SYMBOLS AND ABBREVIATIONS.
 - CIRCUITING SHALL BE MAINTAINED TO DEVICES INDICATED AS EXISTING TO REMAIN. RELOCATE OR EXTEND EXISTING CONDUIT AND CONDUCTORS AS REQUIRED TO MAINTAIN CIRCUITING.
 - CIRCUIT NUMBERS INDICATE QUANTITY OF RECEPTACLES PER CIRCUIT.
 - REFER TO ARCHITECTURAL AND LAB ELEVATIONS FOR MOUNTING HEIGHT OF ABOVE COUNTER RECEPTACLES AND SURFACE MOUNTED RACEWAY.
 - PROVIDE GFI PROTECTION FOR RECEPTACLES LOCATED WITHIN 6' OF LABORATORY SINKS, WHETHER SHOWN ON PLAN OR NOT.
 - NUMBER ADJACENT TO POWER CONNECTION SYMBOL IS INTENDED CIRCUIT NUMBER. REFER TO PANEL DIVISION LINES FOR SOURCE PANELBOARD.
 - ALL 120V, 20A BRANCH CIRCUITS IN LABS SHALL HAVE A DEDICATED NEUTRAL UNLESS NOTED OTHERWISE.
 - PROVIDE 120V POWER CONNECTION TO FIRE/SMOKE DAMPER CONTROL TRANSFORMER. CIRCUIT TO 20/1 BREAKER IN NEAREST 208V LIFE SAFETY PANEL. REFER TO M-SERIES DRAWINGS FOR DAMPER LOCATION. PROVIDE 1 CIRCUIT FOR UP TO 10 DAMPERS.

- SHEET KEYNOTES:**
- TYPICAL: CEILING SERVICE PANEL RELOCATED FROM SECOND FLOOR. PROVIDE (6) 120V, 20A AND (2) 208V, 1 PHASE, 30A CIRCUITS TO RECESSED CEILING SERVICE PANEL FOR POWER TO LASER TABLE. ELECTRICAL CONTRACTOR SHALL INSTALL (1) RECEPTACLE PER CIRCUIT AND (2) DATA CABLE CONNECTIONS TO EXISTING JACKS IN EACH DATA BACKBOX IN CEILING SERVICE PANEL. RECEPTACLES FACE PLATES AND SERVICE PANELS ARE PROVIDED BY LAB EQUIPMENT SUPPLIER.
 - PROVIDE A 120V HARDWIRE CONNECTION TO FUME HOOD. COORDINATE EXACT LOCATION OF HARDWIRE CONNECTION WITH FUME HOOD CONTRACTOR PRIOR TO INSTALL.
 - PROVIDE BLANK ALUMINIUM TWO-COMPARTMENT POLE WITH CAPACITY FOR UP TO A 60A DEVICE OR UP TO 12 RECEPTACLES. MINIMUM HEIGHT 10'-2" TO EXTEND ABOVE SUSPENDED CEILING. MOUNT RECEPTACLES ON LOWER HALF OF POLE. COORDINATE EXACT MOUNTING HEIGHT AND ORIENTATION OF POLE FACE CONTAINING RECEPTACLES WITH THE OWNER PRIOR TO INSTALLATION. BASIS OF DESIGN: WIREMOLD NP800C-10-2B OR EQUAL.
 - PROVIDE (4) NEMA 5-20R RECEPTACLES IN POLE, CIRCUITS AS INDICATED.
 - PROVIDE (5) NEMA 5-20R AND (1) NEMA 6-20R RECEPTACLES IN POLE, CIRCUITS AS INDICATED.
 - INSTALL NEW RECEPTACLES IN EXISTING SURFACE MOUNTED RACEWAY.
 - RE-CIRCUIT EXISTING RECEPTACLE AS INDICATED TO PROVIDE DEDICATED CIRCUIT.
 - POWER FOR ENTRY-GUARD CONTROL PANEL. PROVIDE LOW VOLTAGE WIRING AND DOOR SENSOR SHOWN ON ARCHITECTURAL DRAWINGS. COORDINATE WITH KENTEK INSTALLATION INSTRUCTIONS.

1 Floor Plan Power - Second Level - South
1/4" = 1'-0"

Flad Architects
Facility Leaders in Architectural
Engineering Design, P.C.
201 West Avenue, Ste. 910
New York, NY 10014
Tel: 212-697-0000
Fax: 212-613-0000
www.flad.com

AEI
Affiliated Engineers, P.C.

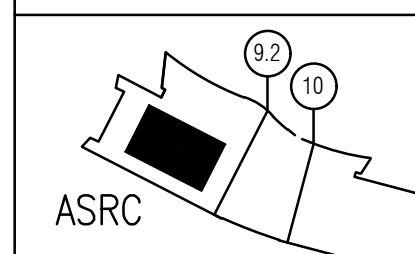

KEY PLAN

BY: _____

Rev	Date	Description of Issue
0	05/06/19	Construction Documents

Dormitory Authority
State Of New York
DASHY Project Number - 257110
The City University of New York

**ASRC
Photonics Lab
Renovations**

**The City College
of New York**

85 St Nicholas Terrace
New York, NY 10027

DASHY # 257110

Scale

Company Drawn By
Affiliated Engineers

Project Phase
CONSTRUCTION DOCUMENTS

Date 05/06/2019	Drawn By AEI
Flad Project Number 05432-82	Checked By AEI

Sheet Title
**Floor Plan Power
Second Level
South**

Sheet Number
EP-221

NYC DOB Sheet Number

Page No.

Application No.

DOB BSCAM

PANEL: RP-BK16		SECT.: 1	MTG.: SURFACE									
VOLTS: 120/208V		PHASE: 3	WIRES: 4									
MAIN C.B.: 225 AMP		GND.: GROUND BUS										
MAIN BUS: 225 AMP		MINIMUM INTERRUPTING RATING: 22,000A*										
CKT. No.	TRIP (Amps)	DESCRIPTION OF LOAD	Category	Load (Va)	Per Phase (Va)			Load (Va)	Category	DESCRIPTION OF LOAD	Trip (Amps)	Ckt. No.
					A	B	C					
1	20	RECEPS RM 0772A	R	720	1080			360	R	RECEPS RM 00614A, 00614B	20	2
3	20	RECEPS RM 0772A	R	540		900		360	R	RECEPS 00614B	20	4
5	20	RECEPS RM 00614A	R	720			1260	540	R	RECEPS 00614B	20	6
7	20	RECEPS RM 00614A	R	720	900			180	R	CLG SERVICE PNL 00614A L5-20R	20	8
9	20	RECEPS 00614B	R	360		540		180	R	CLG SERVICE PNL 00614A L5-20R	20	10
11	20	RECEPS 00614B	R	540			720	180	R	CLG SERVICE PNL 00614A L5-20R	20	12
13	20	CLG SERVICE PNL 00614A L5-20R	R	180	360			180	R	CLG SERVICE PNL 00614A L5-20R	20	14
15	20	CLG SERVICE PNL 00614A L5-20R	R	180		360		180	R	CLG SERVICE PNL 00614A L5-20R	20	16
17	20	CLG SERVICE PNL 00614A L5-20R	R	180			360	180	R	CLG SERVICE PNL 00614A L5-20R	20	18
19	20	CLG SERVICE PNL 00614A L5-20R	R	180	2680			2500	R	CLG SERVICE PNL 00614A L6-30R	30	20
21	20	CLG SERVICE PNL 00614A L5-20R	R	180		2680		2500	R	CLG SERVICE PNL 00614A L6-30R	30	22
23	20	CLG SERVICE PNL 00614A L5-20R	R	180			2680	2500	R	CLG SERVICE PNL 00614A L6-30R	30	24
25	30	CLG SERVICE PNL 00614A L6-30R	R	2500	5000			2500	R	CLG SERVICE PNL 00614A L6-30R	30	26
27	30	CLG SERVICE PNL 00614A L6-30R	R	2500		5000		2500	R	208V RECEP RM 00614B	30	28
29	30	CLG SERVICE PNL 00614A L6-30R	R	2500			5000	2500	R		30	30
31	30	CLG SERVICE PNL 00614A L6-30R	R	2500	5000			2500	R	ANECHOIC CHAMBER POWER 208V	30	32
33	20	GAS MANIFOLD	O	180		2680		2500	R		30	34
35	20	SPARE					2500	2500	R	ANECHOIC CHAMBER POWER 208V	30	36
37	20	SPARE			2500			2500	R		30	38
39	20	SPARE				720		720	R	ANECHOIC CHAMBER POWER	20	40
41	20	SPARE					1116	1116	O	ANECHOIC CHAMBER LIGHTING	20	42
					17520	12880	13636					
TOTAL CONNECTED LIGHTING LOAD (KVA):				0.00								
TOTAL CONNECTED RECEPTACLE LOAD (KVA):				42.74								
TOTAL CONNECTED OTHER LOAD (KVA):				1.30	*CONFIRM MINIMUM INTERRUPTING RATING AS OUTLINED IN SPECIFICATION SECTION 260573							
TOTAL CONNECTED LOAD (KVA):				44.04								
TOTAL DEMAND LOAD (KVA):				27.67								
TOTAL DEMAND LOAD (AMPS):				76.85								

PANEL: RP-2N6-L		SECT.: 1	MTG.: RECESSED									
VOLTS: 120/208V		PHASE: 3	WIRES: 4									
MAIN C.B.: 225 AMP		GND.: GROUND BUS										
MAIN BUS: 225 AMP		MINIMUM INTERRUPTING RATING: 22,000A*										
CKT. No.	TRIP (Amps)	DESCRIPTION OF LOAD	Category	Load (Va)	Per Phase (Va)			Load (Va)	Category	DESCRIPTION OF LOAD	Trip (Amps)	Ckt. No.
					A	B	C					
1	20	RECEPS RM 2112	R	540	3036			2496	R	208V RECEP LER 22100	30	2
3	20	RECEPS RM 2112	R	540		3036		2496	R		30	4
5	20	RECEPS RM 2112	R	360			2856	2496	R	208V RECEP RM 22110	30	6
7	20	RECEPS RM 22110	R	720	3216			2496	R		20	8
9	20	RECEPS RM 22110	R	720		1440		720	R	OVERHEAD SERVICE PANEL RM 22110	20	10
11	20	RECEPS RM 22110	R	720			1440	720	R		20	12
13	20	RECEPS RM 22110 & LER 22100	R	540	1260			720	R		20	14
15	20	RECEPS RM 22110 & LER 22100	R	540		1260		720	R		20	16
17	20	RECEPS RM 22114 & 22110	R	540			1260	720	R	OVERHEAD SERVICE PANEL RM 22110	20	18
19	20	RECEPS RM 22114 & 22110	R	540	1260			720	R		20	20
21	20	RECEPS RM 22114 & 22110	R	540		1260		720	R		20	22
23	30	208V RECEP RM 22112	R	2496			3216	720	R		20	24
25	30		R	2496	4996			2500	R	CLG SERVICE PNL 22110 L6-30R	30	26
27	30	208V RECEP RM 22112	R	2496		4996		2500	R		28	
29	30		R	2496			4996	2500	R	CLG SERVICE PNL 22110 L6-30R	30	30
31	20	CLG SERVICE PNL 22110 L5-20R	R	180	2680			2500	R		32	
33	20	CLG SERVICE PNL 22110 L5-20R	R	180		1080		900	O	LER 22100 CHILLER A05	20	34
35	20	CLG SERVICE PNL 22110 L5-20R	R	180			1080	900	O	LER 22100 CHILLER A06	20	36
37	20	CLG SERVICE PNL 22110 L5-20R	R	180	420			240	O	ENTRY-GUARD PWR	20	38
39	20	CLG SERVICE PNL 22110 L5-20R	R	180		180				SPARE	20	40
41	20	CLG SERVICE PNL 22110 L5-20R	R	180			180			SPARE	20	42
					16868	13252	15028					
TOTAL CONNECTED LIGHTING LOAD (KVA):				0.00								
TOTAL CONNECTED RECEPTACLE LOAD (KVA):				43.11								
TOTAL CONNECTED OTHER LOAD (KVA):				2.04								
TOTAL CONNECTED LOAD (KVA):				45.15								
TOTAL DEMAND LOAD (KVA):				28.59								
TOTAL DEMAND LOAD (AMPS):				79.43								


PANEL: RP-2N6-R		SECT.: 2	MTG.: RECESSED									
VOLTS: 120/208V		PHASE: 3	WIRES: 4									
MAIN C.B.: 225 AMP		GND.: GROUND BUS										
MAIN BUS: 225 AMP		MINIMUM INTERRUPTING RATING: 22,000A*										
CKT. No.	TRIP (Amps)	DESCRIPTION OF LOAD	Category	Load (Va)	Per Phase (Va)			Load (Va)	Category	DESCRIPTION OF LOAD	Trip (Amps)	Ckt. No.
					A	B	C					
43	20	CLG SERVICE PNL 22110 L5-20R	R	180	2676			2496	R	208V RECEP RM 22114	30	44
45	20	CLG SERVICE PNL 22110 L5-20R	R	180		2676		2496	R		30	46
47	20	CLG SERVICE PNL 22110 L5-20R	R	180			900	720	R	OVERHEAD SERVICE PANEL RM 22110	20	48
49	20	CLG SERVICE PNL 22110 L5-20R	R	180	900			720	R		20	50
51	20	CLG SERVICE PNL 22110 L5-20R	R	180		900		720	R		20	52
53	20	CLG SERVICE PNL 22110 L5-20R	R	180			900	720	R		20	54
55	30	CLG SERVICE PNL 22110 L6-30R	R	2500	3220			720	R	OVERHEAD SERVICE PANEL RM 22110	20	56
57	30		R	2500		3220		720	R		20	58
59	30	CLG SERVICE PNL 22110 L6-30R	R	2500			3220	720	R		20	60
61	30		R	2500	3220			720	R		20	62
63	20	CLG SERVICE PNL 22110 L5-20R	R	180		180				SPARE	20	64
65	20	CLG SERVICE PNL 22110 L5-20R	R	180			180			SPARE	20	66
67	20	CLG SERVICE PNL 22110 L5-20R	R	180	180					SPARE	20	68
69	20	CLG SERVICE PNL 22110 L5-20R	R	180		180				SPARE	20	70
71	20	CLG SERVICE PNL 22110 L5-20R	R	180			180			SPARE	20	72
73	20	CLG SERVICE PNL 22110 L5-20R	R	180	180					SPARE	20	74
75	30	CLG SERVICE PNL 22110 L6-30R	R	2500		2500				SPARE	20	76
77	30		R	2500			2500			SPARE	20	78
79	30	CLG SERVICE PNL 22110 L6-30R	R	2500	2500					SPARE	20	80
81	30		R	2500		2500				SPARE	20	82
83	20	SHADES	O	432			432			SPARE	20	84
					12876	12156	8312					
TOTAL CONNECTED LIGHTING LOAD (KVA):				0.00								
TOTAL CONNECTED RECEPTACLE LOAD (KVA):				32.91								
TOTAL CONNECTED OTHER LOAD (KVA):				0.43								
TOTAL CONNECTED LOAD (KVA):				33.34								
TOTAL DEMAND LOAD (KVA):				21.89								
TOTAL DEMAND LOAD (AMPS):				60.80								

GENERAL NOTES:
1. REFER TO SHEET E-000 FOR SYMBOLS AND ABBREVIATIONS.
2. ALL PANELS, CIRCUITS, AND BREAKERS ARE EXISTING TO REMAIN UNLESS NOTED OTHERWISE.

SHEET KEYNOTES:
1. PROVIDE NEW LOAD ON EXISTING CIRCUIT UNLOADED DURING DEMOLITION.
2. PROVIDE NEW LOAD ON EXISTING SPARE CIRCUIT.
3. PROVIDE NEW BREAKER FOR NEW LOAD.
4. PROVIDE NEW PANELBOARD, REFER TO SHEET E-403 FOR PARTIAL ONE-LINE DIAGRAM.

Flad Architects
Facility Leaders in Architectural Engineering Design, PC
201 Park Avenue, Ste. 910
New York, NY 10022
Tel: 212-697-0000
Fax: 212-697-0000
www.flad.com

AEI
Affiliated Engineers, P.C.



0 05/06/19 Construction Documents

Rev	Date	Description of Issue

Project Title


ASRC Photonics Lab Renovations

The City College of New York
85 St Nicholas Terrace
New York, NY 10027

DASHY # 257110

Scale

Company Drawn By
Affiliated Engineers

Project Phase
CONSTRUCTION DOCUMENTS

Date 05/06/2019 Drawn By AEI
Flad Project Number 05432-82 Checked By AEI

Sheet Title
Electrical Panel Schedules


Sheet Number
E-400

NYC DOB Sheet Number

Page No.

Application No.

DOB BSCAN

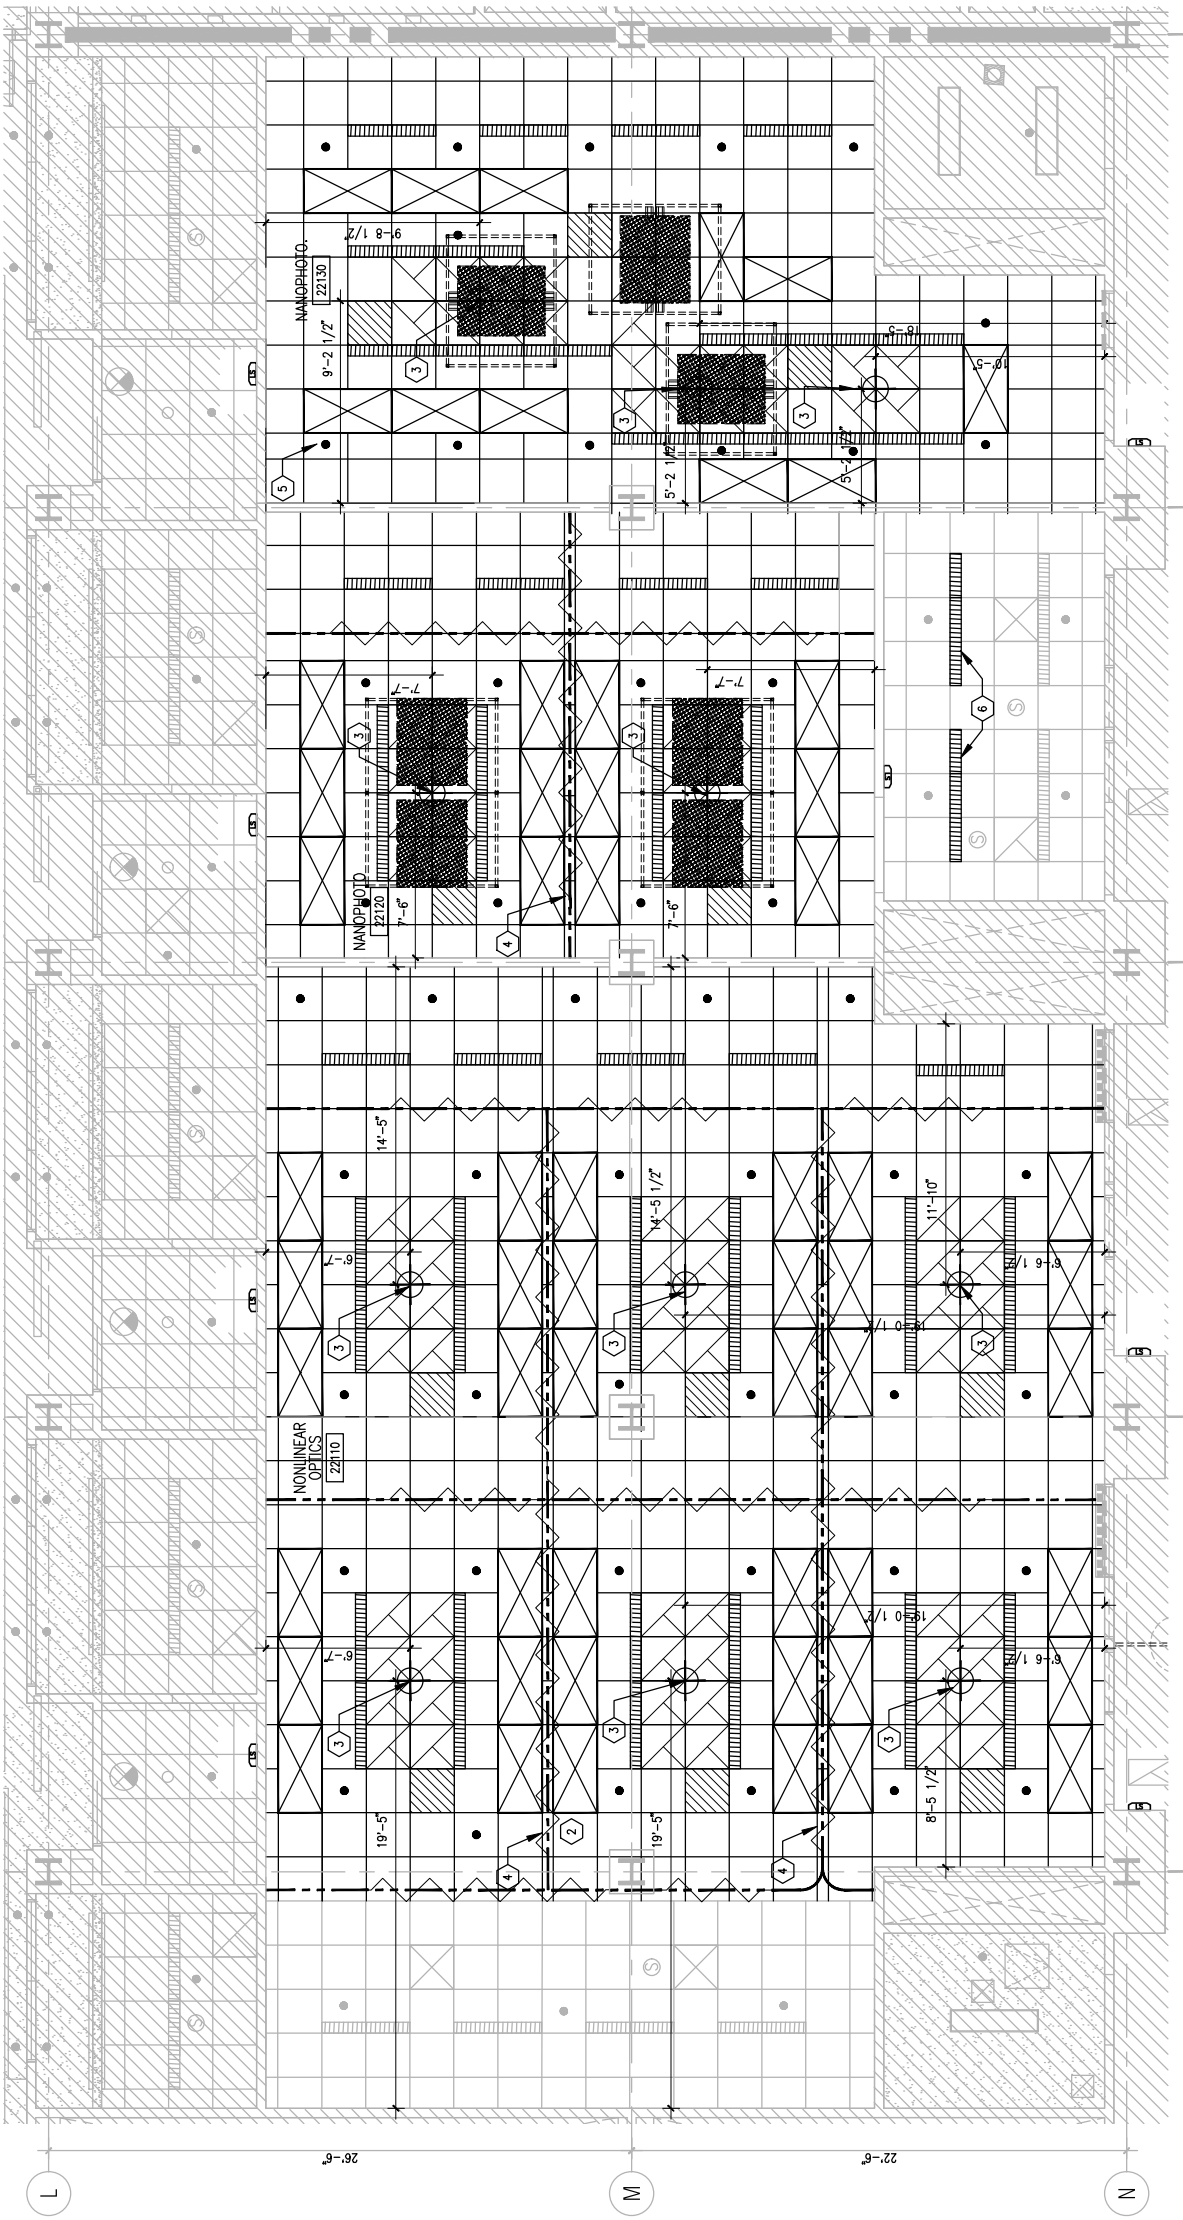

1 REFLECTED CEILING PLAN - LEVEL 2 - SOUTH
 1/4" = 1'-0"

0.1' 5' 10'
 1/4" = 1'-0"

RCP NOTES

- ALL ACT IN-PLAN CEILINGS TO BE ACT-2, 10'-0" AFF. UNDO.
- REFER TO ELEC. SCHEDULE DRAWINGS FOR TYPE & QUANTITY OF FIXTURES & DEVICES AS WELL AS FOR DEVICES NOT DIMENSIONED.
- LIGHTS, SPRINKLER HEADS, SENSORS AND OTHER CEILING MOUNTED DEVICES TO BE CENTERED IN CEILING TILE UNDO.
- VERIFY SIZE, LOCATION, & QUANTITY OF ACCESS PANELS WITH MECHANICAL CONTRACTOR AND CONFIRM LOCATION WITH ARCHITECT
- COORDINATE CEILING PENETRATION FOR LAB EQUIPMENT WITH MECHANICAL DRAWINGS
- MIDDLE GRID OR MIDDLE ACT TILE TO BE CENTERED ON ROOM DIMENSIONS, UNDO.
- ALL EMERGENCY LIGHT LOCATIONS ARE INDICATED GRAPHICALLY. REFER TO ELECTRICAL PLANS FOR FIXTURE TYPE AND DIRECTION ACCORDING TO LIFE SAFETY DRAWINGS.
- REFER TO Q-SERIES FOR TASK LIGHTING LOCATIONS AT LAB CASEWORK. REFER TO ELEC. FOR CASEWORK TASK LIGHTING FIXTURE SPECS.
- ALL HEADERS NOT IDENTIFIED WITH HEIGHT AFF TO BE 8'-0" TO MATCH DOOR HEIGHT UNDO.

KEYNOTES

- POINT EXHAUST CONNECTION
- LASER SAFETY CURTAIN. INSTALL WALL TO WALL WITH SEALS ON BOTH SIDES. SEE DETAIL 1/AE-501. REFER TO SPEC FOR ADDITIONAL PRODUCT DETAILS.
- START POINT - START CEILING FROM THIS LOCATION. STOP WHEN REACHING A CUT TILE AND BEGIN FROM OTHER START POINT. ONCE MEETING IN MIDDLE, CUT TILE ACCORDING TO FIELD CONDITION.
- CUT TILE 1/2"
- CUT TILE 1/4"
- RELOCATED LIGHT FIXTURES - SEE ELECTRICAL LIGHTING DRAWINGS.
- SUSPENDED OVERHEAD SHELVING TYPE 'A'. CENTERED WITHIN CEILING ARRANGEMENT (LIGHT FIXTURES AND DIFFUSERS) OVER LASER TABLE. SEE DETAIL 1/AE-502.
- SUSPENDED OVERHEAD SHELVING TYPE 'B'. CENTERED WITHIN CEILING ARRANGEMENT (LIGHT FIXTURES AND DIFFUSERS) OVER LASER TABLE. SEE DETAIL 2/AE-502.

LEGENDS


- ACT (ACOUSTICAL) CEILING TILE
- EXPOSED
- SUSPENDED PERFORATED METAL SHELVING
- 1X4 FLUORESCENT LIGHT FIXTURE
- 2X4 FLUORESCENT LIGHT FIXTURE
- RECESSED LIGHT FIXTURE
- SUSPENDED LIGHT FIXTURE
- DOWN LIGHT FIXTURE
- LASER SAFETY CURTAIN. SEE KEYNOTE #2
- LASER SAFETY SHADE
- WALL MOUNTED, ILLUMINATED LASER SAFETY SIGN

- CEILING DIFFUSER
- CEILING DIFFUSER
- AIR RETURN GRILL
- ACCESS PANEL
- WALL ACCESS PANEL
- LINEAR DIFFUSER
- 2X2 CEILING SERVICE PANEL
- 2X4 EXHAUST HOOD
- POINT EXHAUST
- SS SAFETY SHOWER
- UMBRELLA
- SPRINKLER HEAD

- EXT. LIGHT-CEILING MOUNTED (REFER TO ELEC.)
- EXT. LIGHT-WALL MOUNTED (REFER TO ELEC.)
- OCCUPANCY SENSOR-CEILING MOUNTED
- SMOKE DETECTOR (REFER TO ELEC.)
- SECURITY CAMERA
- SPEAKER (AV)
- CEILING MOUNT WIRELESS ACCESS DEVICE (REFER TO ELEC.)
- CEILING CONTROL JOINT

- LINE TYPE LEGEND**
- NEW WORK
 - EXISTING TO REMAIN
 - EXISTING TO BE REMOVED
 - NOT IN SCOPE

Rev	Date	Description of Issue
0	05/06/19	CONSTRUCTION DOCUMENTS

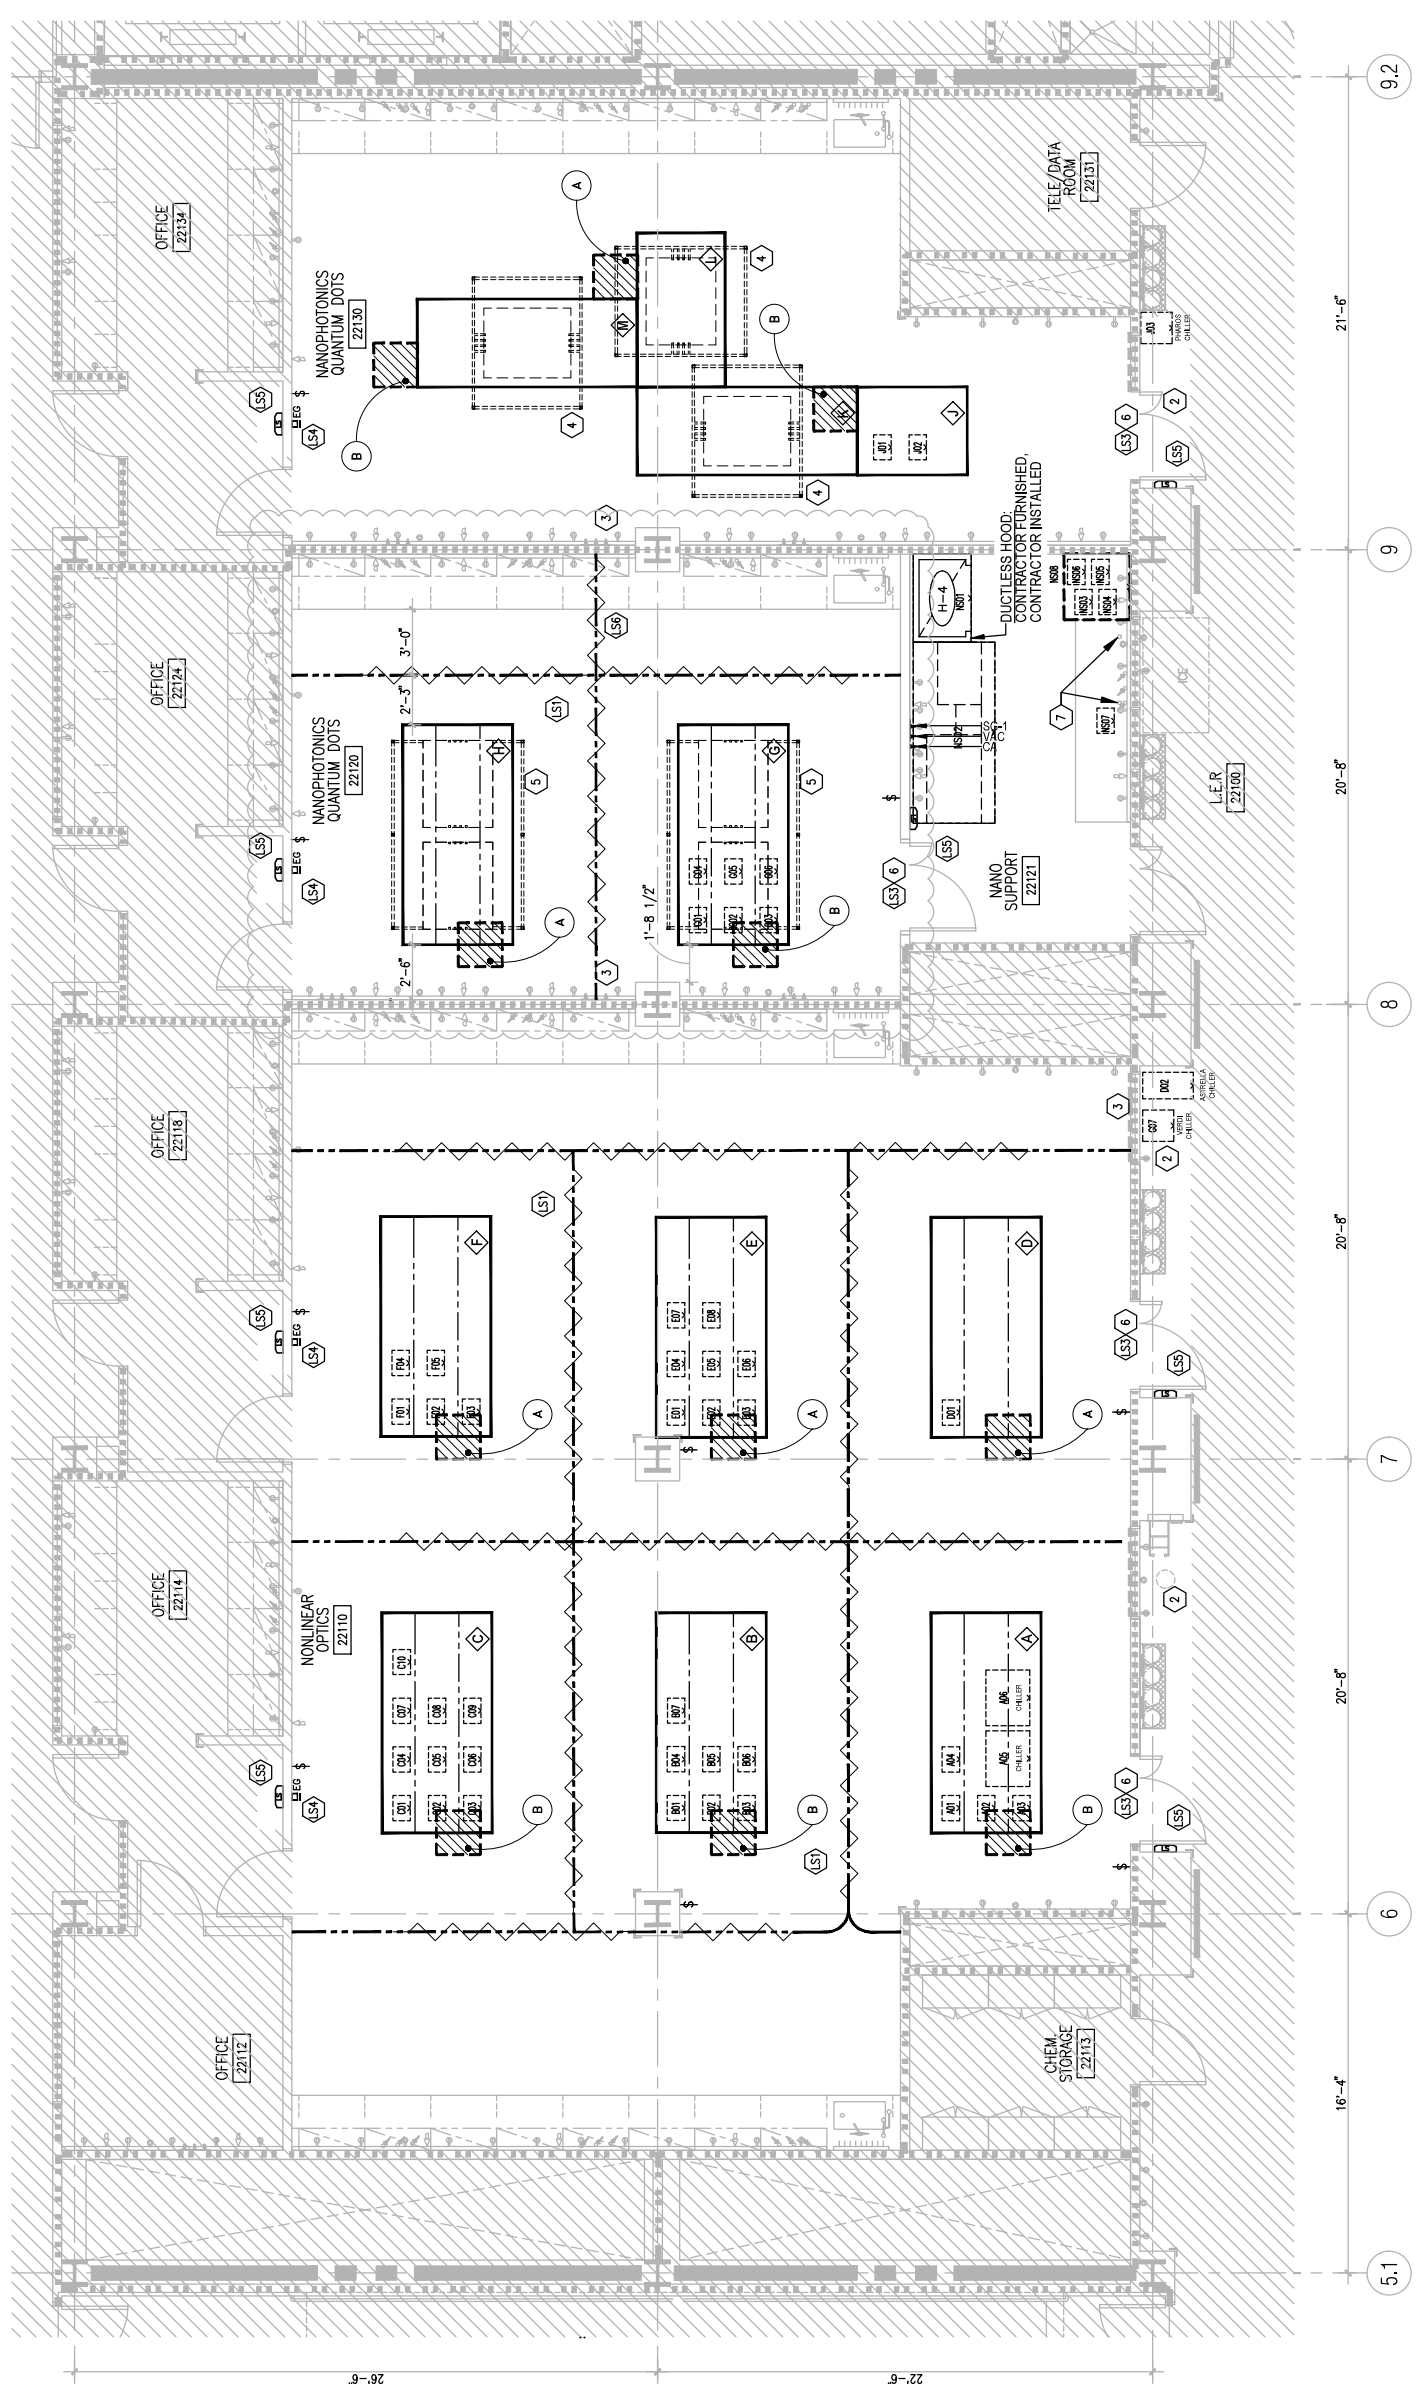

1 LABORATORY PLAN - LEVEL 2 - SOUTH
 1/4" = 1'-0"

GENERAL NOTES

- NOTES:
- ALL LABORATORY CASEWORK IS EXISTING TO REMAIN U.O.A.
 - LASER AIR TABLES A, THROUGH W PROVIDED BY OWNER.
 - EXISTING LASER IN USE ILLUMINATED SENS IN L.E.R. TO BE REMOVED AND REPLACED WITH NEW STATUS ILLUMINATED SEN. INSTALL NEW SEN AT EXISTING SEN LOCATION TO REUSE EXISTING JUNCTION BOX AND WIRING.
 - NEW DUAL-STATUS ILLUMINATED SEN IN OFFICE VESTIBLES WILL BE INSTALLED AT JUNCTION BOX PROVIDED DURING CONSTRUCTION BULLETIN 2.
 - SEE RCP FOR LASER SAFETY CURTAIN LOCATION AND COORDINATION WITH EXISTING CURTAIN AND MECHANICAL SYSTEMS. CAPTION DIMENSIONS FOR REFERENCE ONLY.

KEYNOTES

- PLAN KEYNOTES:
- NOT USED
 - SEE ELECTRICAL AND PLUMBING DRAWINGS FOR COORDINATION OF LOCAL CHILLERS.
 - PROVIDE 2" DIAMETER THROUGH-WALL CONDUIT FOR FUTURE FIBER OPTIC CABLE. SEE DETAIL 8/AE-500.
 - SUSPENDED OVERHEAD SHELVING TYPE 'A'. SEE DETAIL 1/AE-502.
 - PROVIDE ASTRAHAL SEAL TO EXISTING DOOR PANELS.
 - PROVIDE GROMMET FOR EACH WORKSTATION, 2" DIAMETER.

- LASER SAFETY KEYNOTES:
- CEILING MOUNTED LASER SAFETY CURTAIN AND TRACK. (INCLUDING LASER IN USE ILLUMINATED SIGNAGE, CURTAIN POSITION SENSORS AND AREA CONTROL MODULE)
 - NOT USED
 - REPAIR / INSTALL LASER SAFETY WINDOW BLOCK / CURTAIN ON L.E.R. DOOR GLAZING
 - LASER EQUIPMENT CONTROL MODULE AND DISCONNECT
 - LASER IN USE ILLUMINATED STATUS SIGNAGE CONNECTED TO EXISTING ELECTRICAL BOX (SEE ELECTRICAL DRAWINGS)
 - TAILORED CURTAIN TO MATCH PROFILE OF EXISTING LASER WORK NECESSARY TO PROVIDE LIGHT BLOCKING CURTAIN INSTALLATION WHEN PARED WITH APPROVED CLOSURE (W/ VELCRO). INSTALL CONTINUOUS CLOSURE AT FULL VERTICAL PROFILE ENGAGED BY CURTAIN. INSTALL LASER RATED WINDOW BLOCKING ON GLAZED WALL CABINET DOORS WITHIN THE VERTICAL PLANE OF THE LASER CURTAIN AND TRACK.

LEGENDS

- LASER SAFETY CURTAIN AND CURTAIN TRACK
- LASER SAFETY SHADE / WINDOW BLOCK
 - DUAL-STATUS ILLUMINATED LASER SAFETY SEN
 - ENTRY GUARD CONTROL MODULE AND EMERGENCY EQUIPMENT SHUT-OFF
 - CONTROL FOR INDIVIDUAL LASER WORKSTATION LIGHTING. (SUGGESTED LOCATION, SEE ELECTRICAL DRAWINGS)
 - OPTICAL TABLE (M)
 - PHOTONICS EQUIPMENT TAG, SEE EQUIPMENT SCHEDULE.
 - SERVICE PANEL - SEE SCHEDULE ON SHEET AE-200

- LINE TYPE LEGEND
- NEW WORK
 - EXISTING TO REMAIN
 - EXISTING TO BE REMOVED
 - NOT IN SCOPE

Rev	Date	Description of Issue
0	05/06/19	CONSTRUCTION DOCUMENTS


Company	Drawn By	Scale
Flad Architects	KS	1/4" = 1'-0"

Date	Drawn By	Checked By
05/06/2019	KS	DH

Floor Project Number	Checked By
05-632-82	DH

Sheet Title	Sheet Number
Partial Reflected Ceiling Plan Level 2 - North	AB-222

MFC DDB Sheet Number	Page No.	Application No.	DDB ESD#N
A-322-00	5 OF 10		

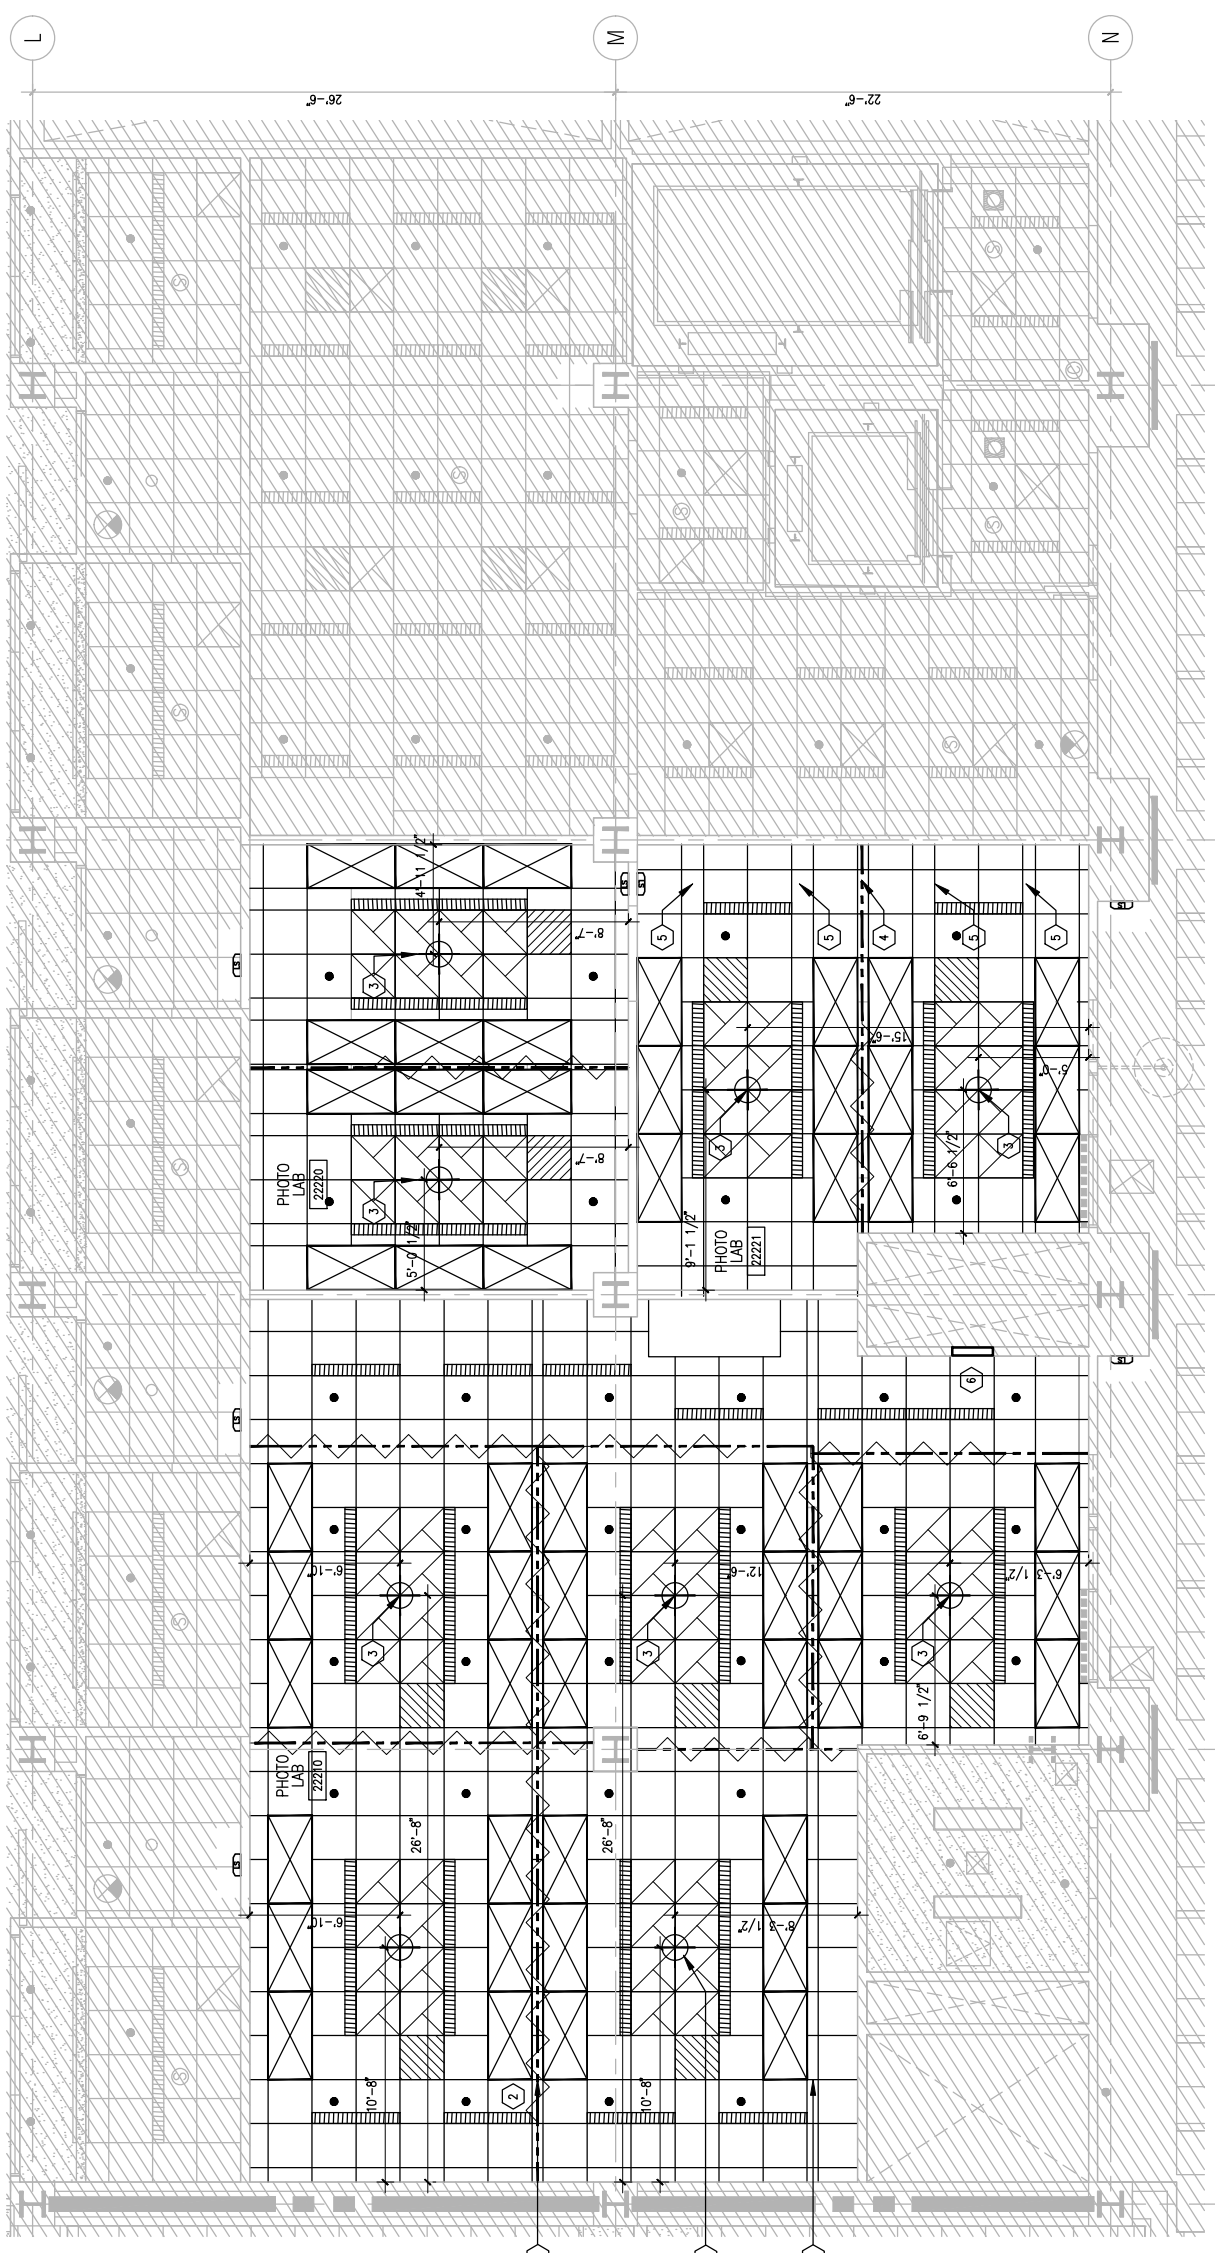

1 REFLECTED CEILING PLAN - LEVEL 2 - NORTH
 1/4" = 1'-0"

0.1'
 5'
 10'
 1/4" = 1'-0"

RCP NOTES

- ALL ACT LAY IN CEILINGS TO BE ACT-2, 10'-0" AFF. UNL.O.
- REFER TO ELEC. & MECH. DRAWINGS FOR TYPE & QUANTITY OF FIXTURES & DEVICES AS WELL AS FOR DEVICES NOT DIMENSIONED.
- LIGHTS, SPRINKLER HEADS, SENSORS AND OTHER CEILING MOUNTED DEVICES TO BE CENTERED IN CEILING TILE UNL.O.
- VERIFY SIZE, LOCATION, & QUANTITY OF ACCESS PANELS WITH MECHANICAL CONTRACTOR AND CONFIRM LOCATION WITH ARCHITECT
- COORDINATE CEILING PENETRATION FOR LAB EQUIPMENT WITH MECHANICAL DRAWINGS
- MIDDLE GRID OR MIDDLE ACT TILE TO BE CENTERED ON ROOM DIMENSIONS UNL.O.
- ALL EMERGENCY LIGHT LOCATIONS ARE INDICATED GRAPHICALLY. REFER TO ELECTRICAL PLANS FOR FIXTURE TYPE AND DIRECTION ACCORDING TO LIFE SAFETY DRAWINGS.
- REFER TO Q-SERIES FOR TASK LIGHTING LOCATIONS AT LAB CASEWORK. REFER TO ELEC. FOR CASEWORK TASK LIGHTING FIXTURE SPECS.
- ALL HEADERS NOT IDENTIFIED WITH HEIGHT AFF TO BE 8'-0" TO MATCH DOOR HEIGHT UNL.O.

KEYNOTES

- POINT EXHAUST CONNECTION
- LASER SAFETY CURTAIN. INSTALL WALL TO WALL WITH SEALS ON BOTH SIDES. SEE GENERAL SHEET AE-500. REFER TO SPEC FOR ADDITIONAL PRODUCT DETAILS
- START POINT - START CEILING FROM THIS LOCATION. STOP WHEN REACHING A 'CUT' TILE AND BEGIN FROM OTHER START POINT. ONCE MEETING IN MIDDLE, CUT TILE ACCORDING TO FIELD CONDITION.
- CUT TILE TO 6'
- CUT TILE W/F.
- 2-HOUR RATED SHAWTWALL AT FUME HOOD EXHAUST PENETRATION INSIDE CEILING - PARTITION TYPE P8. SEE SHEET AE-500.


LEGENDS

- ACT (ACOUSTICAL) CEILING TILE
- RECESSED LIGHT FIXTURE
- DOWN LIGHT FIXTURE
- LASER SAFETY CURTAIN. SEE KEYNOTE #2
- LASER SAFETY SHADE
- WALL MOUNTED, ILLUMINATED LASER SAFETY SIGN
- CEILING DIFFUSER
- AIR RETURN GRILL
- 2X2 CEILING SERVICE PANEL
- 2M EXHAUST HOOD
- POINT EXHAUST
- SPRINKLER HEAD

- EXT. LIGHT-CEILING MOUNTED (REFER TO ELEC.)
- EXT. LIGHT-WALL MOUNTED (REFER TO ELEC.)
- OCCUPANCY SENSOR-CEILING MOUNTED
- SMOKE DETECTOR (REFER TO ELEC.)
- SECURITY CAMERA
- SPEAKER (AV)
- CEILING MOUNT WIRELESS ACCESS DEVICE (REFER TO ELEC.)

- LINE TYPE LEGEND**
- NEW WORK
 - EXISTING TO REMAIN
 - EXISTING TO BE REMOVED
 - NOT IN SCOPE

Rev	Date	Description of Issue
0	05/06/19	CONSTRUCTION DOCUMENTS

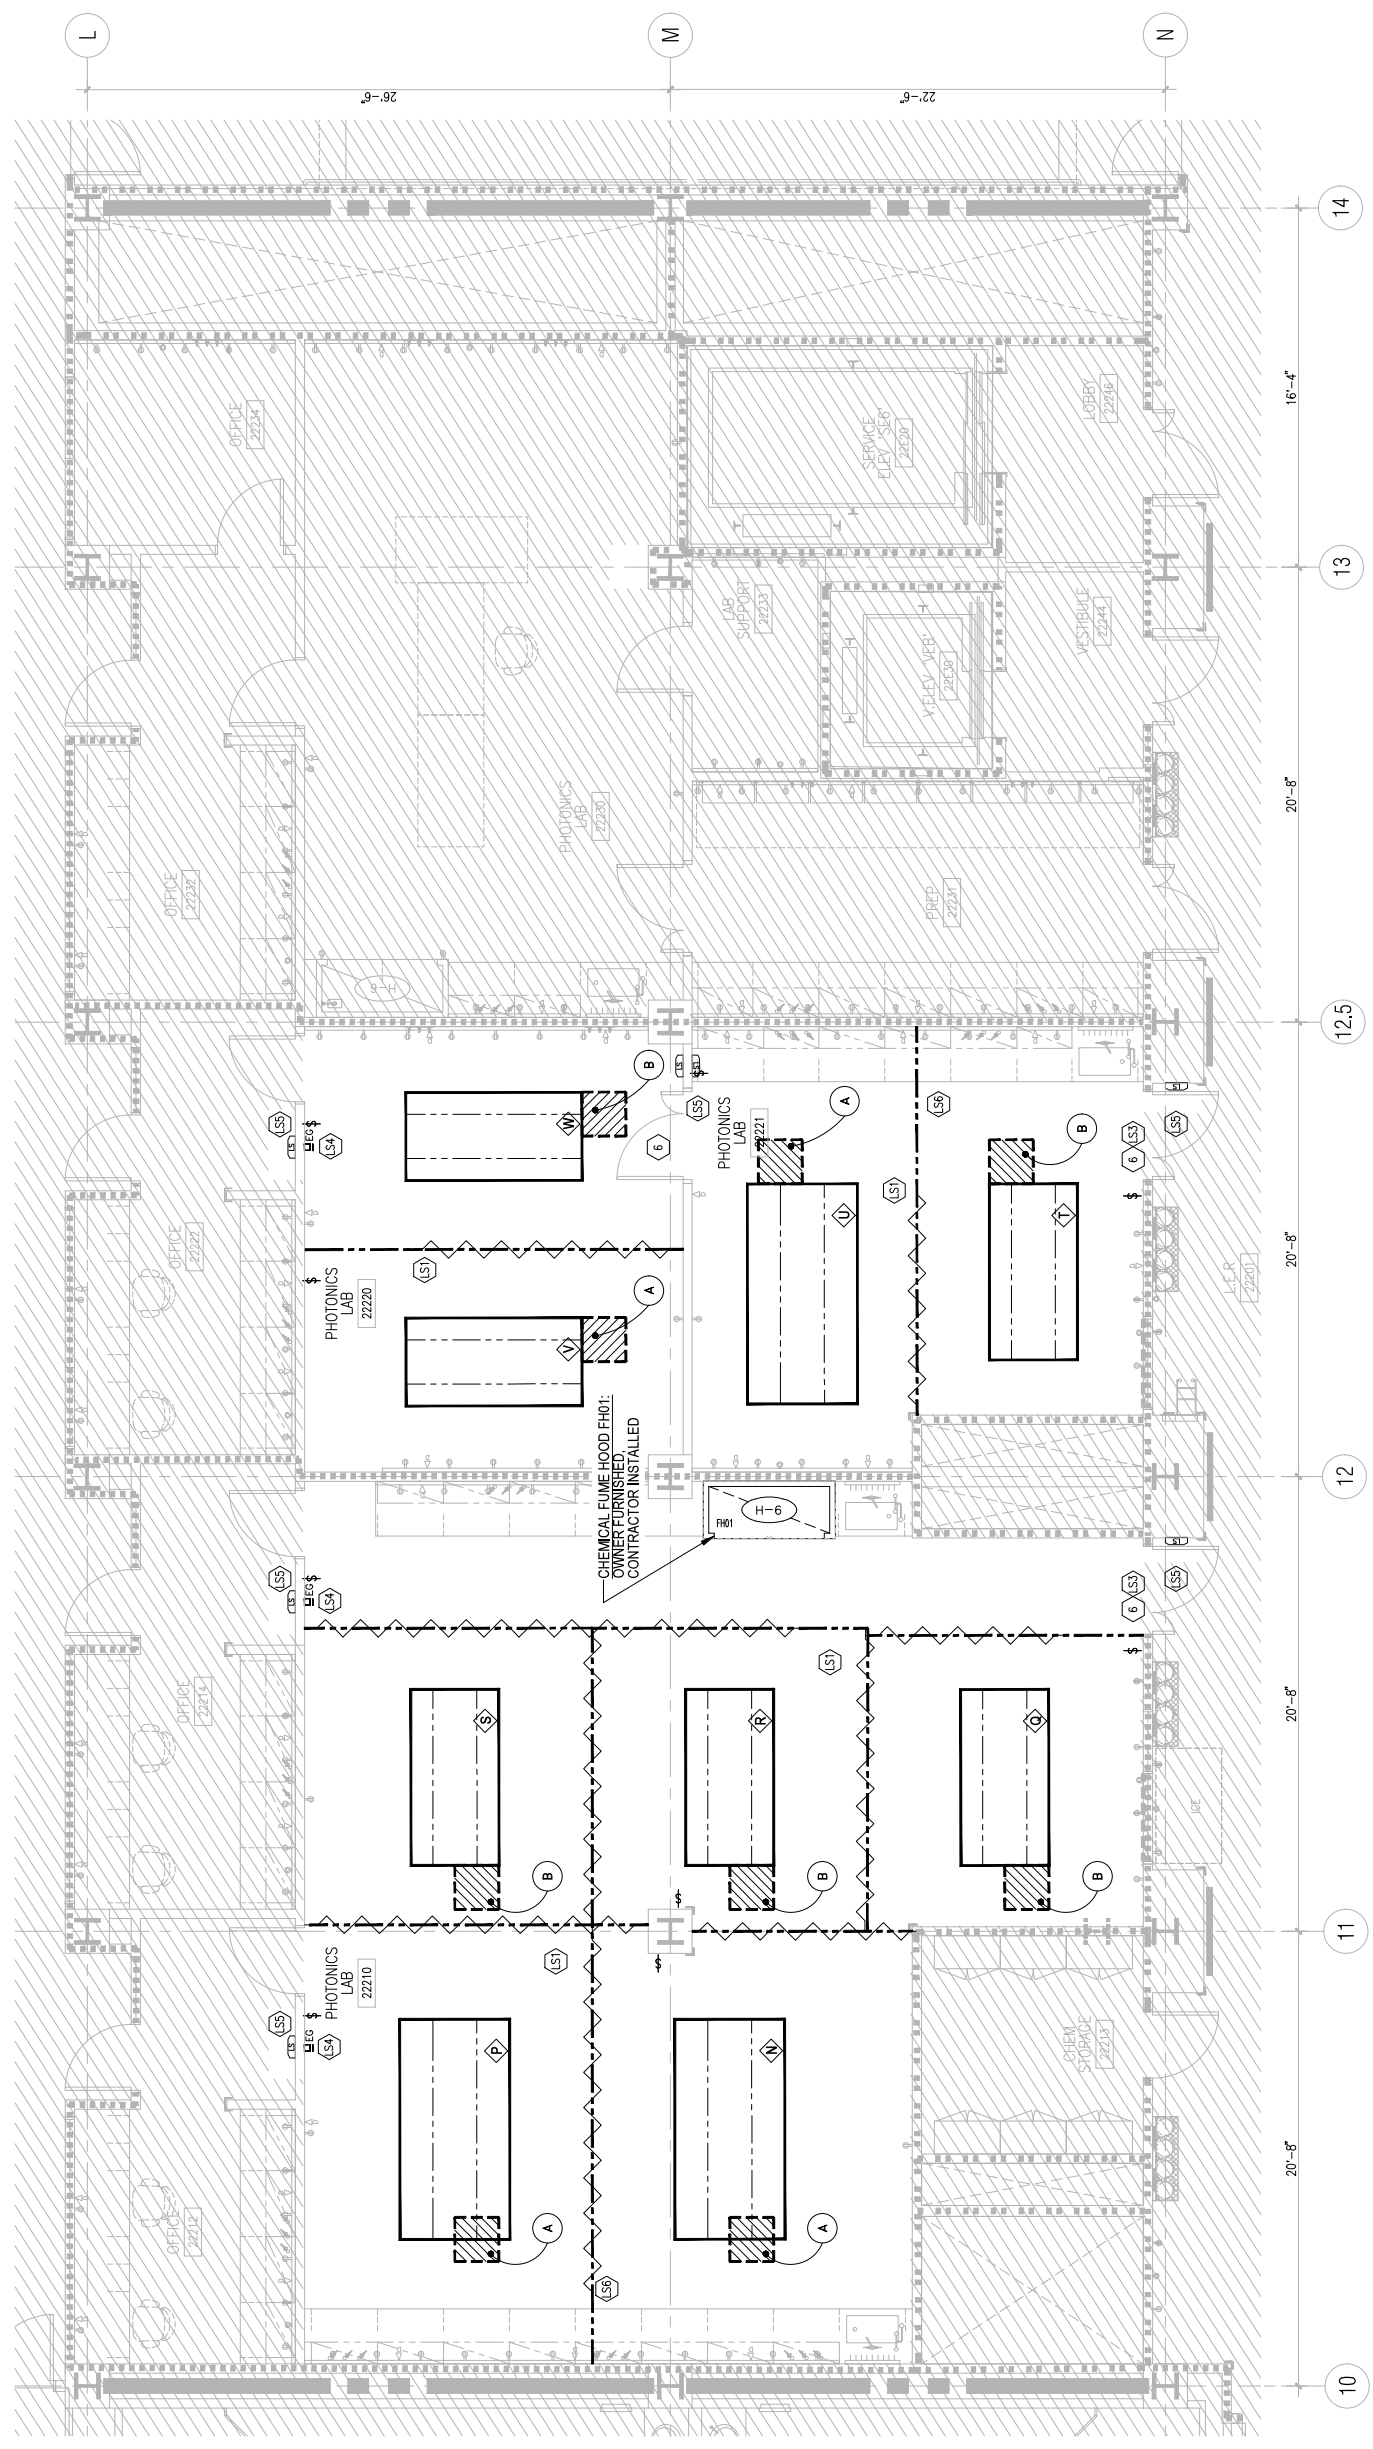

1 LABORATORY PLAN - LEVEL 2 - NORTH
 1/4" = 1'-0"

GENERAL NOTES

- NOTES:
- ALL LABORATORY CASEWORK IS EXISTING TO REMAIN U.O.A.
 - LASER AIR TABLES A* THROUGH W* PROVIDED BY OWNER.
 - EXISTING LASER IN USE ILLUMINATED SENS IN L.E.A.R. TO BE REMOVED AND REPLACED WITH NEW DUAL-STATUS ILLUMINATED SEN. INSTALL NEW SEN AT EXISTING SEN LOCATION TO REUSE EXISTING JUNCTION BOX AND WIRING.
 - NEW DUAL-STATUS ILLUMINATED SEN IN OFFICE VESTIBULES WILL BE INSTALLED AT JUNCTION BOX PROVIDED DURING CONSTRUCTION BULLETIN 2.
 - SEE HOP FOR LASER SAFETY CURTAIN LOCATION AND COORDINATION WITH ELECTRICAL, PLUMBING AND MECHANICAL SYSTEMS. CURTAIN DIMENSIONS FOR REFERENCE ONLY.
 - SEE ELECTRICAL AND PLUMBING DRAWINGS FOR COORDINATION OF LOCAL CHILLERS.

KEYNOTES


- PLAN KEYNOTES:
- NOT USED.
 - NOT USED.
 - PROVIDE 2" DIAMETER THROUGH-WALL CONDUIT FOR FUTURE FIBER OPTIC CABLE. SEE DETAIL 8/AE-300.
 - NOT USED.
 - NOT USED.
 - PROVIDE ASTRAHAL SEAL TO EXISTING DOOR PANELS.
- LASER SAFETY KEYNOTES:
- CEILING MOUNTED LASER SAFETY CURTAIN AND TRACK. SEE ELECTRICAL DRAWINGS FOR COORDINATION OF LASER SAFETY DEVICES (INCLUDING LASER IN USE ILLUMINATED SIGNAGE, CURTAIN POSITION SENSORS, AND AREA CONTROL MODULE).
 - NOT USED.
 - REPAIR / INSTALL LASER SAFETY WINDOW BLOCK / CURTAIN ON L.E.R. DOOR GLAZING.
 - LASER EQUIPMENT CONTROL MODULE AND DISCONNECT.
 - LASER IN USE ILLUMINATED STATUS SIGNAGE CONNECTED TO EXISTING ELECTRICAL BOX (SEE ELECTRICAL DRAWINGS).
 - TAILOR CURTAIN TO MATCH PROFILE OF EXISTING LAB CASEWORK NECESSARY TO PROVIDE LIGHT BLOCKING CURTAIN INSTALLATION WHEN PAIRED WITH APPROVED CLOSURE (i.e. VELCRO). INSTALL CONTINUOUS CLOSURE AT FULL VERTICAL PROFILE ENGAGED BY CURTAIN. INSTALL LASER PAINTED WINDOW BLOTTING ON GLAZED WALL CABINET DOORS WITHIN THE VERTICAL PLANE OF THE LASER CURTAIN AND TRACK. SEE DETAIL 8/AE-301.

LEGENDS

- LASER SAFETY CURTAIN AND CURTAIN TRACK
- LASER SAFETY SHADE / WINDOW BLOCK
 - DUAL-STATUS ILLUMINATED LASER SAFETY SEN
 - ENTRY GUIDES / CONTROL MODULE AND EMERGENCY EQUIPMENT SHUT-OFF
 - CONTROL FOR INDIVIDUAL LASER WORKSTATION LIGHTING. (SUGGESTED LOCATION, SEE ELECTRICAL DRAWINGS)
 - OPTICAL TABLE (M/C)
 - PHOTONICS EQUIPMENT TAG, SEE EQUIPMENT SCHEDULE.
 - SERVICE PANEL - SEE SCHEDULE ON SHEET AE-200
- LASER SAFETY KEYNOTES
- CEILING MOUNTED LASER SAFETY CURTAIN AND TRACK
 - REPAIR / INSTALL LASER SAFETY WINDOW BLOCK / CURTAIN ON L.E.R. DOOR GLAZING
 - LASER EQUIPMENT CONTROL MODULE AND DISCONNECT
 - LASER IN USE ILLUMINATED STATUS SIGNAGE CONNECTED TO EXISTING ELECTRICAL BOX (SEE ELECTRICAL DRAWINGS)
 - TAILOR CURTAIN TO MATCH PROFILE OF EXISTING LAB CASEWORK NECESSARY TO PROVIDE LIGHT BLOCKING CURTAIN INSTALLATION WHEN PAIRED WITH APPROVED CLOSURE (i.e. VELCRO). INSTALL CONTINUOUS CLOSURE AT FULL VERTICAL PROFILE ENGAGED BY CURTAIN. INSTALL LASER PAINTED WINDOW BLOTTING ON GLAZED WALL CABINET DOORS WITHIN THE VERTICAL PLANE OF THE LASER CURTAIN AND TRACK. SEE DETAIL 8/AE-301.

- LINE TYPE LEGEND**
- NEW WORK
 - EXISTING TO REMAIN
 - EXISTING TO BE REMOVED
 - NOT IN SCOPE

Rev	Date	Description of Issue
01	06/11/19	ADDENDUM 01
0	05/06/19	CONSTRUCTION DOCUMENTS

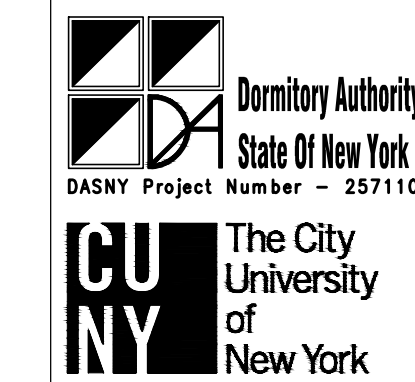

The City College of New York

85 St Nicholas Terrace
 New York, NY 10027

DASH #
 257110

Scale
 1/4" = 1'-0"

Company Drawn By
 Flad Architects

Project Phase
 CONSTRUCTION DOCUMENTS

Date
 06/11/2019

Flad Project Number
 05432-82

Sheet Title
Interior Elevations


Sheet Number
AE-850

NYC D08 Sheet Number
A-850.00

Page No.
 7 OF 10


Application No.

D08 BSCAN

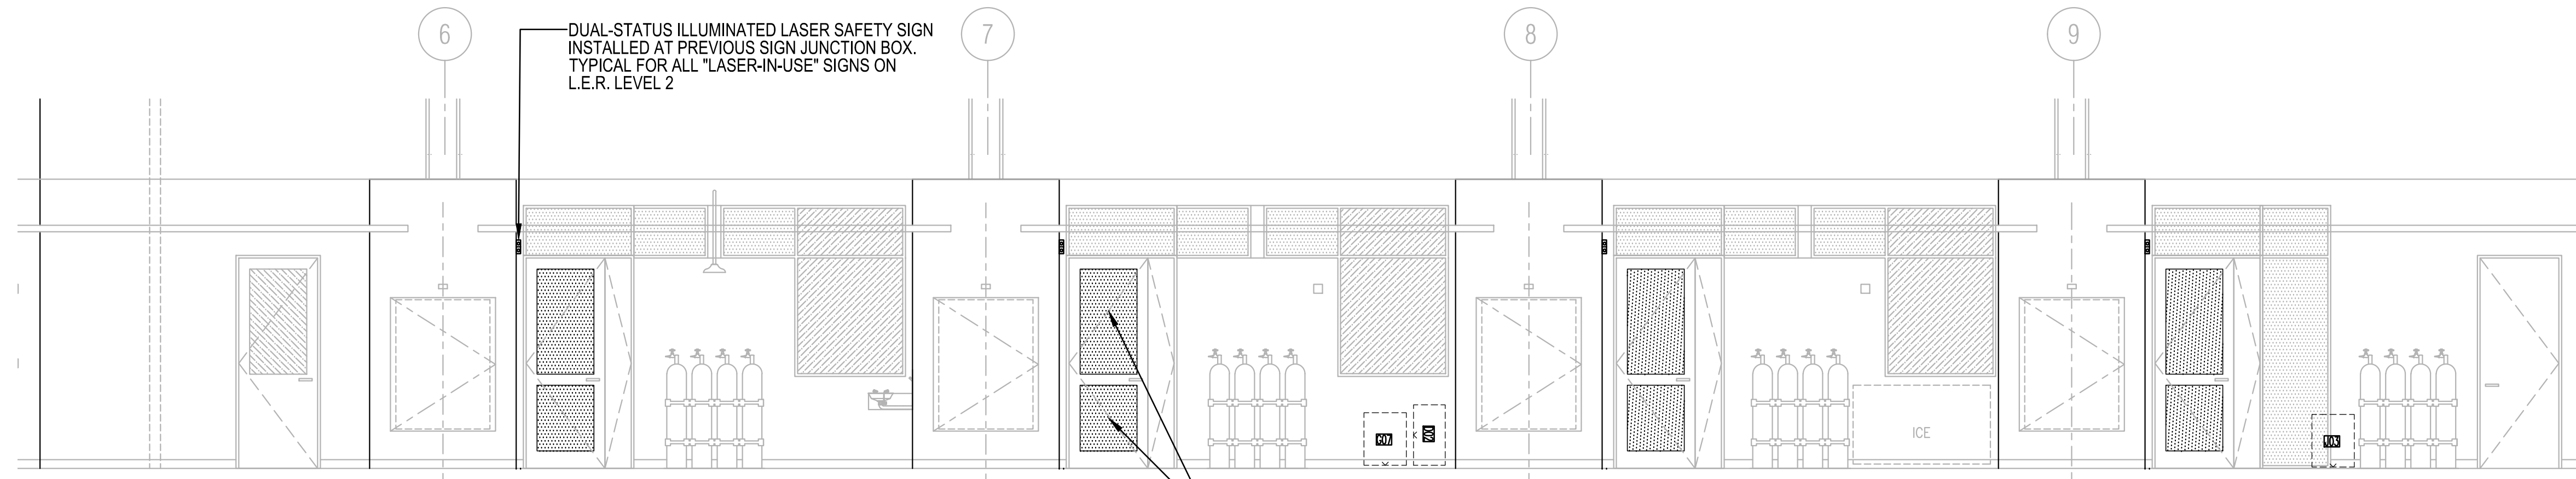


3 L.E.R. CORRIDOR ELEVATION - SECOND LEVEL - SOUTH
 1/4" = 1'-0"

LASER SAFETY WINDOW BLOCKING TO BE REMOVED AND RECONDITIONED BY MANUFACTURER (KENTEK) WITH UPGRADED VELCRO MATERIAL. LOWER PANEL TO BE RE-SIZED TO FIT WITHIN FRAME, WITH VELCRO APPLIED TO GLASS SO DOOR HANDLE CLEARS WHEN OPERATING. TYP. FOR ALL LAB / L.E.R. DOORS.

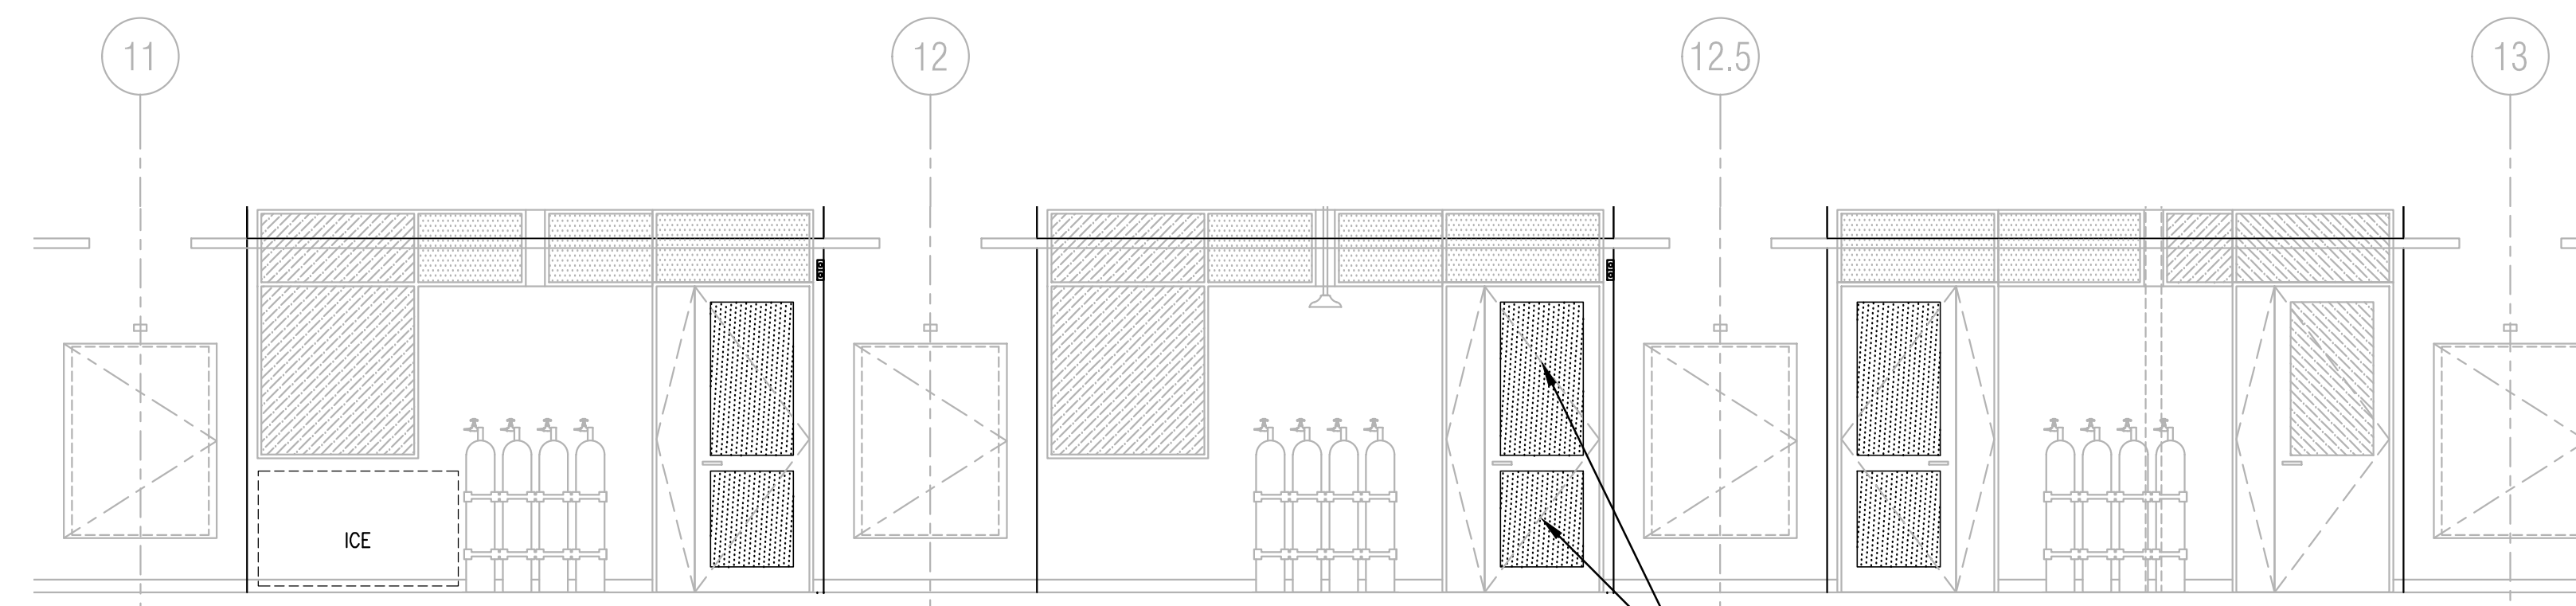


2 L.E.R. CORRIDOR ELEVATION - SECOND LEVEL - NORTH
 1/4" = 1'-0"


LASER SAFETY WINDOW BLOCKING TO BE REMOVED AND RECONDITIONED BY MANUFACTURER (KENTEK) WITH UPGRADED VELCRO MATERIAL. LOWER PANEL TO BE RE-SIZED TO FIT WITHIN FRAME, WITH VELCRO APPLIED TO GLASS SO DOOR HANDLE CLEARS WHEN OPERATING. TYP. FOR ALL LAB / L.E.R. DOORS.

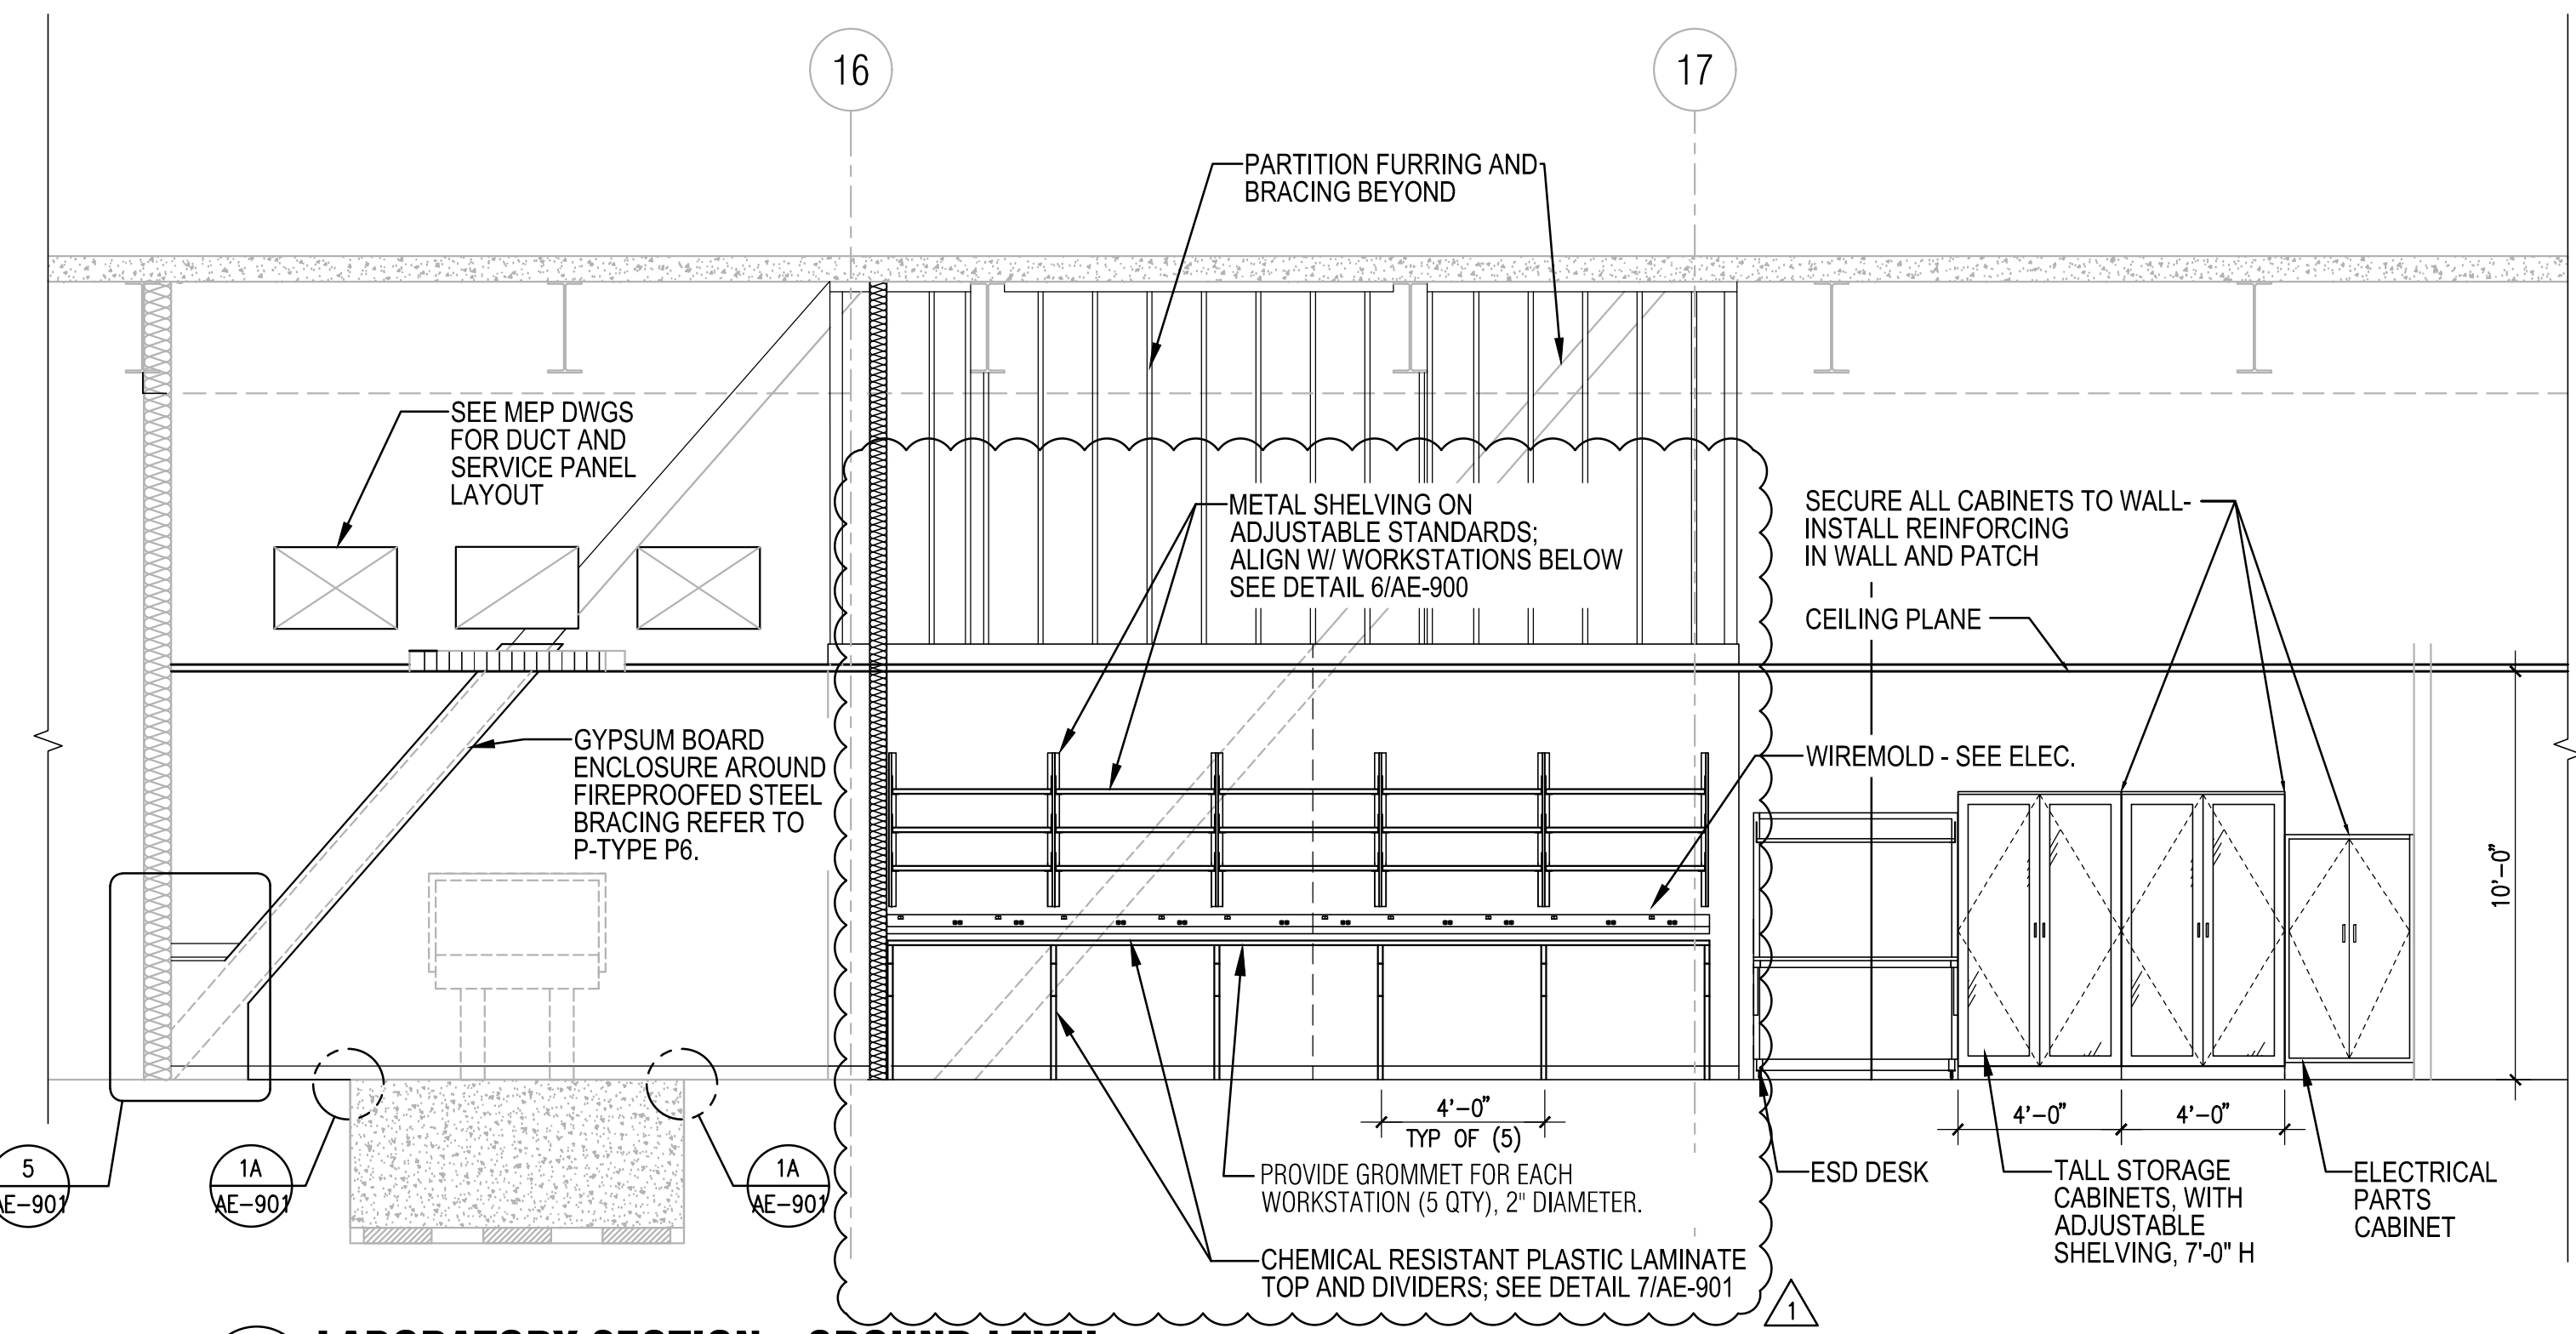


1 LABORATORY SECTION - GROUND LEVEL
 1/4" = 1'-0"

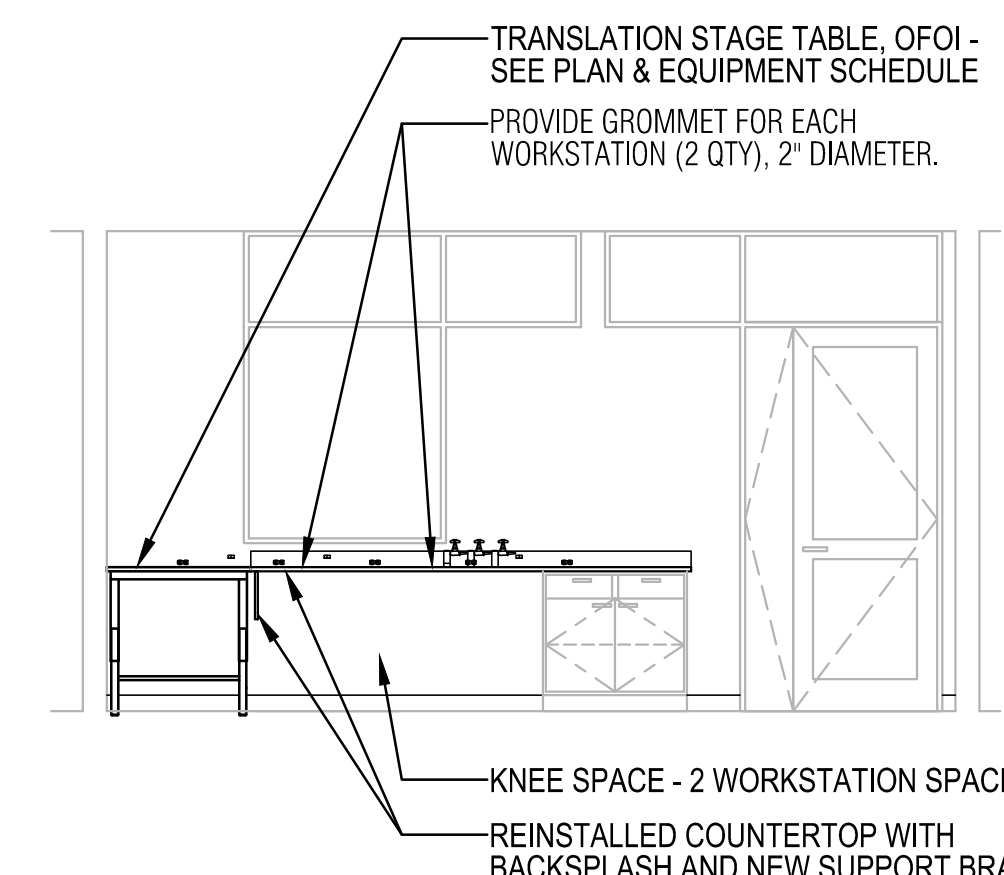


4 NANO SUPPORT LAB 2121 - EAST ELEVATION
 1/4" = 1'-0"

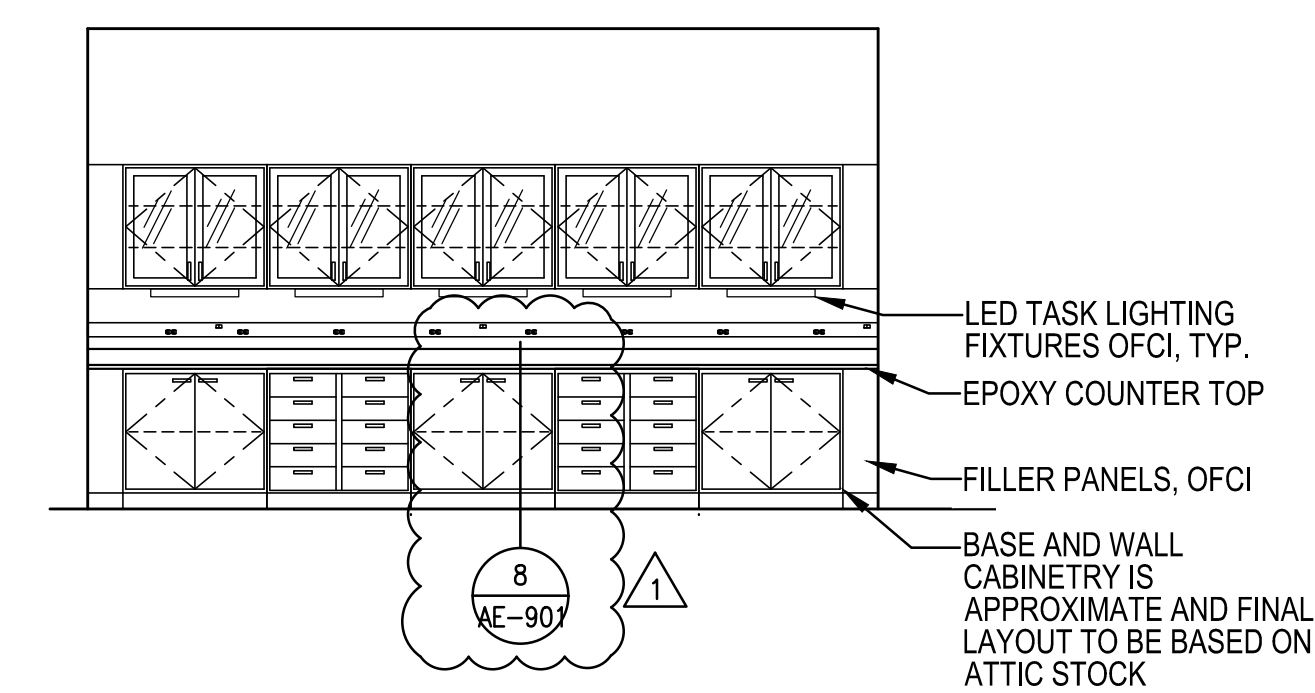


7 TEM SUPPORT 00772A SOUTH ELEVATION
 1/4" = 1'-0"

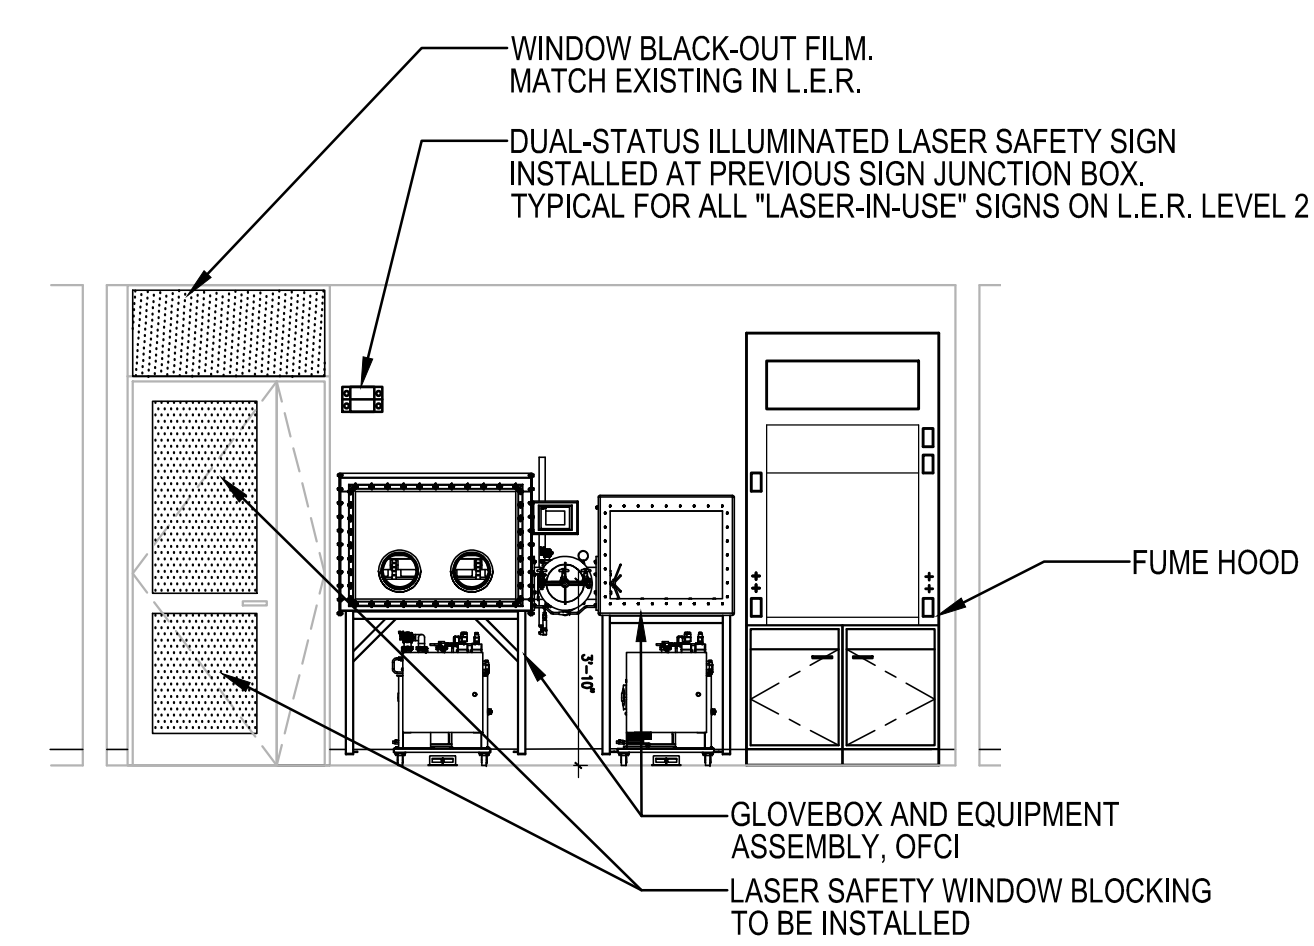

5 NANO SUPPORT LAB 2121 - WEST ELEVATION
 1/4" = 1'-0"

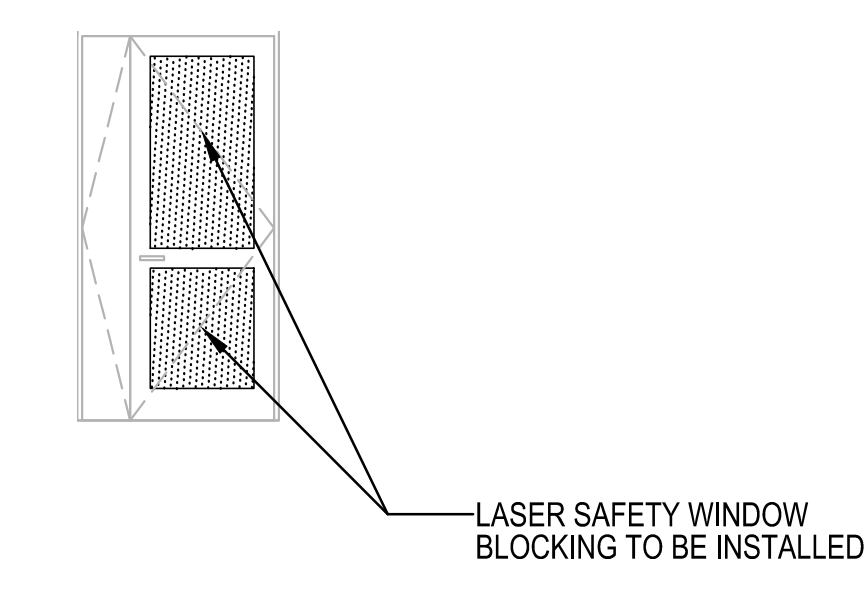


8 2.221 DOOR ELEVATION
 1/4" = 1'-0"

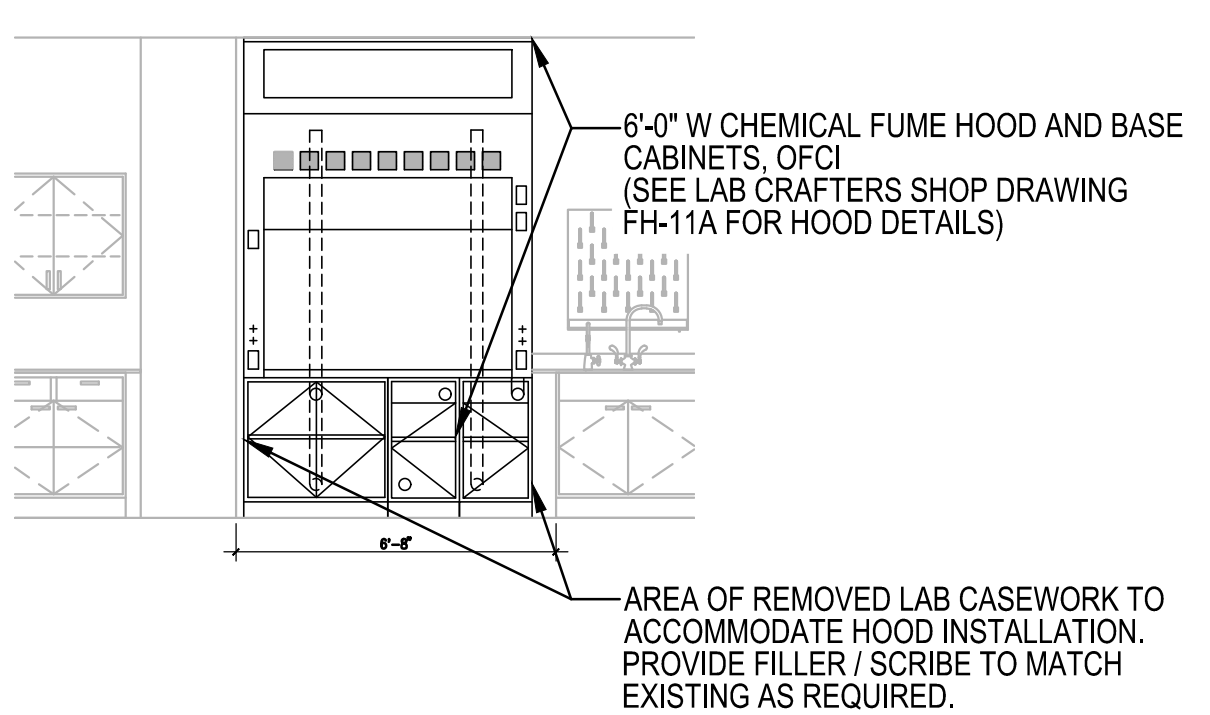


6 PHOTONICS LAB 2210 - PARTIAL NORTH ELEVATION
 1/4" = 1'-0"


AREA OF REMOVED LAB CASEWORK TO ACCOMMODATE HOOD INSTALLATION. PROVIDE FILLER / SCRIBE TO MATCH EXISTING AS REQUIRED.

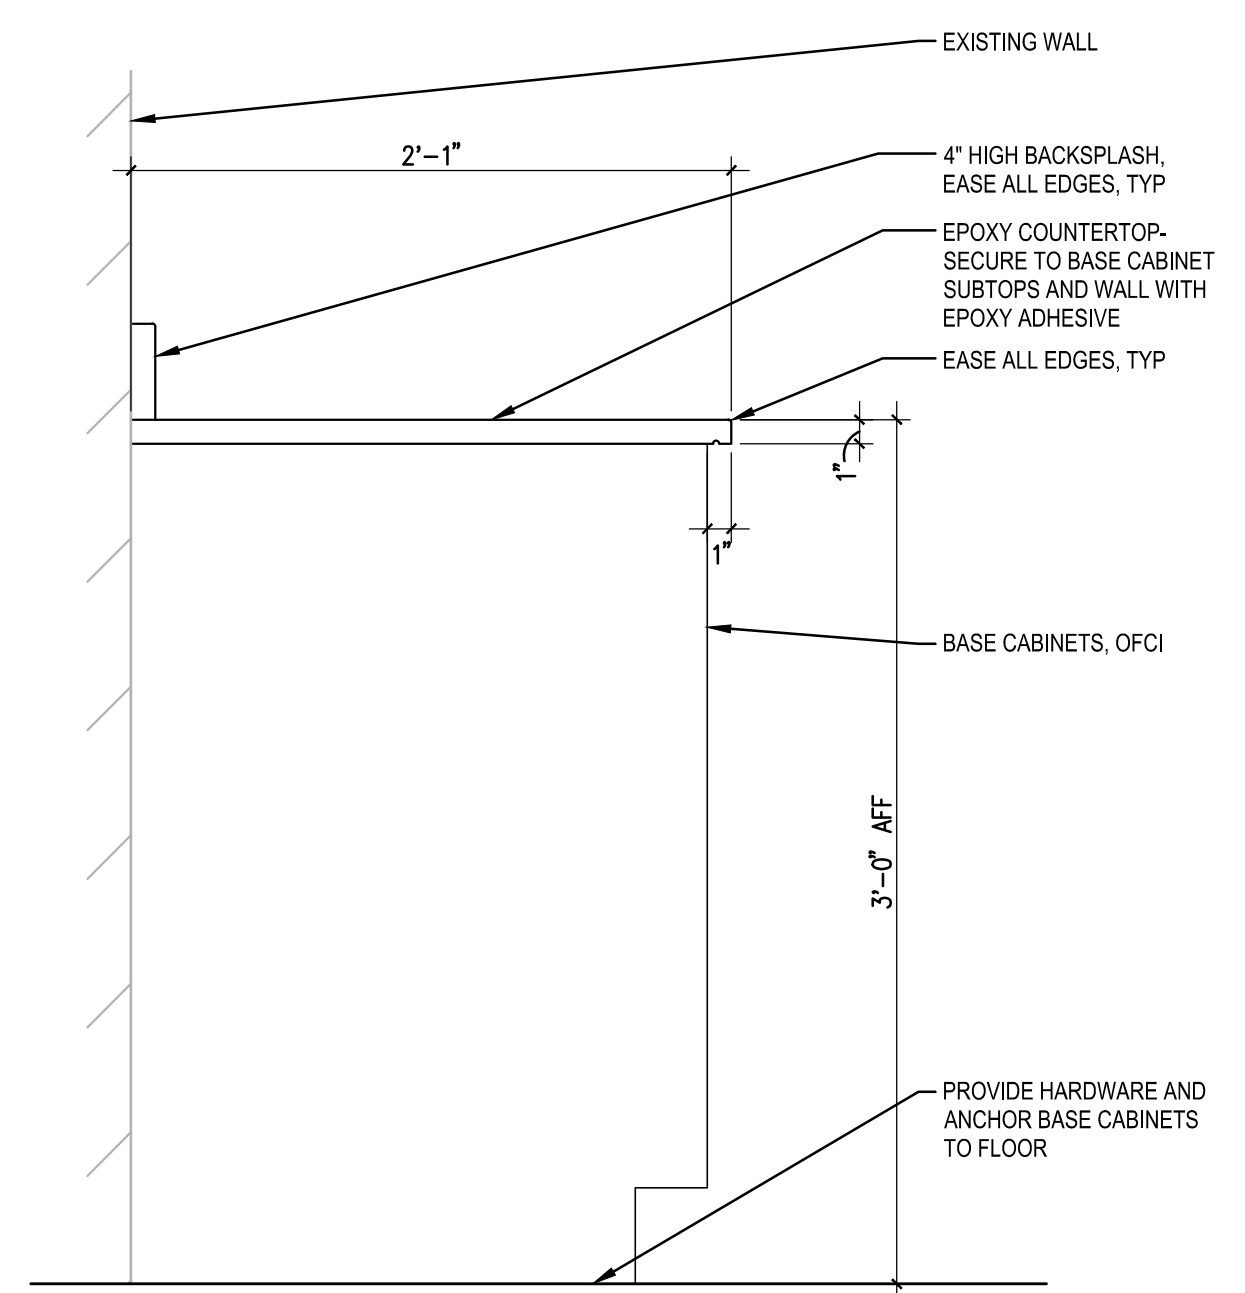


8 COUNTERTOP DETAIL
1 1/2" = 1'-0"

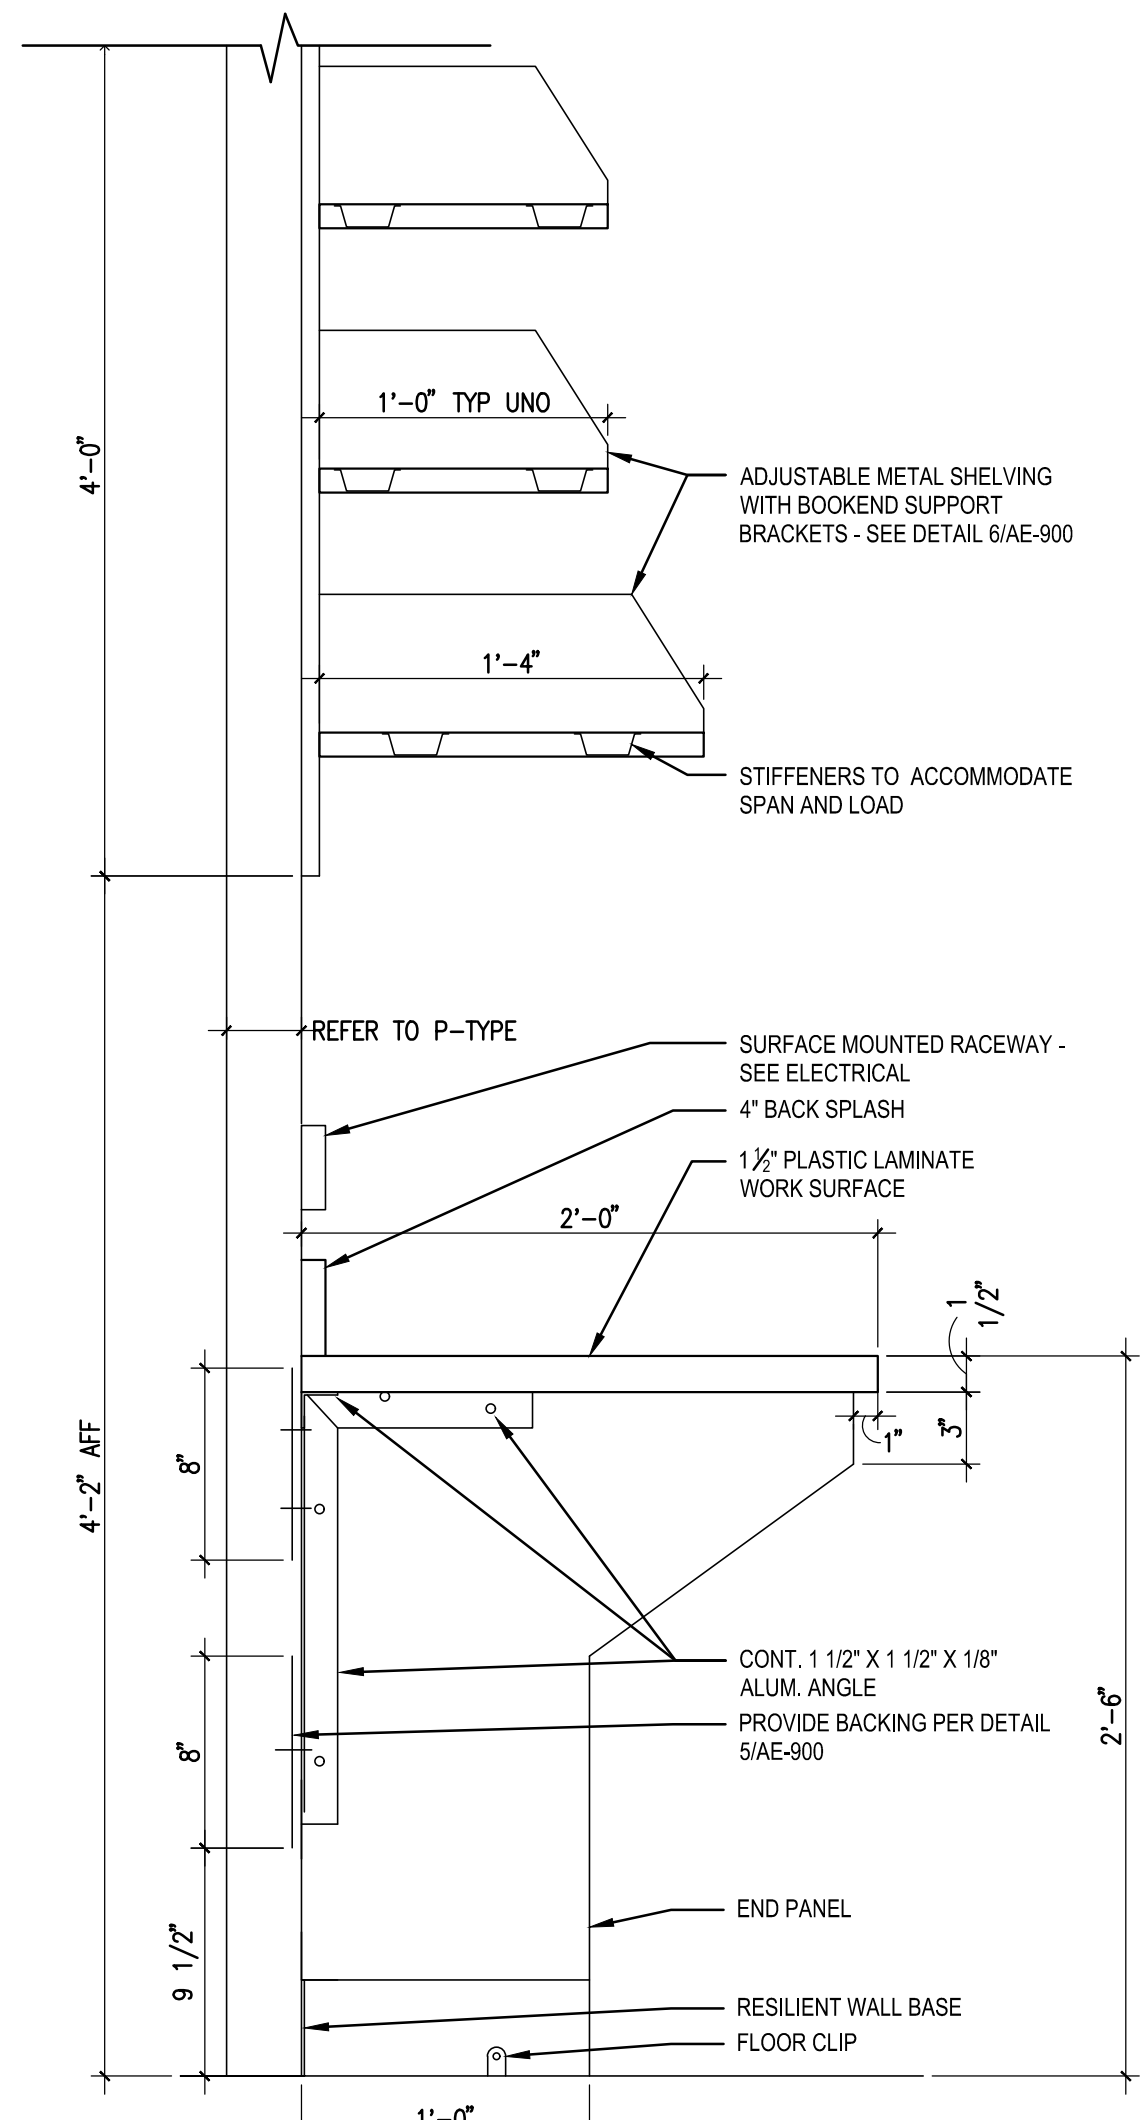

7 WORKSURFACE AND SHELVING SECTION
1 1/2" = 1'-0"

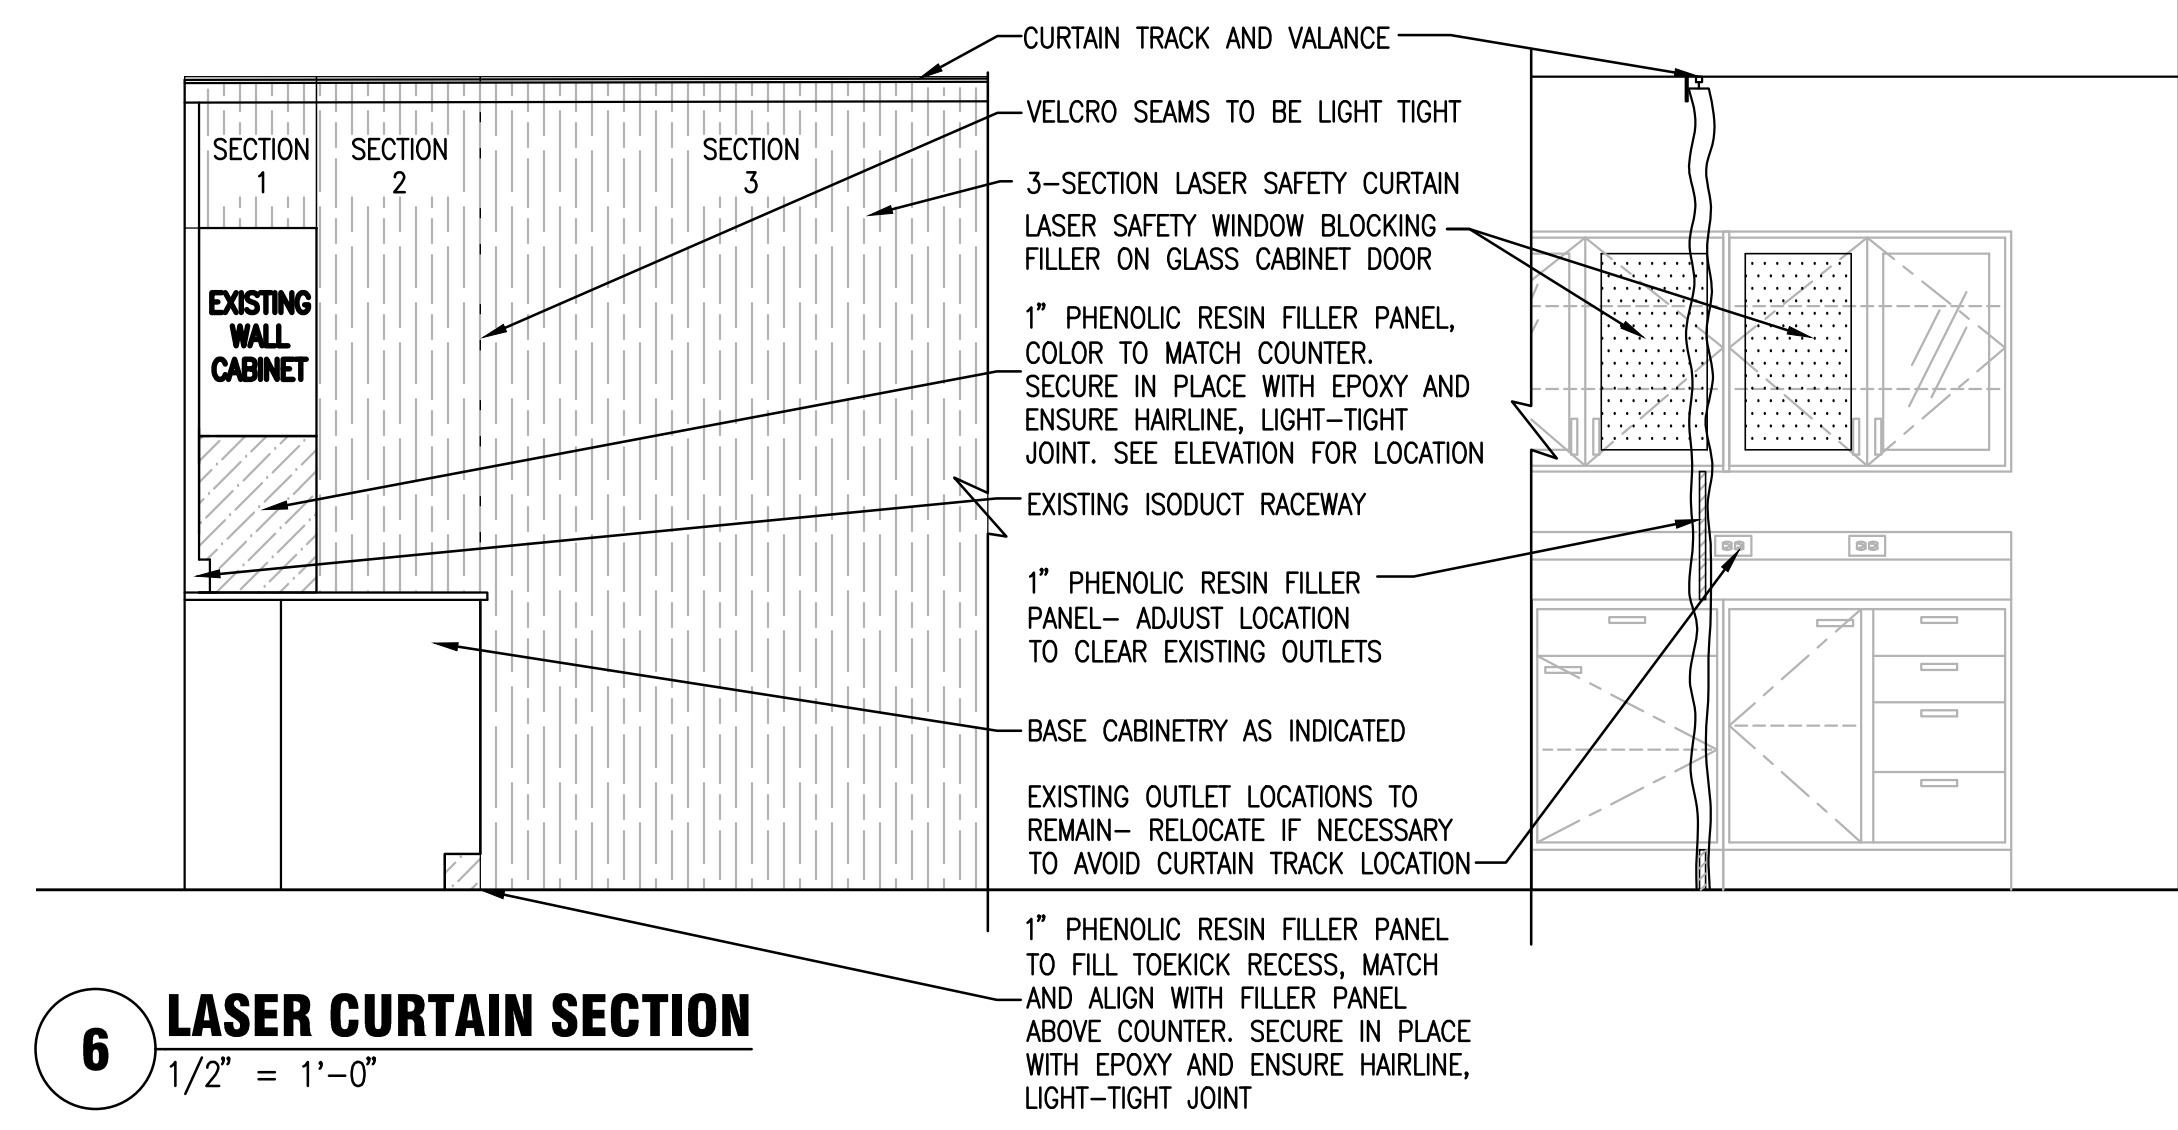


6 LASER CURTAIN SECTION
1/2" = 1'-0"

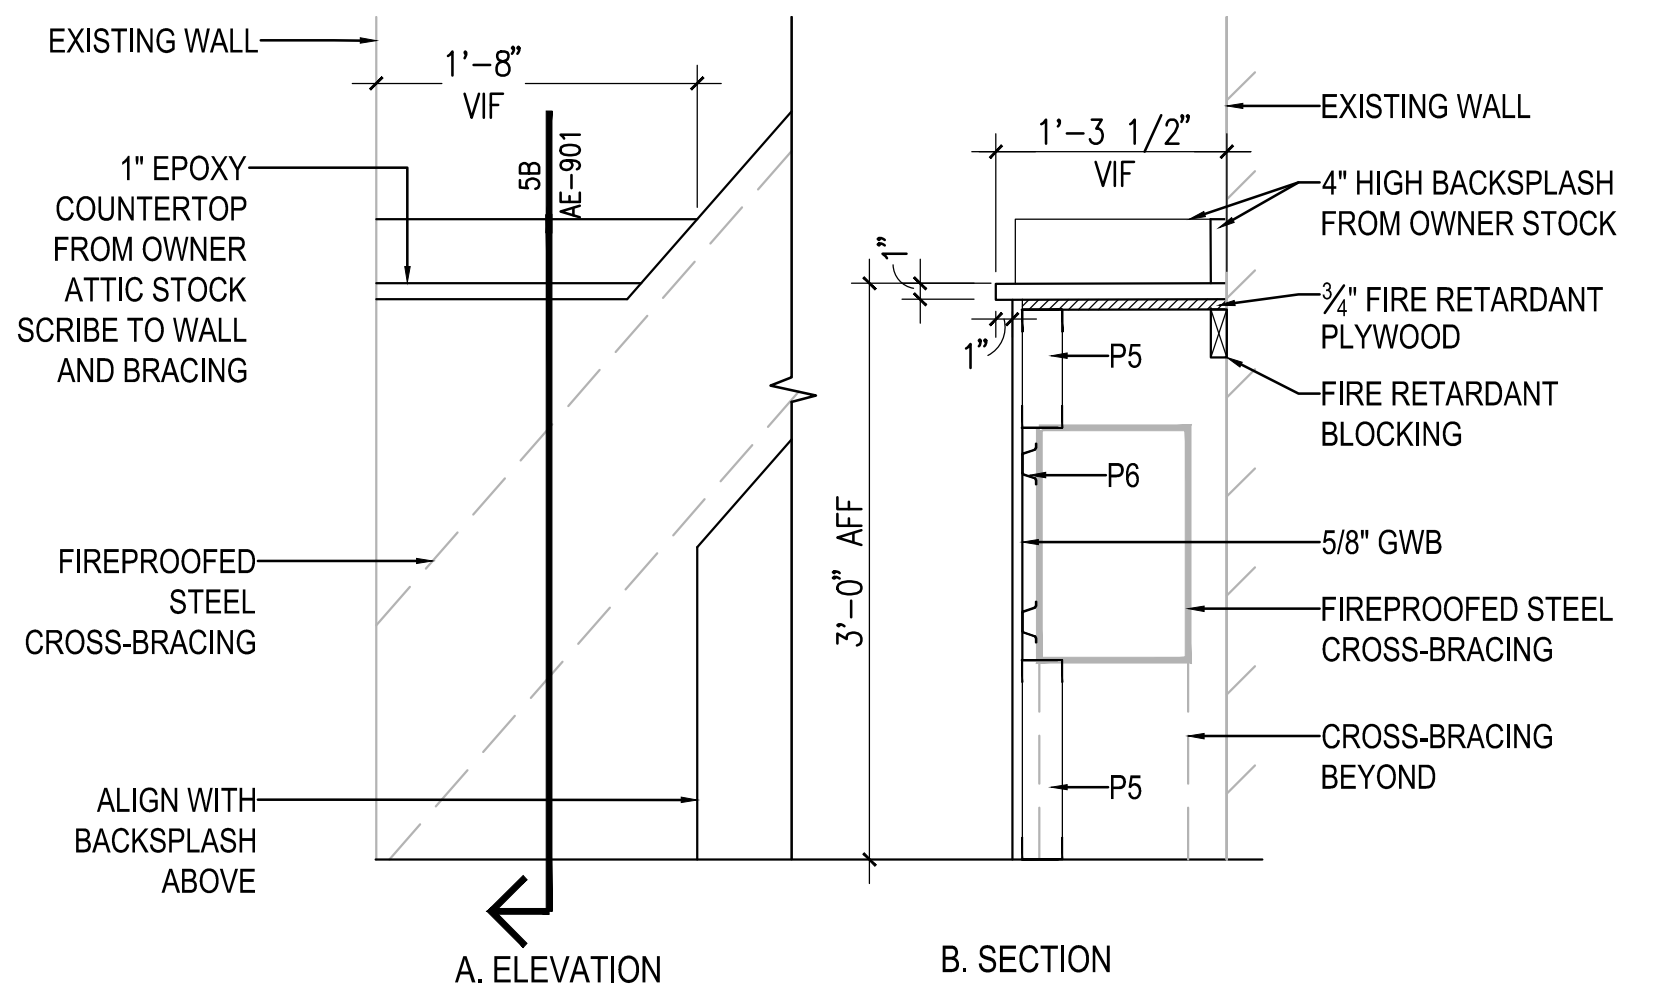


5 LAB COUNTER SUPPORT
1" = 1'-0"


- NOTES**
1. PROVIDE INTERLOCKING CROSS TEE AT EACH END OF LIGHT FIXTURE.
 2. THE TOTAL WEIGHT OF A LIGHT FIXTURE, OTHER EQUIPMENT AND CEILING MATERIAL SUPPORTED BY THE CARRYING CHANNEL AND HANGERS MUST NOT EXCEED THE ALLOWABLE DEFLECTION OF 1/160 OF ITS SPAN. DEFLECTION MUST BE FURNISHED AND CERTIFIED BY THE INSTALLER.
 3. SURFACE OR PENDANT FIXTURES AND SPEAKERS MUST BE INDEPENDENTLY SUPPORTED FROM CARRYING CHANNELS OR FROM FLOOR OR ROOF CONSTRUCTION ABOVE.
 4. PROVIDE SEISMIC BRACING AS REQUIRED.

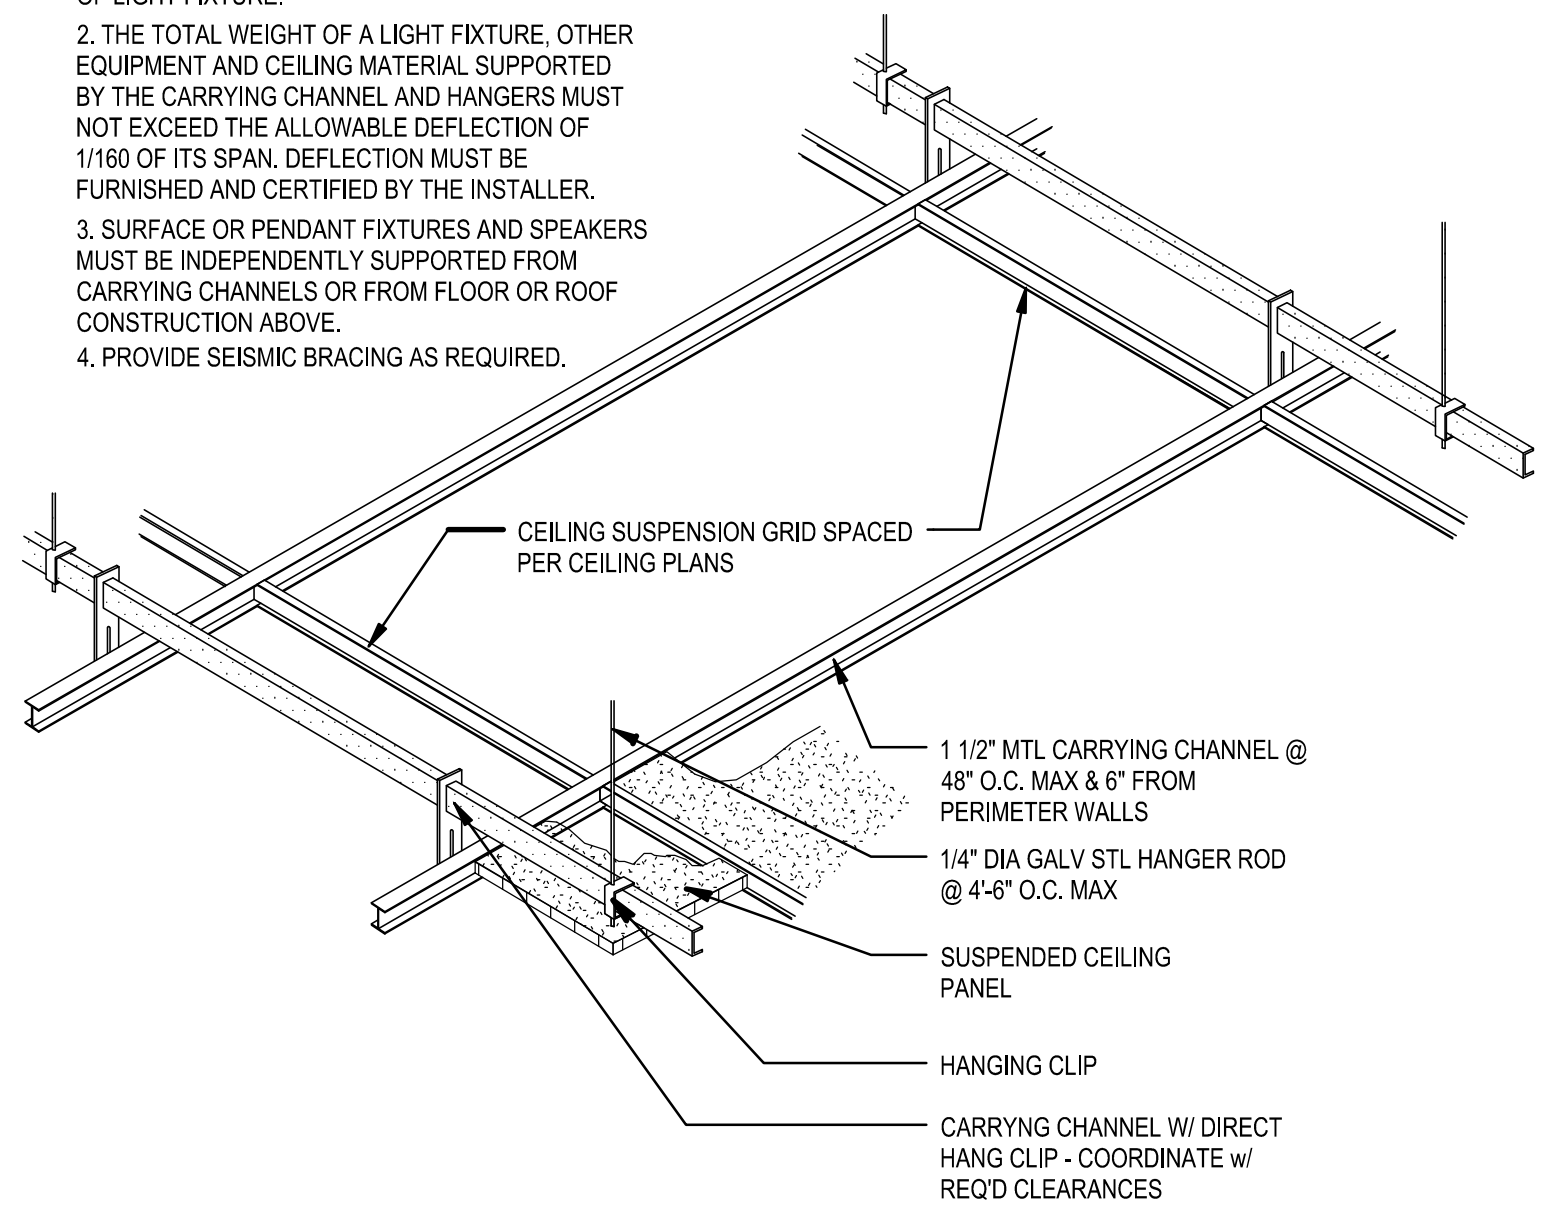


4 BLACK IRON SUSPENDED CEILING SYSTEM
1/4" = 1'-0"

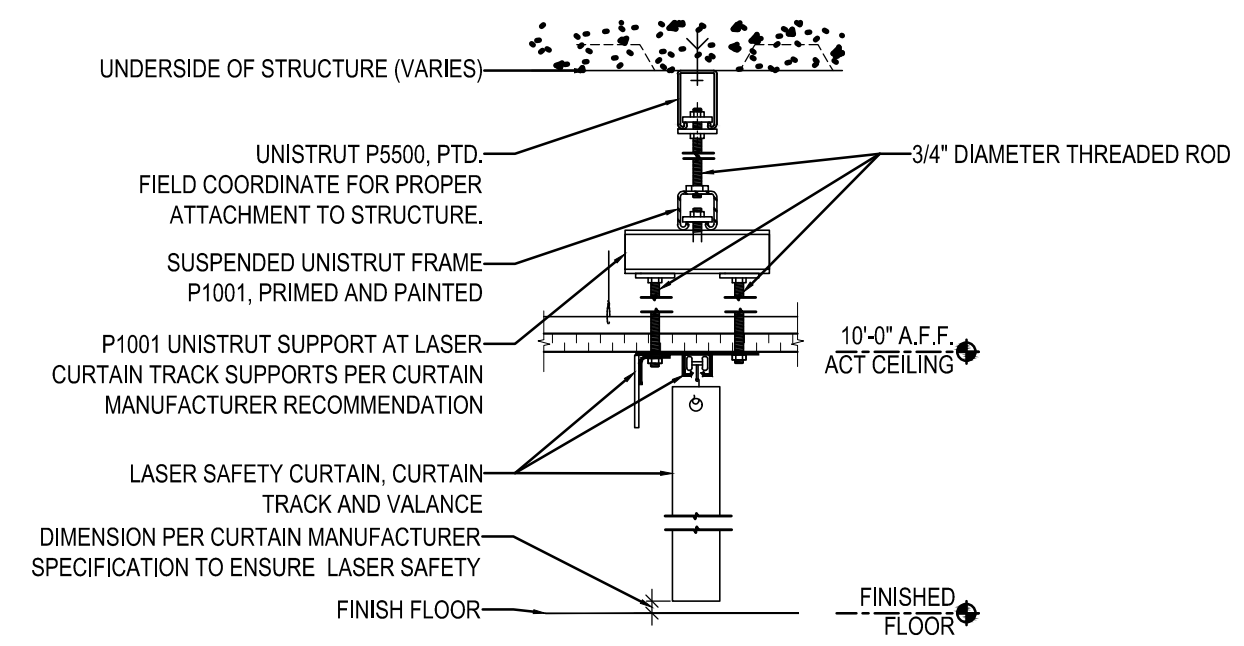


3 SUSPENDED LASER SAFETY CURTAIN DETAIL
1 1/2" = 1'-0"

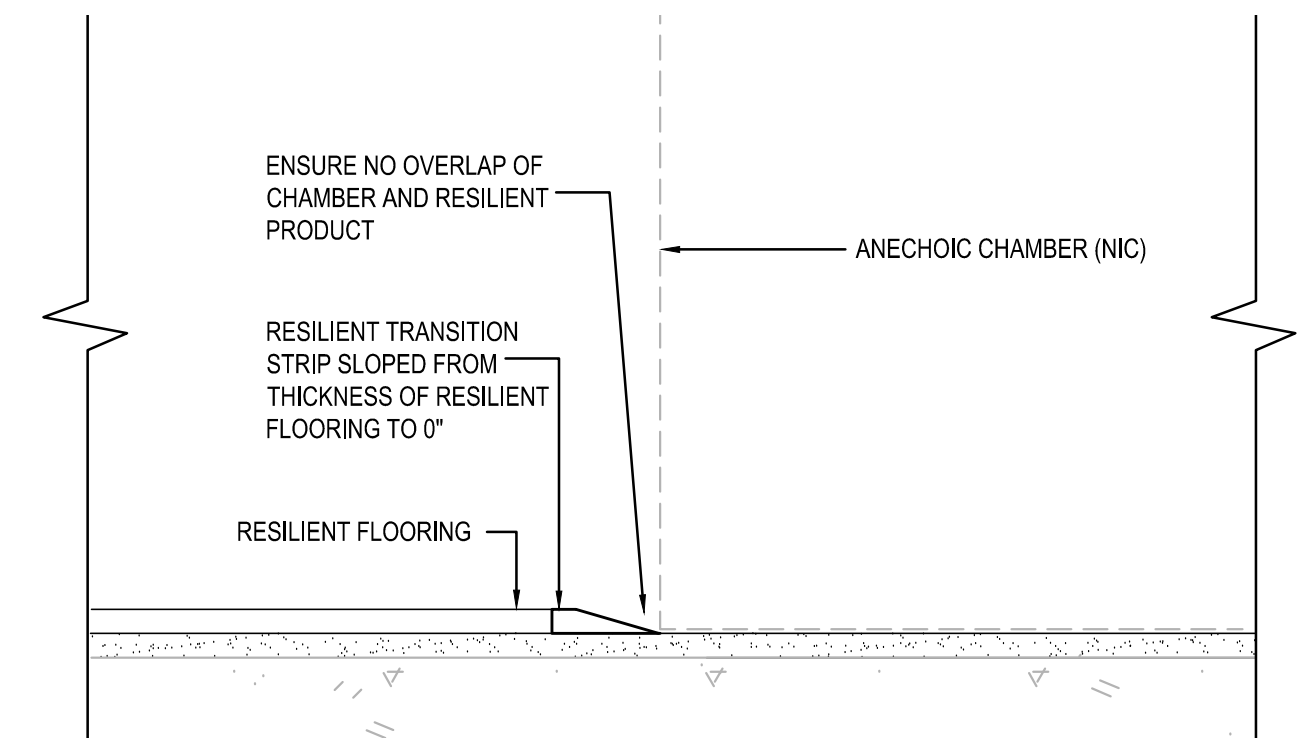

2 FLOORING TERMINATION AT ANECHOIC CHAMBER
6" = 1'-0"

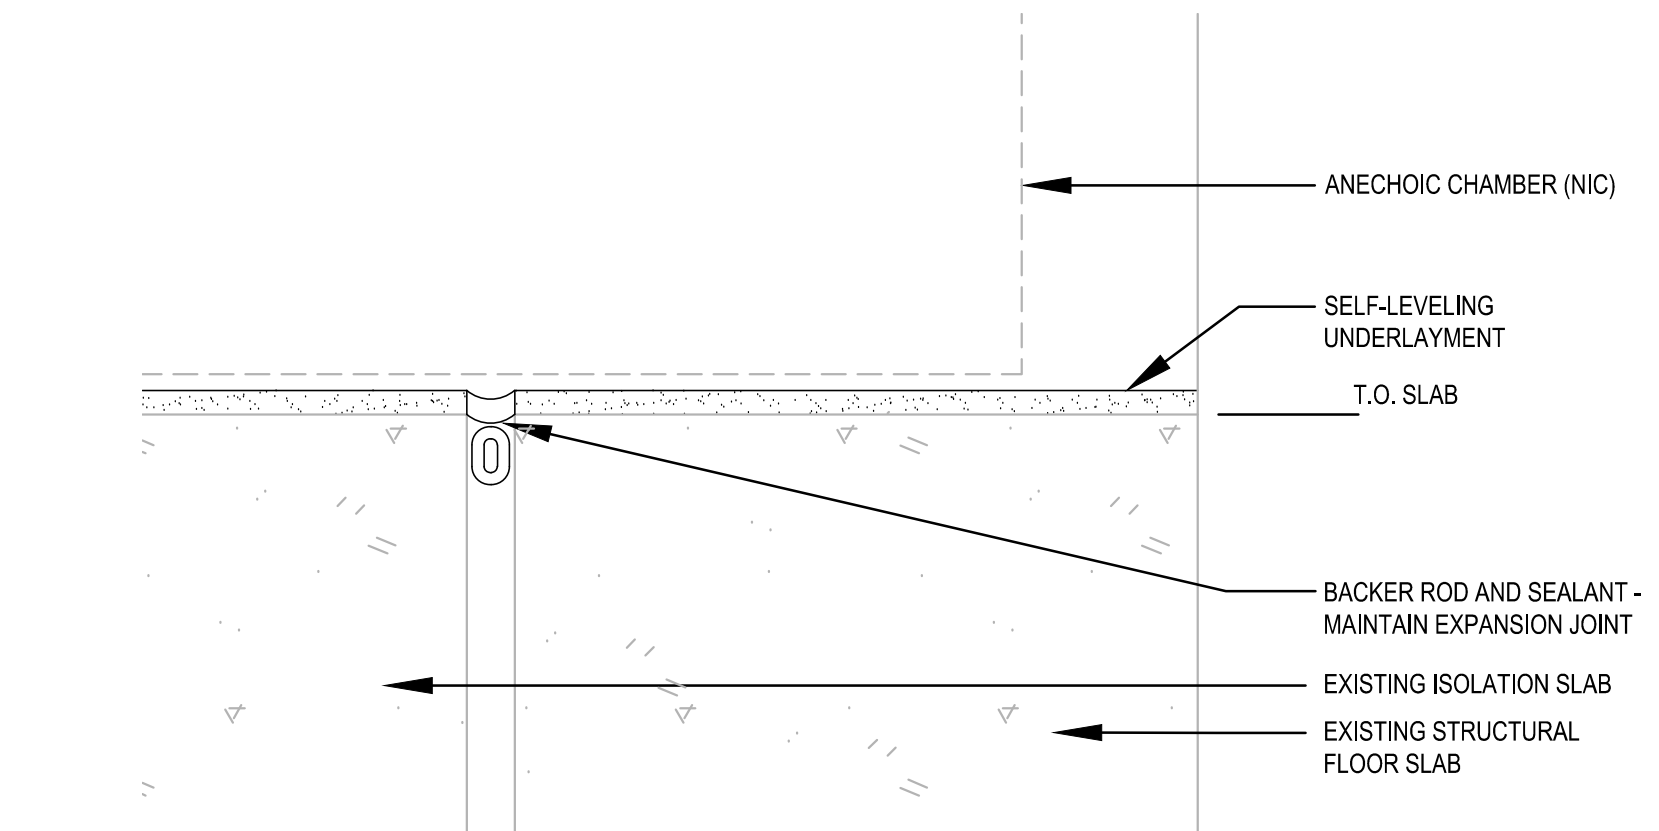

1B ISOLATION SLAB DETAIL AT ANECHOIC CHAMBER
6" = 1'-0"

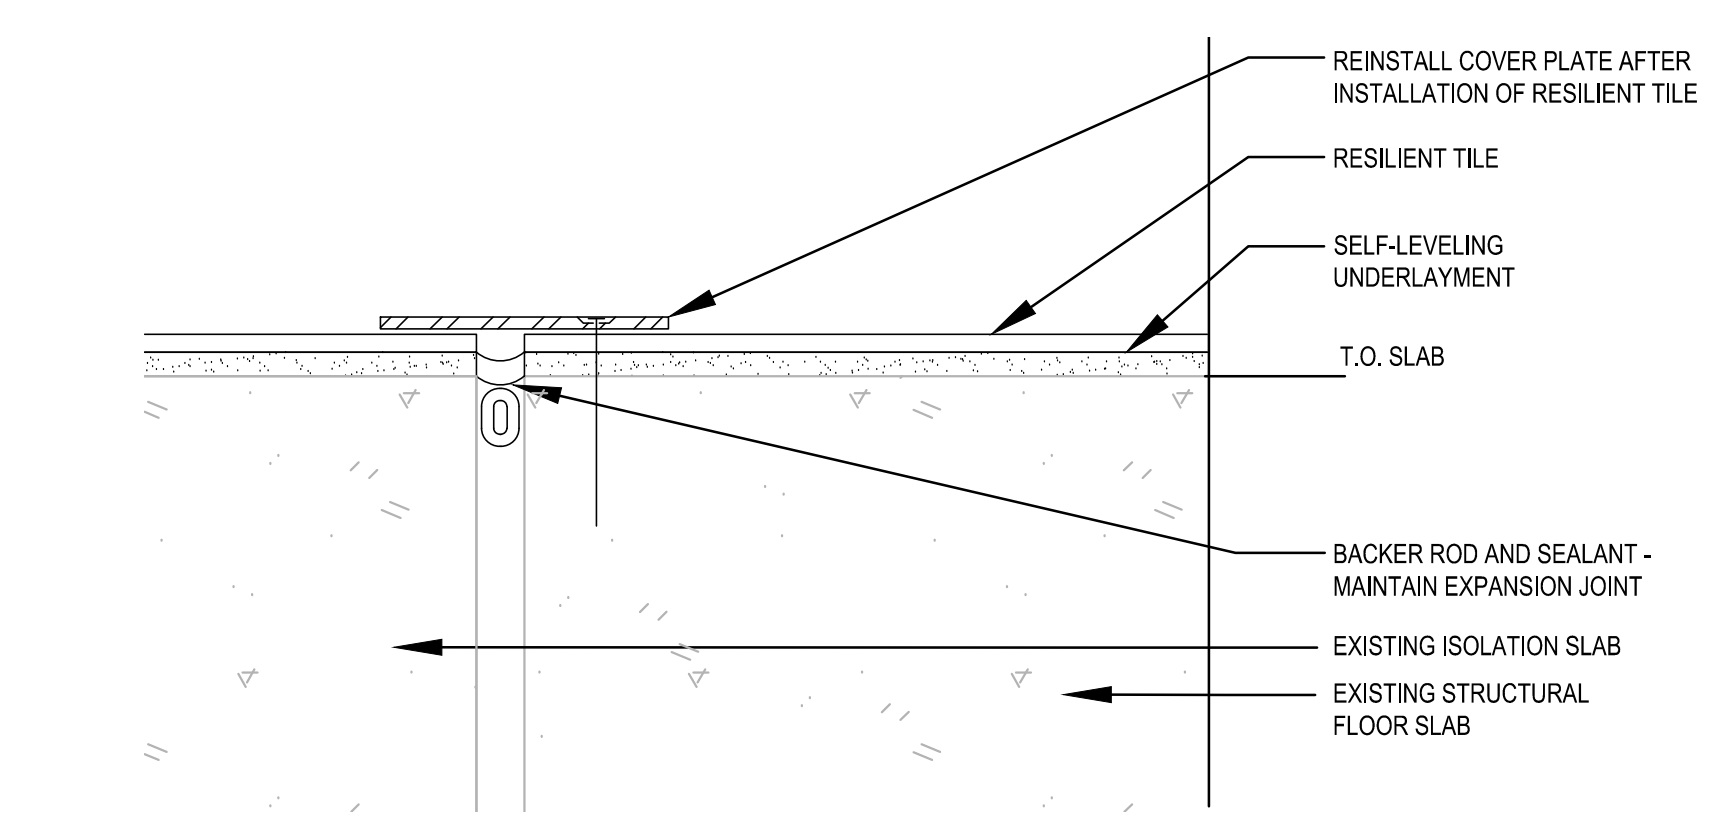

1A ISOLATION SLAB DETAIL AT SOUTH LAB
6" = 1'-0"

Flad Architects
Facility Leaders in Architectural Engineering Design, PC
201 999 Avenue 5th Fl
New York, NY 10011
Tel: 212 987 9300
Fax: 212 913 8250
www.flad.com

AEI
Affiliated Engineers, P.C.

Crestline Associates

Rev	Date	Description of Issue
01	06/11/19	ADDENDUM 01
0	05/06/19	CONSTRUCTION DOCUMENTS

Project Title

Dormitory Authority
State Of New York
DASNY Project Number - 257110

CUNY
The City University of New York

ASRC
Photonics Lab Renovations

The City College of New York
85 St Nicholas Terrace
New York, NY 10027

DASNY # 257110

Scale As Indicated

Company Drawn By
Flad Architects

Project Phase
CONSTRUCTION DOCUMENTS

Date 06/11/2019 Drawn By KS
Flad Project Number 05432-82 Checked By DH

Sheet Title
Details

Sheet Number
AE-901

NYC DOB Sheet Number
A-901.00

Page No.
9 OF 10

Application No.

DOB ESCAN