

# DEYO HALL REHABILITATION AND UPPER FLOOR ADDITION

STATE UNIVERSITY OF NEW YORK AT NEW PALTZ  
1 HAWK DRIVE NEW PALTZ, NEW YORK 12561-2443

## BID DOCUMENTS



SITE LOCATION MAP

DEYO HALL



# DEYO HALL REHABILITATION AND UPPER FLOOR ADDITION

Seal & Signature



ARCHITECT:



architecture+  
LOMONACO & FITTS,  
ARCHITECTS P.C.  
73 TROY ROAD  
TROY, NY 12180

Seal & Signature

CIVIL ENGINEER/LAND SURVEYOR:

**MJ ENGINEERING & LAND SURVEYING**  
1533 CRESCENT ROAD  
CLIFTON PARK, NEW YORK  
12065

Seal & Signature

STRUCTURAL ENGINEER:

**SPRING LINE DESIGN**  
73 TROY ROAD, SUITE 2H  
EAST GREENBUSH, NEW YORK 12061

Seal & Signature

ENVIRONMENTAL ENGINEER:

**WATTS ARCH & ENGINEER**  
95 PERRY STREET, SUITE 300  
BUFFALO, NEW YORK 14203

Seal & Signature

PLUMBING ENGINEER:

**LAKANI & JORDAN ENGINEERS**  
50 EAST 42ND STREET, SUITE 1001  
NEW YORK, NEW YORK  
10017-5405

Seal & Signature

FIRE PROTECTION/MECHANICAL/ENERGY MODELER:

**FRIEDMAN FISHER ASSOCIATED  
AND ARCHITECTS**  
22 AVIATION ROAD  
ALBANY, NEW YORK 12205

Seal & Signature

COST ESTIMATOR:

**STUART LYNN COMPANY, INC.**  
281 SIXTH AVENUE, 2ND FLOOR  
NEW YORK, NEW YORK 10014

### LIST OF DRAWINGS

- 0370 GENERAL NOTES AND LEGEND
- 0380 GENERAL NOTES AND LEGEND
- 0390 GENERAL NOTES AND LEGEND
- 0400 GENERAL NOTES AND LEGEND
- 0410 GENERAL NOTES AND LEGEND
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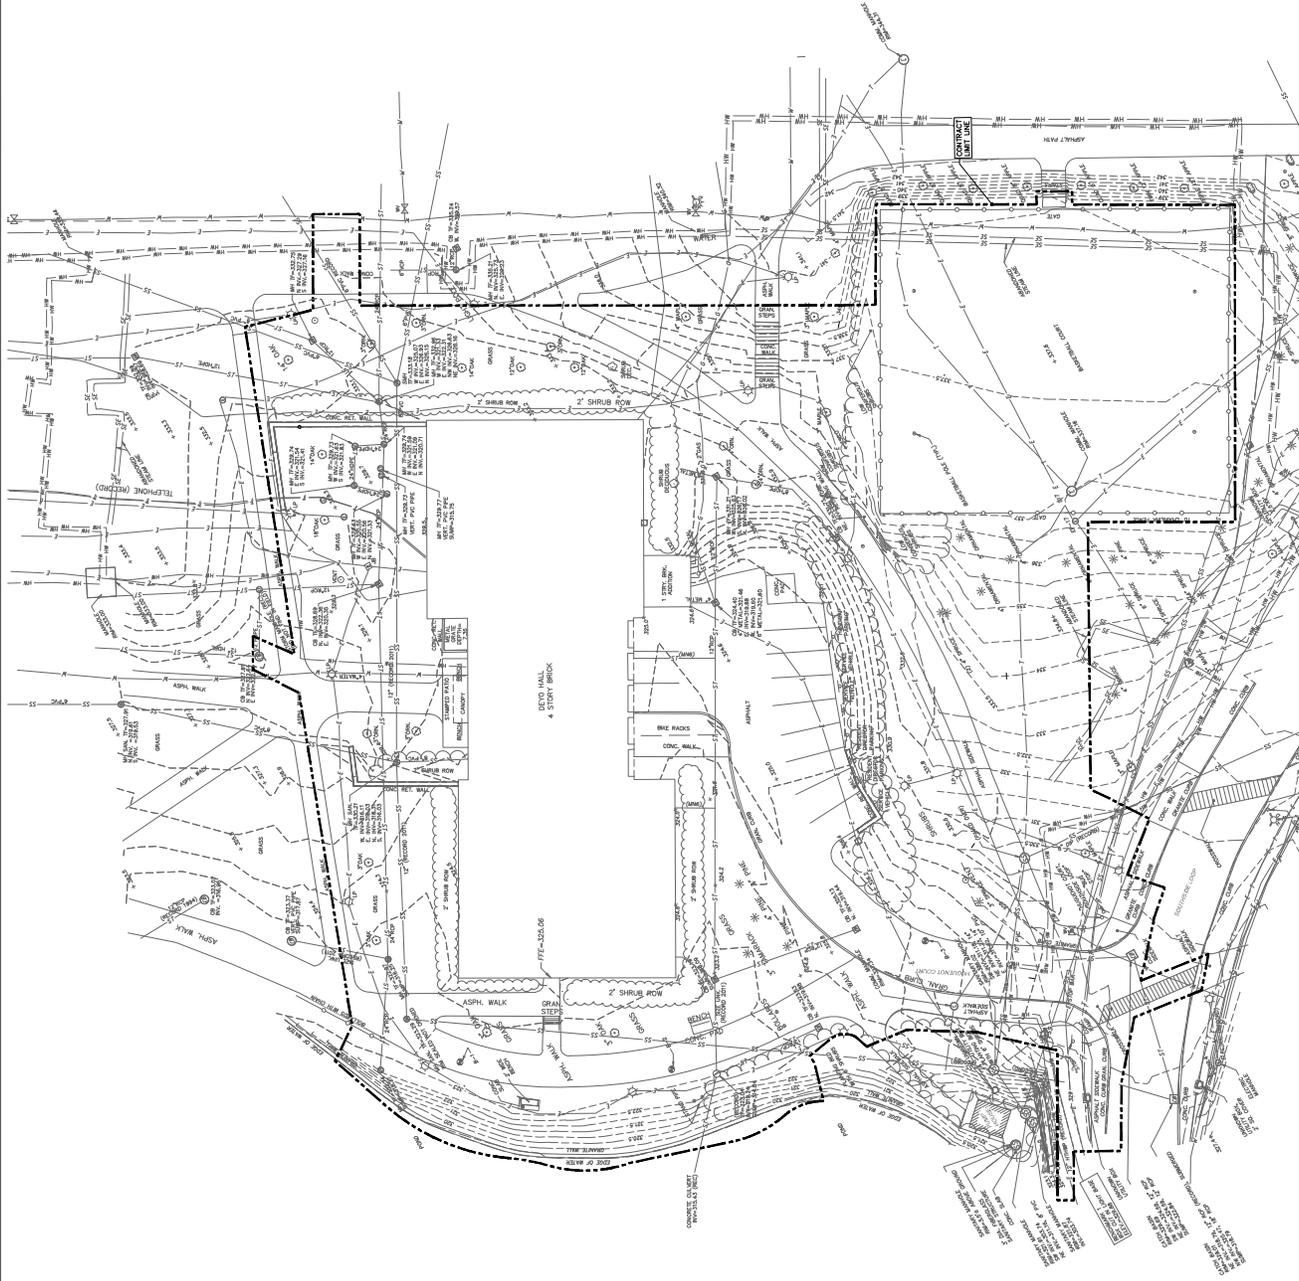






CONTRACTORS:  
 ALL CONTRACTORS SHALL BE RESPONSIBLE FOR OBTAINING ALL NECESSARY PERMITS AND APPROVALS FROM THE APPROPRIATE AGENCIES AND AGENCIES OF THE STATE OF NEW YORK. CONTRACTORS SHALL BE RESPONSIBLE FOR OBTAINING ALL NECESSARY PERMITS AND APPROVALS FROM THE APPROPRIATE AGENCIES AND AGENCIES OF THE STATE OF NEW YORK.

- LEGEND:**
- CLAY TILE
  - STORM MANHOLE
  - SANITARY SEWER MANHOLE
  - MANHOLE
  - ELECTRIC BOX
  - ELECTRIC MANHOLE
  - COMMUNICATION MANHOLE
  - PAVED DRIVE
  - FIRE HYDRANT
  - GATE VALVE
  - LIGHT POLE
  - SINGLE POST SIGN
  - DECIDUOUS TREE
  - SHRUB
  - BELLWIND/POST
  - BENCHMARK
  - UNDERGROUND ELECTRIC LINE
  - STORM SEWER LINE
  - SANITARY SEWER LINE
  - UNDERGROUND WATER LINE
  - UNDERGROUND STEAM LINE
  - UNDERGROUND TELEPHONE
  - CHAIN LINK FENCE
  - WOODS LINE



**REVISIONS**

No.	Description	Date

Project Title  
**STATE UNIVERSITY OF NEW YORK AT NEW PALTZ**  
**DEYO HALL**  
**REHABILITATION & UPPER FLOOR ADDITION**

Phase  
**BID DOCUMENTS**  
**EXISTING CONDITIONS PLAN**

Drawn By: [Blank] Checked By: Date: 6-26-2018  
 TEW: [Blank] SNM: DASNY Project No: 241630  
 Seal & Signature: [Blank] Drawing No: [Blank]  
**C-100**  
 Scale: AS NOTED






**SIGN SCHEDULE**

SIGN NO.	SIGN FACE	MIN. SIZE	COLORS	MUTCD NUMBER	MOUNTING
1	PAVEMENT MARKING	12"x18"	WHITE	R1-4	4/C-500
2	PAVEMENT MARKING	12"x18"	GREEN, WHITE ON BLACK	R7-1	4/C-500
3	STOP SIGN	30"x30"	RED	R1-1	4/C-500

**CAMPUS SIGNAGE**

SIGN NO.	SIGN FACE	MIN. SIZE	COLORS	MUTCD NUMBER	MOUNTING
4	PAVEMENT MARKING	12"x18"	WHITE	REFERS TO MUTCD STANDARDS	4/C-500
5	PAVEMENT MARKING	12"x18"	WHITE	REFERS TO MUTCD STANDARDS	4/C-500
6	PAVEMENT MARKING	12"x18"	WHITE	REFERS TO MUTCD STANDARDS	4/C-500
7	PAVEMENT MARKING	12"x18"	WHITE	REFERS TO MUTCD STANDARDS	4/C-500

- LEGEND**
- CONTRACT LIMIT LINE SEE DETAIL 1/2/200
  - PAVEMENT MARKING SEE DETAIL 2/2/200
  - CONCRETE SIDEWALK SEE DETAIL 13/2/200
  - REINFORCED TURF SEE DETAIL 2/2/200
  - REGULATORY SIGN SEE DETAIL 4/2/200
  - CHAIN LINK FENCE SEE DETAIL 1/2/200

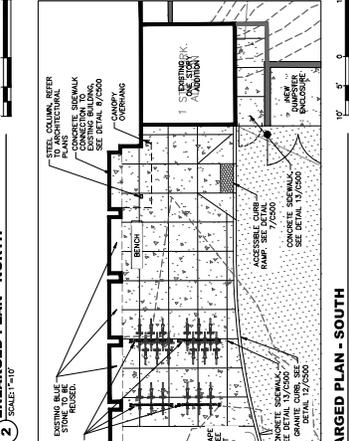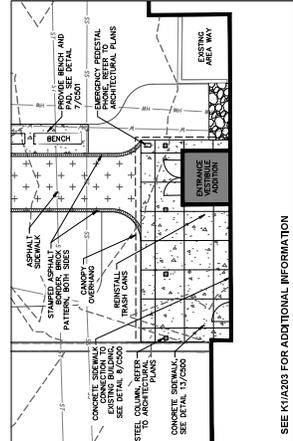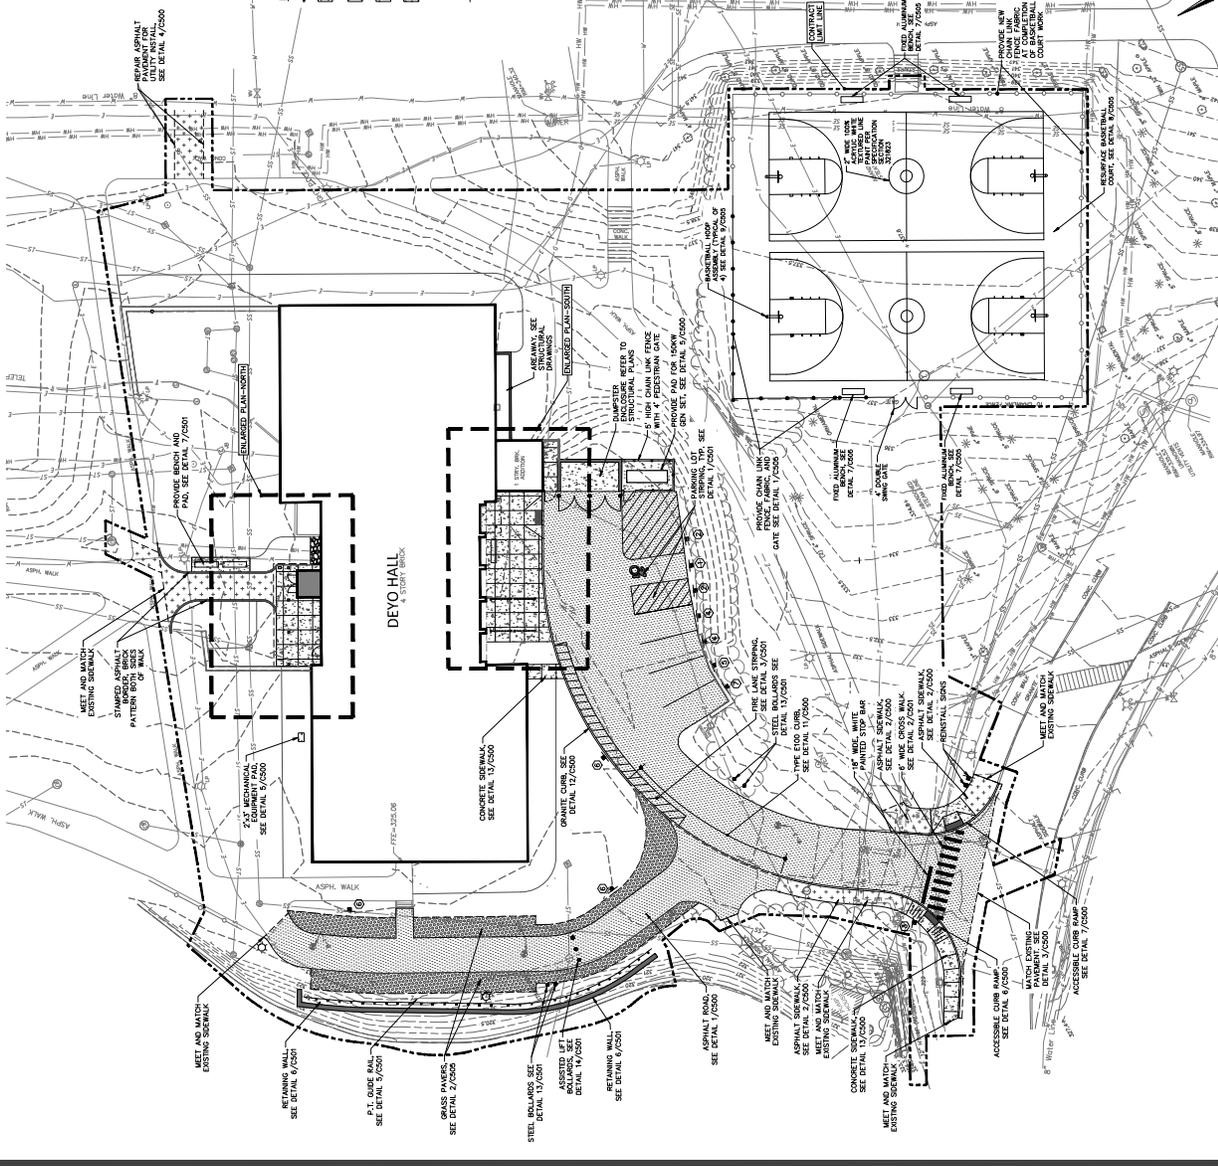

**1 LAYOUT PLAN**  
SCALE: 1/8" = 1'-0"


**2 ENLARGED PLAN - NORTH**  
SCALE: 1/4" = 1'-0"

**3 ENLARGED PLAN - SOUTH**  
SCALE: 1/4" = 1'-0"

**LEGEND**

- CONTRACT LIMIT LINE
- ROADWAY ASPHALT PAVEMENT
- PATH ASPHALT PAVEMENT
- CONCRETE SIDEWALK
- REINFORCED TURF
- REGULATORY SON
- CHAIN LINK FENCE
- EXISTING UTILITY MARKINGS AND EXISTING POINTS

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Project No. 1

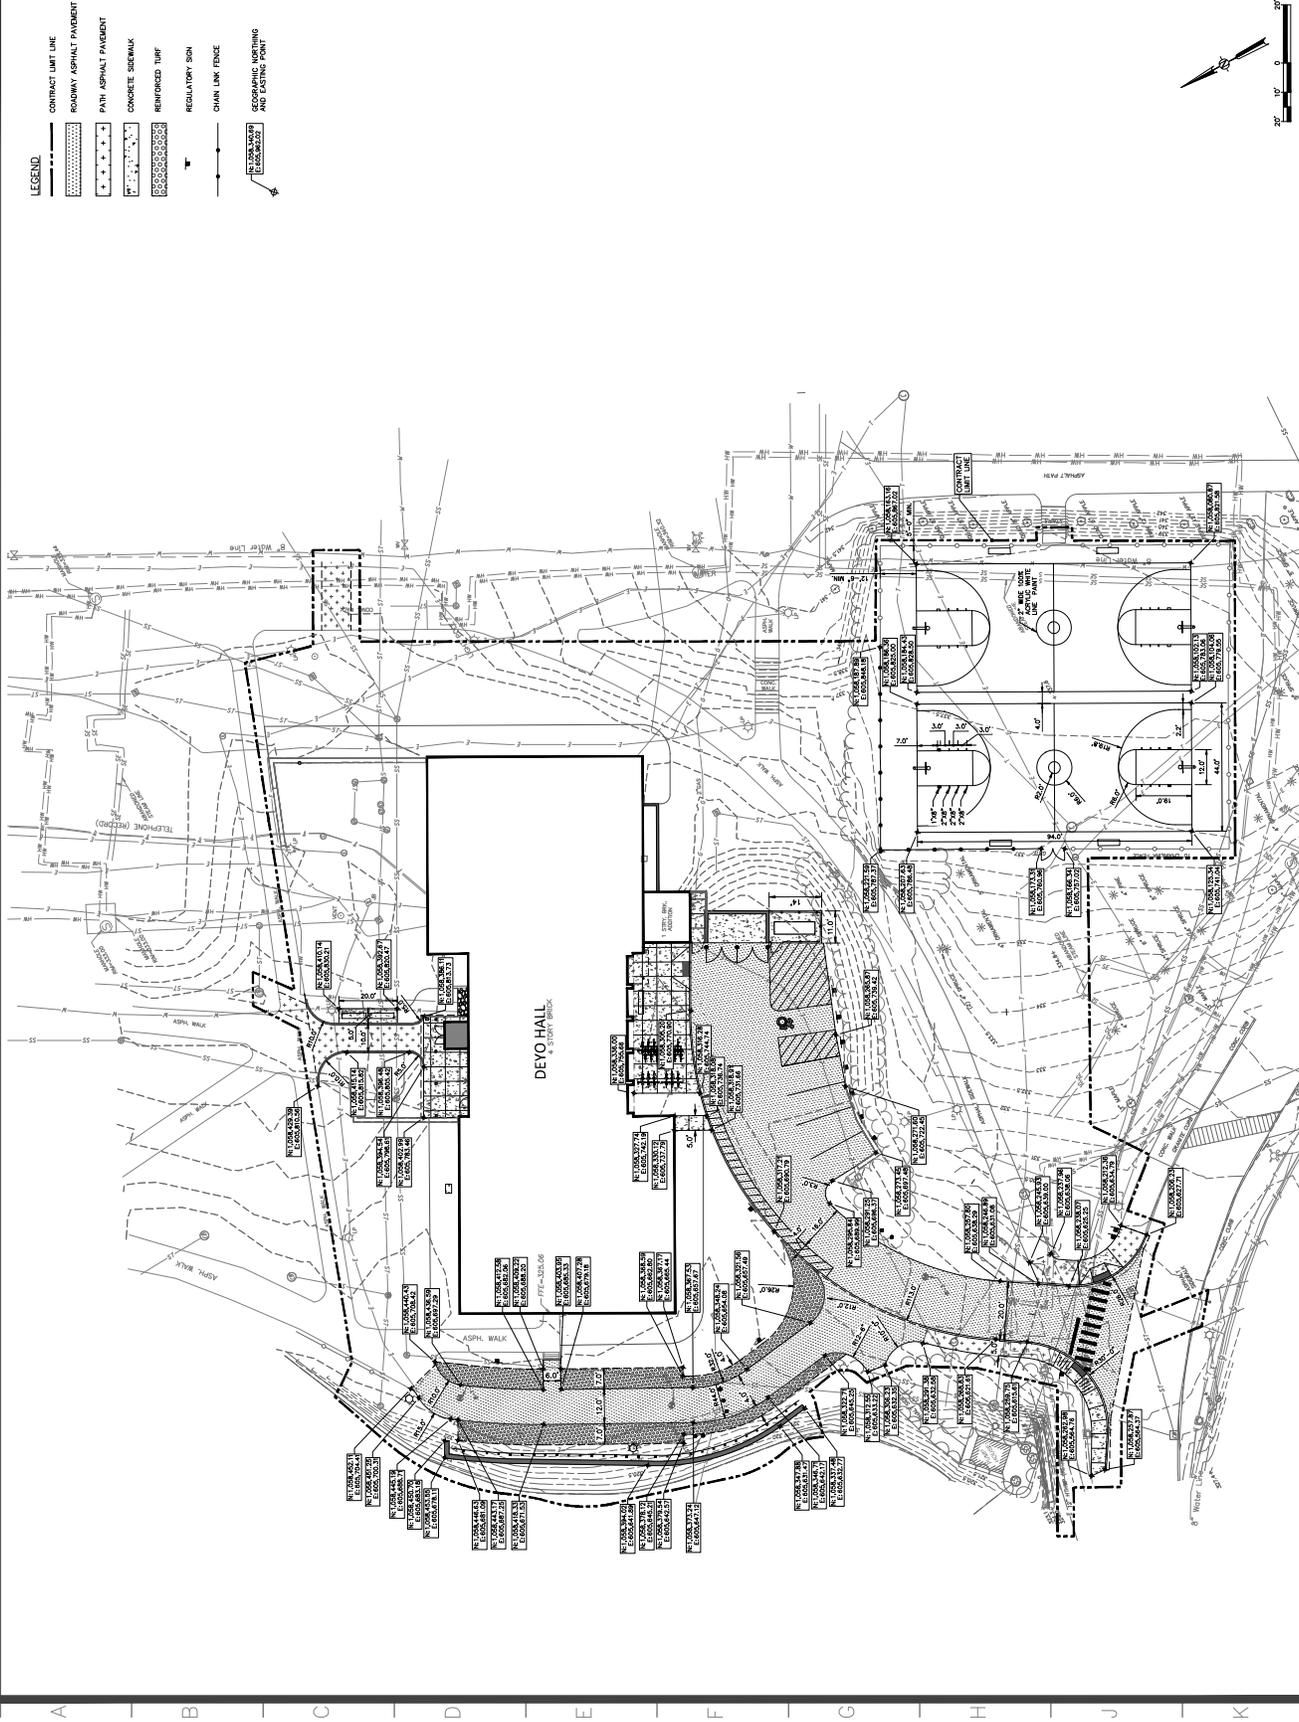REVISIONS	Description	Date

STATE UNIVERSITY OF  
NEW YORK AT NEW  
PALTZ  
**DEYO HALL  
REHABILITATION &  
UPPER FLOOR  
ADDITION**  
1 HAWK DRIVE NEW PALTZ, NEW YORK  
12561-0443

Phase  
BID DOCUMENTS  
UTILITY PLAN


Drawn By: Checked By: Date: 6-25-2018  
TEW SNM  
Scale: 1/8" = 1'-0"  
Sheet No. 341630  
Drawing No. C-130  
3/2018 AS NOTED



- UTILITY NOTES:**
1. THE PROPOSED STORM SEWER STRUCTURES AND PIPING ARE TO BE INSTALLED IN ACCORDANCE WITH THE SPECIFICATIONS AND DETAILS ACCUMULATED FROM CONSTRUCTION AND REVISED FROM THE PREVIOUS UTILITY PLAN. THE CONTRACTOR SHALL VERIFY THE LOCATION AND DEPTH OF ALL EXISTING UTILITIES IN ACCORDANCE WITH THE CITY RECORDS.
  2. THE CONTRACTOR SHALL VERIFY THE LOCATION AND DEPTH OF ALL EXISTING UTILITIES IN ACCORDANCE WITH THE CITY RECORDS.
  3. THIS UTILITY PLAN IS TO BE USED FOR CONSTRUCTION OF THE UTILITY STRUCTURES AND PIPING. IT IS NOT TO BE USED FOR ANY OTHER PURPOSES.
  4. REFER TO SHEET P001 FOR CONTINUATION OF THE UTILITY PLAN.
  5. REFER TO SHEET P002 FOR ALL EXISTING ELECTRICAL CONDUITS FEEDING EXTERIOR/PROPOSED FEATURES.
  6. MECHANICAL EQUIPMENT SHOWN FOR PLACEMENT ON THE UPPER FLOOR SHALL BE INSTALLED IN ACCORDANCE WITH THE MECHANICAL DESIGN INFORMATION INCLUDING POINTS OF CONNECTION TO INTERIOR SYSTEMS.
  7. NATURAL GAS CONDUITS AT BELOW FLOOR LEVEL SHALL BE INSTALLED IN ACCORDANCE WITH THE CITY RECORDS.
  8. CONTRACTOR SHALL COMPLETE TEST PITS AT ALL LOCATIONS OF UTILITIES.

- EXPOSED**
- CONTRACT LIMIT LINE
  - STORM SEWER
  - SANITARY SEWER
  - WATER LINE
  - NATURAL GAS MAIN
  - ELECTRICAL CONDUIT
  - DRAINAGE MANHOLE
  - DETAIL 7/2002
  - DETAIL 8/2002
  - WARD IRWIN
  - DETAIL 1/2002
  - DETAIL 3/2002
  - DETAIL 5/2002
  - FIRE HYDRANT

- NOTES:**
- 1. REFER TO SHEET P001 FOR THE UTILITY PLAN ADJACENT TO THE BUILDING.
  - 2. REFER TO SHEET P002 FOR THE UTILITY PLAN ADJACENT TO THE BUILDING.
  - 3. REFER TO SHEET P003 FOR THE UTILITY PLAN ADJACENT TO THE BUILDING.
  - 4. REFER TO SHEET P004 FOR THE UTILITY PLAN ADJACENT TO THE BUILDING.
  - 5. REFER TO SHEET P005 FOR THE UTILITY PLAN ADJACENT TO THE BUILDING.
  - 6. REFER TO SHEET P006 FOR THE UTILITY PLAN ADJACENT TO THE BUILDING.
  - 7. REFER TO SHEET P007 FOR THE UTILITY PLAN ADJACENT TO THE BUILDING.
  - 8. REFER TO SHEET P008 FOR THE UTILITY PLAN ADJACENT TO THE BUILDING.
  - 9. REFER TO SHEET P009 FOR THE UTILITY PLAN ADJACENT TO THE BUILDING.
  - 10. REFER TO SHEET P010 FOR THE UTILITY PLAN ADJACENT TO THE BUILDING.

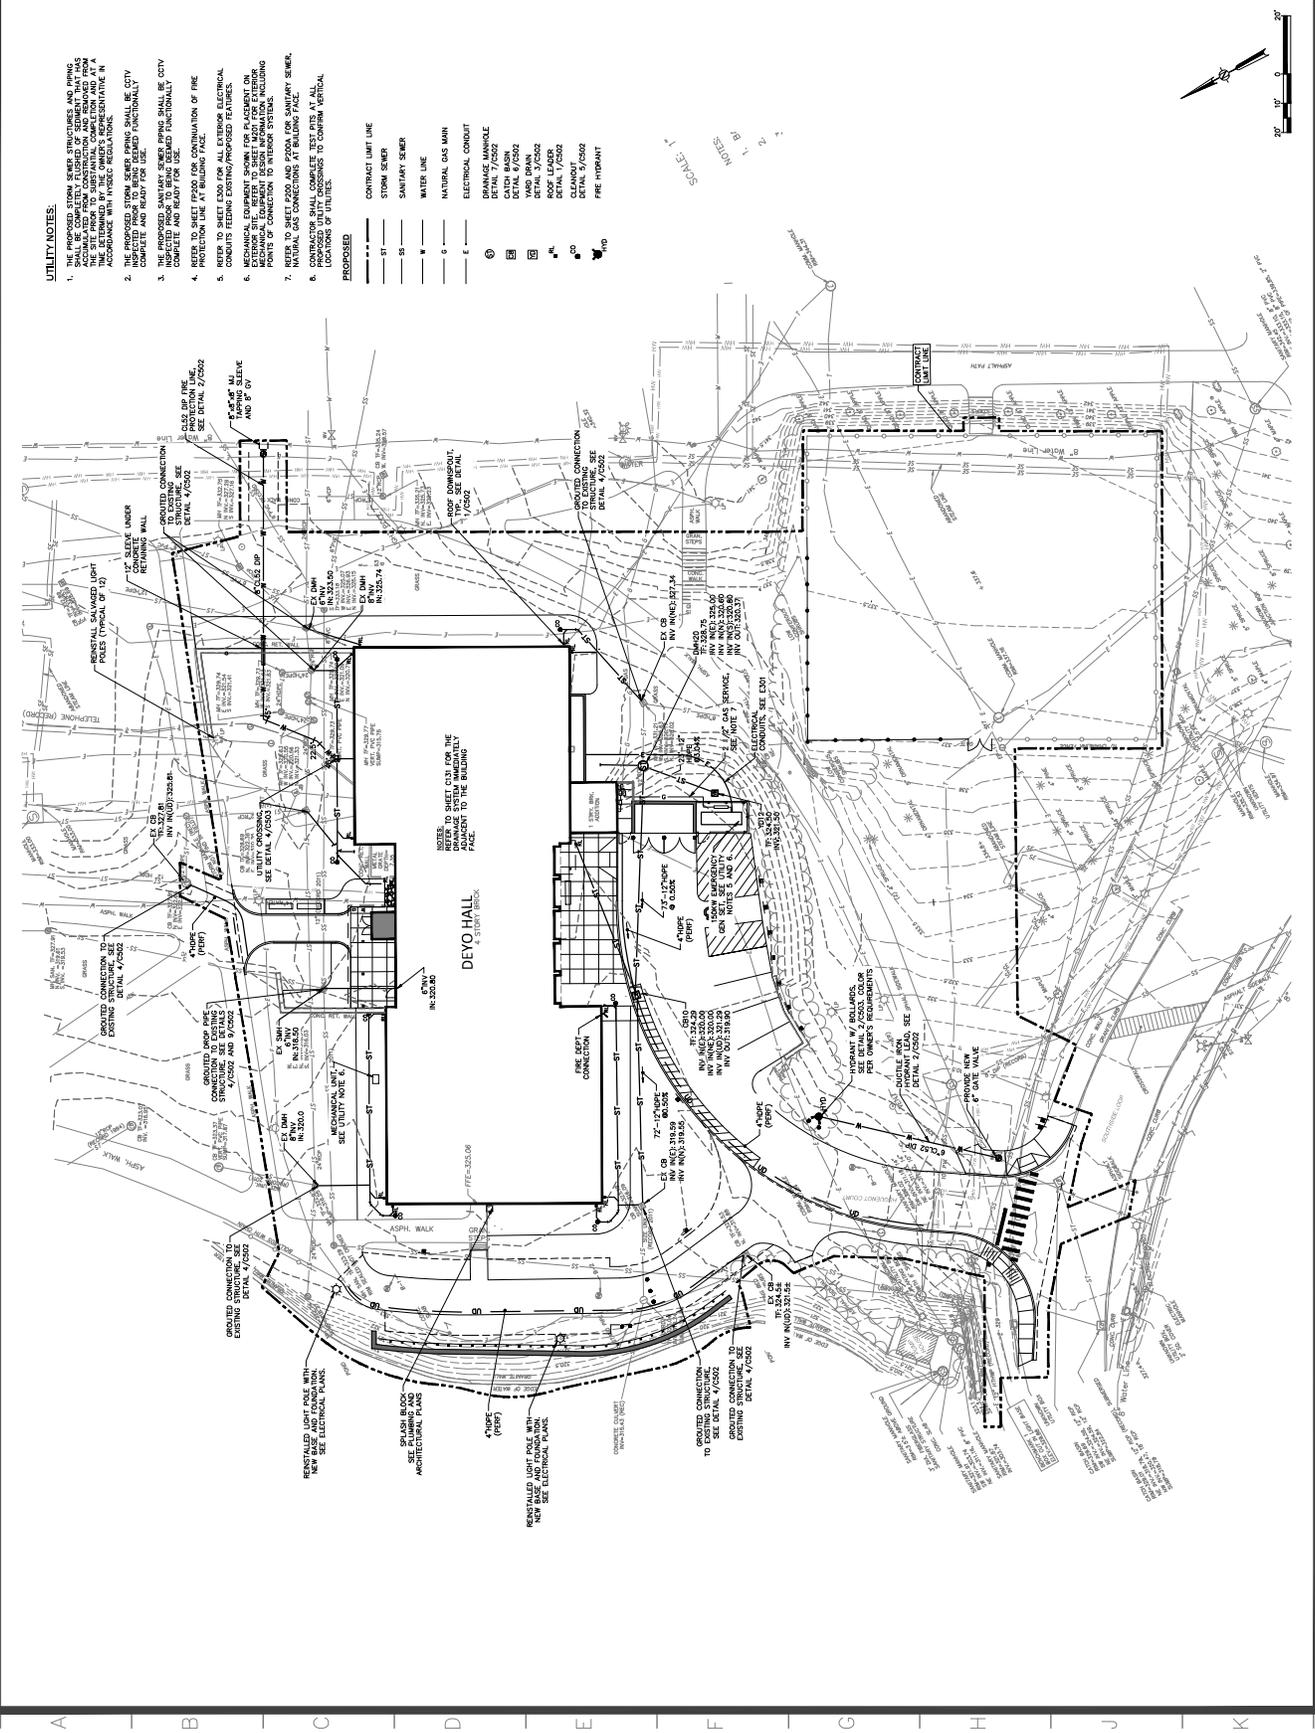



Project Key


REVISIONS

	Description	Date


Project Title  
**STATE UNIVERSITY OF NEW YORK AT NEW PALTZ**  
**DEYO HALL**  
**REHABILITATION & UPPER FLOOR ADDITION**  
 1 HAWK DRIVE NEW PALTZ, NEW YORK 12561-6243

Phase  
**BID DOCUMENTS**




**GRADING PLAN**

Drawn By: **TEW**  
 Checked By: **SNM**  
 Date: 6-25-2018  
 Scale: AS SHOWN  
 Drawing No: 341630  
 Project No: 14180

**C-140**  
 STATE OF NEW YORK  
 DEPARTMENT OF ENVIRONMENTAL CONSERVATION  
 DIVISION OF EMISSIONS  
 AIR QUALITY PERMITS  
 SCALE: AS NOTED

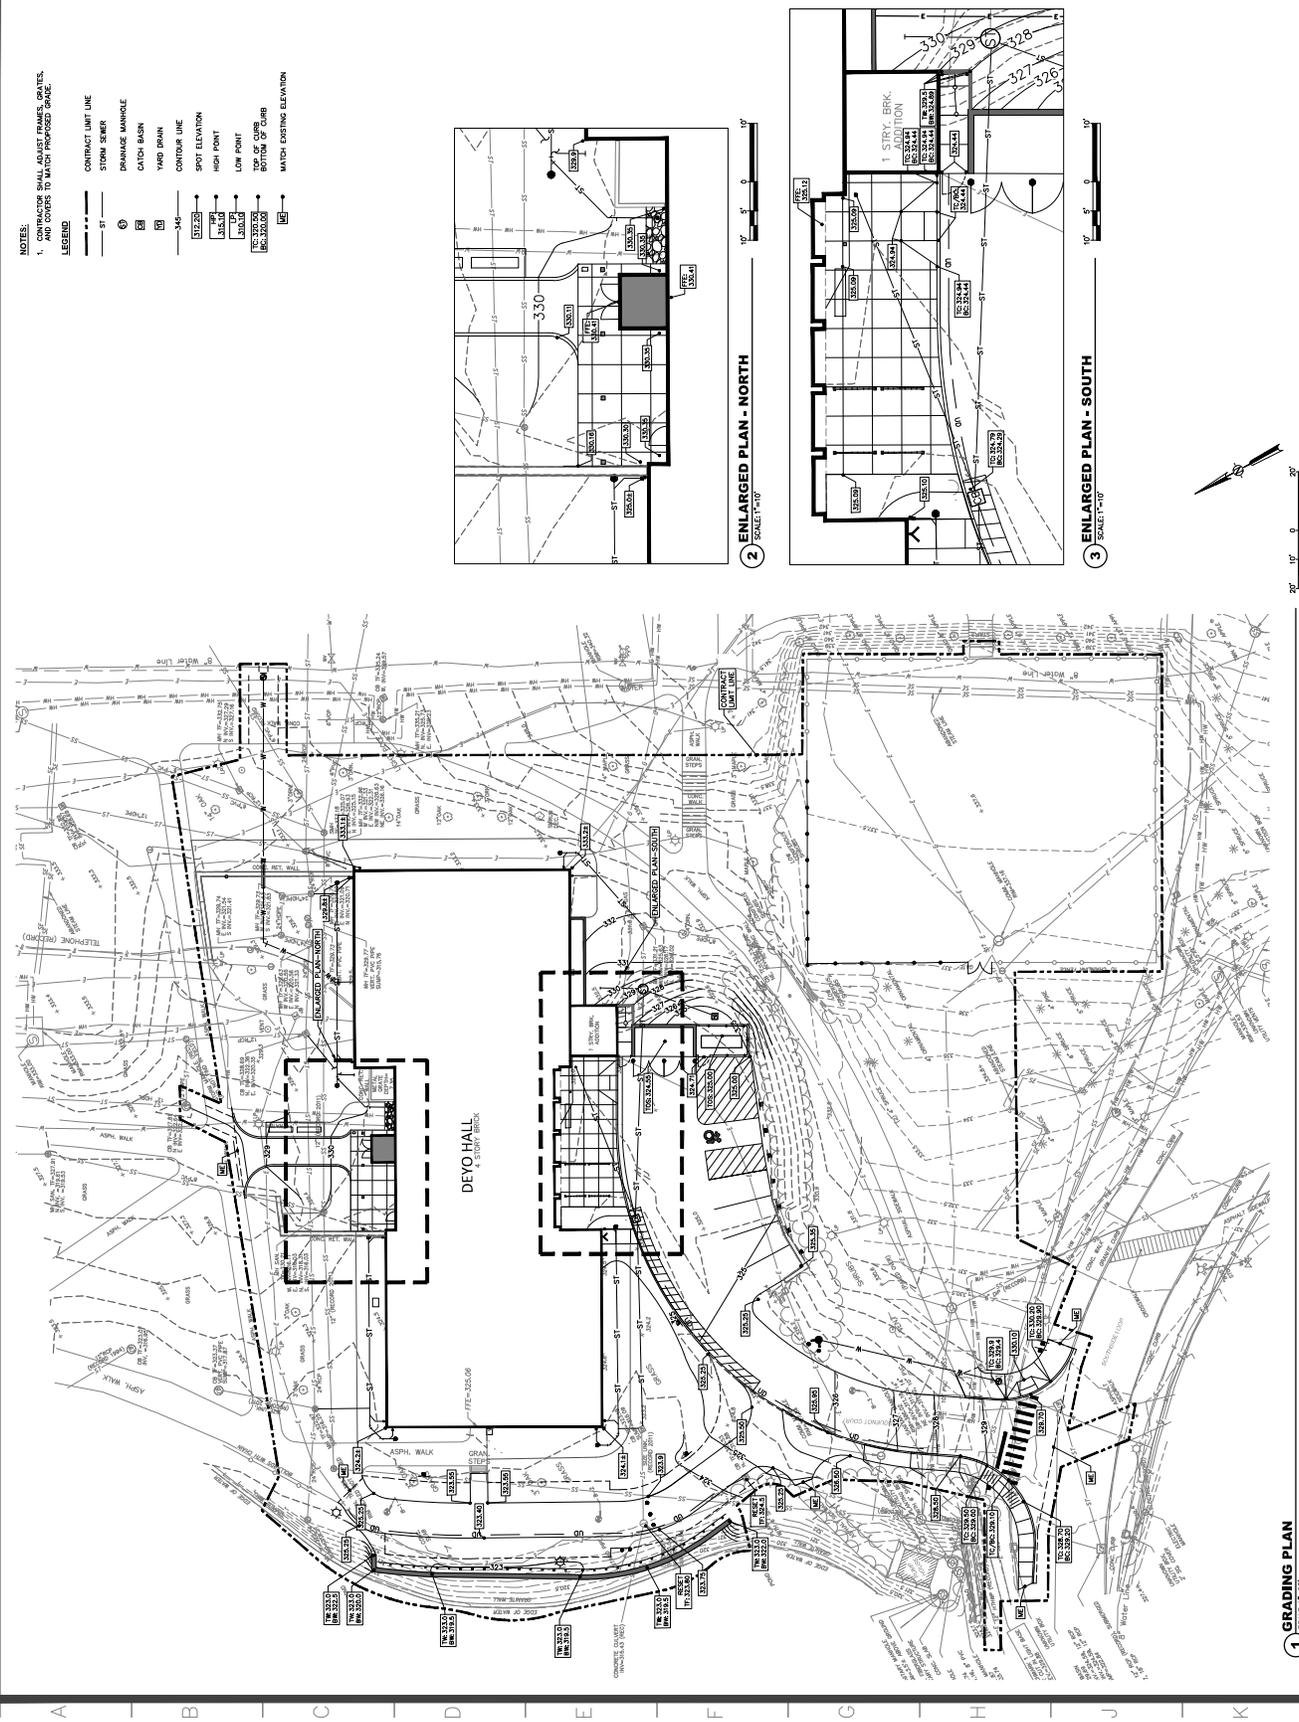

- NOTES:  
 1. CONTRACTOR SHALL ADJUST FRAMES, GRATES, AND COVERS TO MATCH PROPOSED GRADE.
- LEGEND
- CONTRACT UNIT LINE
  - STORM SEWER
  - DRAINAGE MANHOLE
  - CATCH BASIN
  - YARD DRAIN
  - CONTOUR LINE
  - SPOT ELEVATION
  - HIGH POINT
  - LOW POINT
  - BOTTOM OF CURB
  - MATCH LOSTING ELEVATION

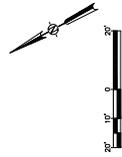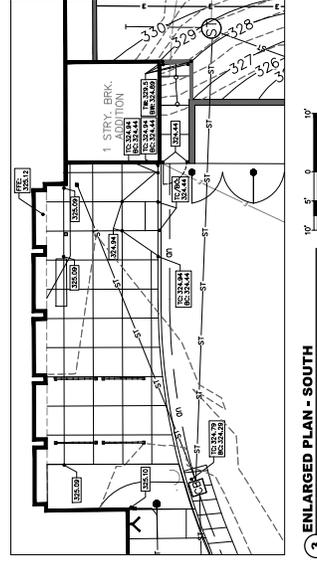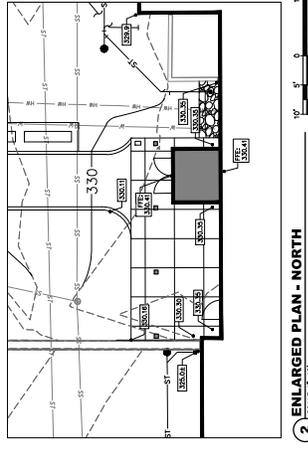

1 GRADING PLAN  
 SCALE: 1/4"=1'-0"

REVISIONS	Description	Date

Project Title  
**STATE UNIVERSITY OF NEW YORK AT NEW PALTZ**  
**DEYO HALL REHABILITATION & UPPER FLOOR ADDITION**  
 1 HAWK DRIVE NEW PALTZ, NEW YORK 12561-6243



Phase  
**BID DOCUMENTS**  
**EROSION AND SEDIMENT CONTROL PLAN**

Drawn By: Checked By: Date: **6-26-2018**  
 TEW SNM  
 State E. O'Connell DASNY Registration No. SA16530  
 Planning License No. C-150  
 State of New York  
 Surveyor License  
 Scale: AS NOTED

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- NOTES:**
- ALL CURBED AREAS TO RECEIVE TOPSOIL.
  - CONTRACTOR SHALL SHEEP SOFTSIDE LOOP ROAD ON A DETAILED BASIS AT ALL MINIMUM ARE AT ROADWAY INTERSECTIONS TO PRESENT THROUGHOUT OF SITE AND BEYOND FOR CONSTRUCTION PERIOD.

- LEGEND**
- CONTRACT LIMIT LINE
  - STORM SEWER
  - DRAINAGE MANHOLE
  - CATCH BASIN
  - WASH DRAIN
  - CONTOUR LINE
  - INLET PROTECTION
  - SILT FENCE
  - PILE PROTECTION



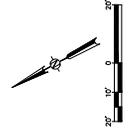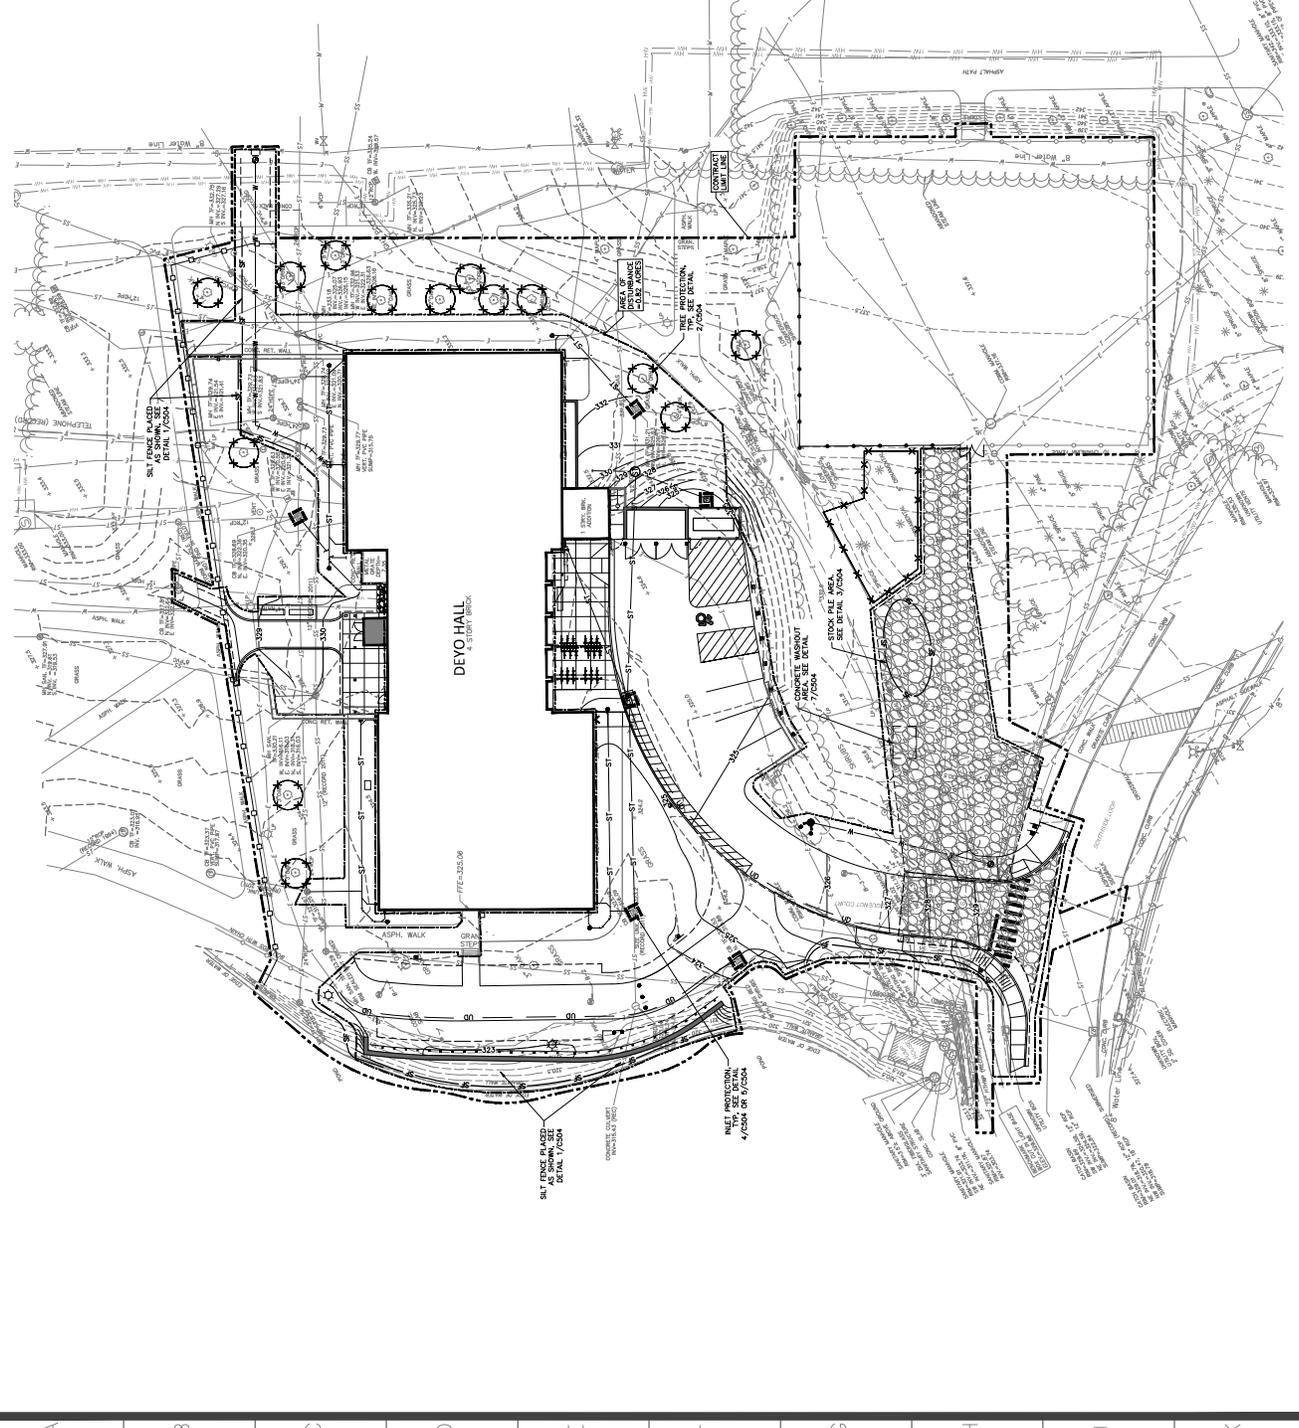









- NOTES:**
- THRUST BLOCKS SHALL ONLY BE USED FOR TEES. ALL OTHER FIELD BENDS SHALL USE FIELD CONNECTIONS.
  - CONCRETE SHALL NOT OVERLAP ANY JOINT.
  - THRUST BLOCKS SHALL BE CONSIDERED IN A MANNER THAT DOES NOT INTERFERE WITH REMOVAL OF INSTALLATION OF ANY JOINING COMPONENTS.
  - FOR REDUCERS, USE MECHANICAL JOINT FITTINGS WITH RETAINER GLANDS.
  - BEARING SURFACES SHALL WHERE POSSIBLE BE PLACED AGAINST UNDISTURBED SOIL. WHERE THAT IS NOT POSSIBLE, THE SURFACES SHALL BE PLACED AGAINST A MINIMUM 12" THICK CONCRETE THRUST BLOCK COMPARED TO A MINIMUM 6" THICK CONCRETE THRUST BLOCK.
  - BLOCK HEIGHT (H) SHALL BE EQUAL TO OR LESS THAN ONE-HALF THE TOTAL DEPTH TO THE UNDISTURBED SOIL (D). (SEE FIGURE 1 FOR DIMENSIONS)
  - BLOCK WIDTH (W) SHALL BE REBARED SUCH THAT THE CALCULATED BLOCK WIDTH (b) VARIES BETWEEN ONE AND TWO TIMES THE HEIGHT. (SEE FIGURE 1)
  - VALUES FOR TEES APPLY TO TEES, END PLUGS, CAPS, AND TAPPING SLEEVES.

BEARING SURFACES SHALL BE PLACED AGAINST UNDISTURBED SOIL. WHERE THAT IS NOT POSSIBLE, THE SURFACES SHALL BE PLACED AGAINST A MINIMUM 12" THICK CONCRETE THRUST BLOCK COMPARED TO A MINIMUM 6" THICK CONCRETE THRUST BLOCK.

SOIL TYPE	MINIMUM BEARING SURFACE WIDTH (INCHES)
STIFF CLAY	1,000
SOFT CLAY	1,500
SANDY SILT	2,000
SANDY CLAY	3,000
SAND	4,000

3. (W/2)(L) = 1/3




9. REQUIRED BEARING AREAS ARE DEVELOPED TO RESIST THRUSTS RESULTING FROM 150 PSI WORKING PRESSURE PLUS SOIL TO SOIL PRESSURE ALLOWANCE RESULTING IN 225 PSI TOTAL WORKING PRESSURE. BEARING AREAS ARE DEVELOPED TO RESIST THRUSTS RESULTING FROM 150 PSI WORKING PRESSURE PLUS SOIL TO SOIL PRESSURE ALLOWANCE RESULTING IN 225 PSI TOTAL WORKING PRESSURE. BEARING AREAS ARE DEVELOPED TO RESIST THRUSTS RESULTING FROM 150 PSI WORKING PRESSURE PLUS SOIL TO SOIL PRESSURE ALLOWANCE RESULTING IN 225 PSI TOTAL WORKING PRESSURE. BEARING AREAS ARE DEVELOPED TO RESIST THRUSTS RESULTING FROM 150 PSI WORKING PRESSURE PLUS SOIL TO SOIL PRESSURE ALLOWANCE RESULTING IN 225 PSI TOTAL WORKING PRESSURE.

**REQUIRED BEARING AREAS (SO. FT.) FOR BEARING BLOCKS\***

TEE SIZE (INCHES)	TEE	45° BEND	22-1/2° BEND	11-1/4° BEND
6	4.2	5.9	3.2	1.6
				0.8

\* FACTOR OF SAFETY = 3.0  
 SOIL BEARING OF 4,000 PSF  
 225 PSI WORKING PRESSURE  
 REQUIRED AREA (A) = 3W

**1 THRUST BLOCK**  
 SCALE: 1/8" = 1'-0"


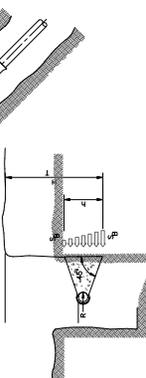
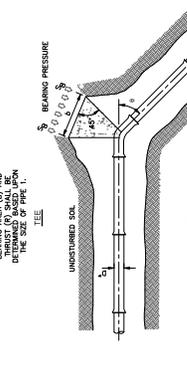
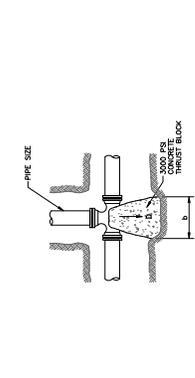


**2 TYPICAL HYDRANT INSTALLATION**  
 SCALE: 1/8" = 1'-0"




**3 THRUST RESTRAINT OPTIONS**  
 SCALE: 1/8" = 1'-0"


**THRUST REACTIONS (LB) PER 100PSI INTERNAL PRESSURE**

NOM. PIPE DIA. (IN)	END BEND	45° BEND	22-1/2° BEND	11-1/4° BEND
6	3,739	5,288	2,862	1,438
				733

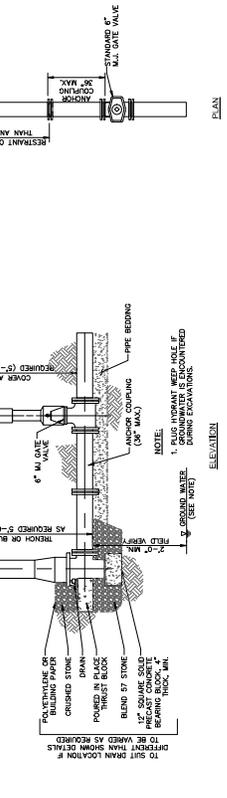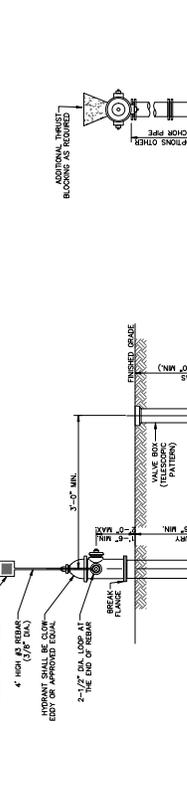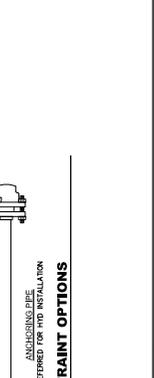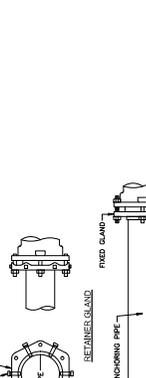


**4 WATER MAIN OFFSET**  
 SCALE: 1/8" = 1'-0"

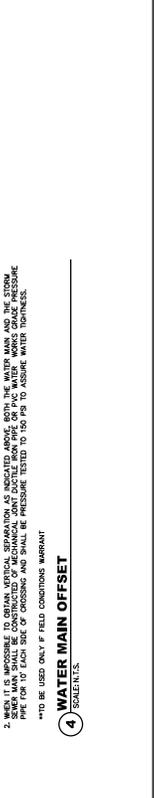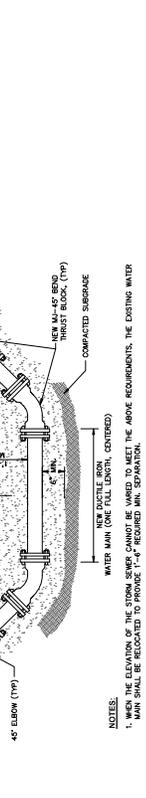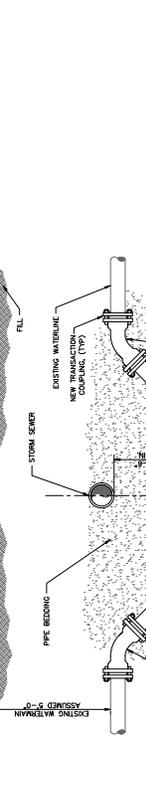

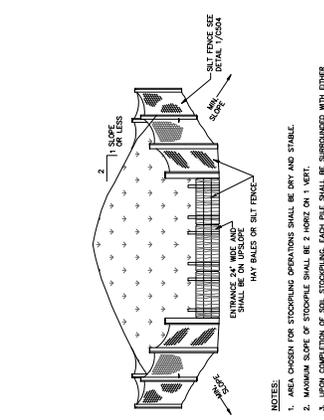

- NOTES:**
1. DESIGN FOR STOCKPILE OPERATIONS SHALL BE RY AND STABLE.
  2. MAXIMUM SLOPE OF STOCKPILE SHALL BE 2:1 HORIZONTAL TO 1 VERTICAL.
  3. UPON COMPLETION OF SOIL STOCKPILE, EACH FACE SHALL BE SURROUNDED WITH EITHER SILT FENCING OR HAY BALES, THEN STABILIZED WITH VEGETATION OR COVERED.


**1** TEMPORARY SOIL STOCKPILE  
SCALE: N.T.S.

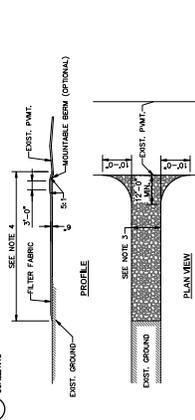


**2** VEGETATION PROTECTION FENCE DETAIL  
SCALE: N.T.S.




**3** STABILIZED CONSTRUCTION ENTRANCE DETAIL  
SCALE: N.T.S.

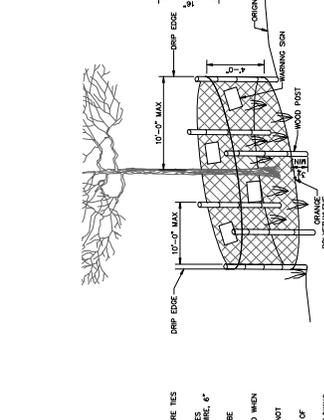


**4** IN-PAVEMENT TEMPORARY CATCH BASIN GRATE INLET FILTER  
SCALE: N.T.S.

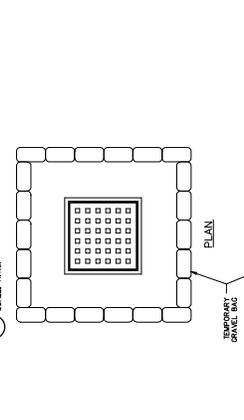


**5** CONCRETE WASHOUT AREA  
SCALE: N.T.S.

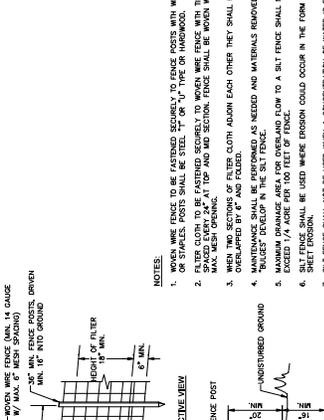


**6** TEMPORARY WASHOUT AREA  
SCALE: N.T.S.

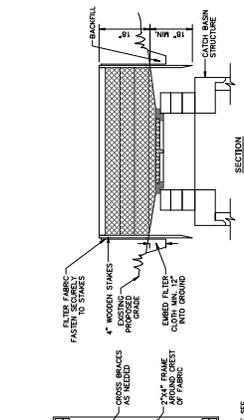

**7** TEMPORARY WASHOUT AREA  
SCALE: N.T.S.

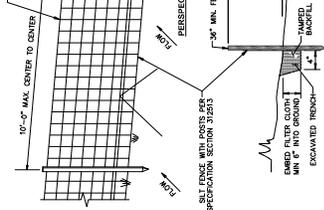

**8** TEMPORARY WASHOUT AREA  
SCALE: N.T.S.

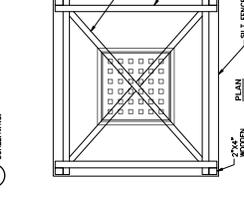

**9** TEMPORARY WASHOUT AREA  
SCALE: N.T.S.

**REVISIONS**

No.	Description	Date

Project Title  
**STATE UNIVERSITY OF  
NEW YORK AT NEW  
PALTZ  
DEYO HALL  
REHABILITATION &  
UPPER FLOOR  
ADDITION**

Phase  
**BID DOCUMENTS**

**EROSION CONTROL  
DETAILS**

Drawn By: **DAW** / Checked By: **DAW** / Date: **05-26-2018**  
 Title: **EROSION CONTROL DETAILS** / Scale: **AS NOTED**  
 Project No.: **C-504** / Drawing No.: **051000**  
 Revision: **05/26/2018**  
 Scale: **AS NOTED**

**NOTES:**

1. FILTER FABRIC SHALL HAVE AN EDS OF 40-85.
2. CUT FABRIC FROM CONTINUOUS ROLL TO ELIMINATE JOINTS. IF JOINTS ARE NEEDED, OVERLAP TO THE NEXT STAKE.
3. STAKE MATERIALS WILL BE STANDARD 2"x4" WOOD OR EQUIVALENT, WITH A MINIMUM LENGTH OF 3 FEET.
4. SPACE STAKES EVENLY AROUND INLET 3 FEET APART AND DRIVE MINIMUM 18" DEEP. SPANS GREATER THAN 3 FEET MAY BE BRIDGED WITH THE USE OF WIRE MESH BEHIND FABRIC FOR SUPPORT.
5. FABRIC SHALL BE EMBEDDED 1 FOOT MINIMUM BELOW GROUND AND BACKFILLED. IT SHALL BE SECURELY FASTENED TO THE STAKES AND FRAME.
6. A 2"x4" WOOD FRAME SHALL BE COMPLETED AROUND THE CREST OF THE FABRIC FOR OVERFLOW STABILITY.
7. MAXIMUM FRAME AREA IS 1.1 ACRES.
8. INLET PROTECTION SHALL BE COMPLETED WITHIN 14 DAYS OF THE START OF CONSTRUCTION.

**NOTES:**

1. GRAVEL BAGS SHALL BE INDIVIDUALLY TIED, DOUBLE SHAKED UP, AND JOINTS BETWEEN THE BAGS IN THIS INSTALLATION SHALL BE INCLUDED IN THE UNIT PRICE BID FOR THE ITEM.
2. SECTION (1) CALCULATED BAGS MEASUREMENTS SHALL BE CLEANED AND REPAIRED AS REQUIRED.
3. BAGS SHALL BE PLACED IN A LINE WITH THE STRUCTURE. BAGS SHALL BE DISPOSED OF AS UNSATURATED MATERIAL. SECTION (2) BAGS SHALL BE REPAIRED AS REQUIRED.
4. STRUCTURE MEETINGS SHALL BE LAID OUT AND MAINTAINED AS REQUIRED.

**NOTES:**

1. CONTAINMENT MUST BE STRUCTURALLY SOUND, LEAK FREE AND CONTAIN ALL LIQUID CONTAMINANTS.
2. CONTAINMENT DEVICES MUST BE OF SUFFICIENT QUANTITY OR VOLUME TO COMPLETELY CONTAIN THE LIQUID WASTE GENERATED.
3. WASHOUT IS TO BE LINED OR NEW FACILITIES CONSTRUCTED AND READY TO USE ONCE THE WASHOUT IS FULLY OPERATIONAL.
4. WASHOUT AREA(S) SHALL BE INSTALLED IN A LOCATION EASILY ACCESSIBLE BY CONCRETE TRUCKS.
5. WASHOUT AREA(S) SHALL BE INSTALLED IN A PROMINENT LOCATION AT THE CONSTRUCTION SITE AND MAY BE RELOCATED AS CONSTRUCTION PROGRESSES.
6. AT LEAST, MERELY REMOVE ACCUMULATION OF SAND AND AGGREGATE AND DISPOSE OF PROPERLY.

**MAINTENANCE:**

1. ALL CONCRETE WASHOUT FACILITIES SHALL BE INSPECTED DAILY FOR DAMAGE OR LEAKING.
2. WASHOUT FACILITIES SHALL BE MAINTAINED AND REPAIRED AS NECESSARY TO ENSURE PROPER OPERATION.
3. WASHOUT FACILITIES SHALL BE MAINTAINED AND REPAIRED AS NECESSARY TO ENSURE PROPER OPERATION.
4. WASHOUT FACILITIES SHALL BE MAINTAINED AND REPAIRED AS NECESSARY TO ENSURE PROPER OPERATION.
5. INSPECT THE PROJECT SITE FREQUENTLY TO ENSURE THAT NO CONCRETE DISCHARGES ARE TAKING PLACE IN NON-DESIGNATED AREAS.

**MAINTENANCE:**

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2. WASHOUT FACILITIES SHALL BE MAINTAINED AND REPAIRED AS NECESSARY TO ENSURE PROPER OPERATION.
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Project No. \_\_\_\_\_  
 Sheet No. \_\_\_\_\_ of \_\_\_\_\_  
 Date \_\_\_\_\_


**REVISIONS**

No.	Description	Date


STATE UNIVERSITY OF  
 NEW YORK AT NEW  
 PALTZ  
**DEYO HALL  
 REHABILITATION &  
 UPPER FLOOR  
 ADDITION**

Phase \_\_\_\_\_  
 BID DOCUMENTS  
 MISC. DETAILS


Drawn By: \_\_\_\_\_  
 Checked By: \_\_\_\_\_  
 Date: 05-20-2018  
 Title: C-505  
 Scale: AS NOTED

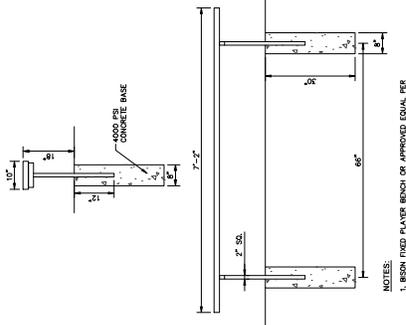


**NOTES:**  
 1. FINISH TO BE PROVIDED BETWEEN ALL ASPHALT COURSES.  
 2. MATERIAL REQUIREMENTS PER SPECIFICATION SECTION 321216 FOR PAVEMENT.

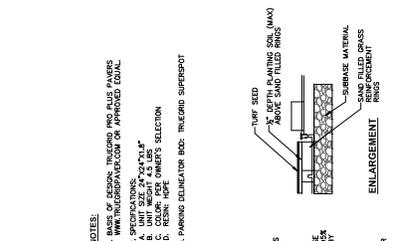


**NOTES:**  
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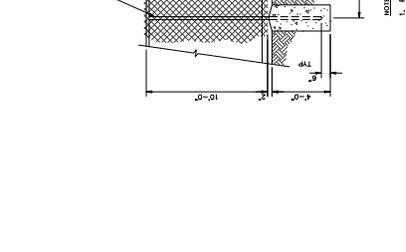
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 1. FINISH TO BE PROVIDED BETWEEN ALL ASPHALT COURSES.  
 2. MATERIAL REQUIREMENTS PER SPECIFICATION SECTION 321216 FOR PAVEMENT.

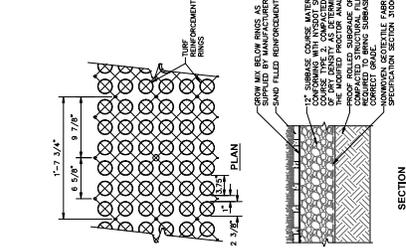



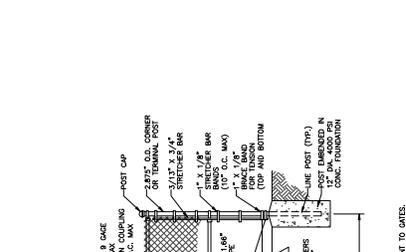



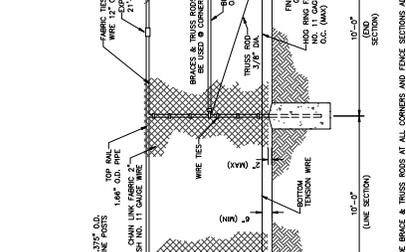







Project Key

REVISIONS	Description	Date

STATE UNIVERSITY OF  
 NEW YORK AT NEW  
 PALTZ  
**DEYO HALL  
 REHABILITATION  
 AND UPPER FLOOR  
 ADDITION**  
 1 HAWK DRIVE NEW PALTZ, NEW YORK  
 12561-2443

BID DOCUMENTS

**SECOND FLOOR  
 STRUCTURE PLAN**

Drawn By: **CD** / Checked By: **DM** / Date: **8-28-2018**  
 CDS / JAB  
 Seal & Signature: **DASNY Project # 1530**  
 Drawing Number: **S102**

Scale: As Indicated

- SECOND FLOOR STRUCTURE PLAN NOTES:**
1. PROVIDE REFERENCE ELEVATIONS FOR ALL TOP OF SLAB/BEAM/CEILING.
  2. TOP OF FINISH FLOOR IS ON THE FINISH FLOOR ABOVE THE REFERENCE ELEVATION/NOTE 1. THE REFERENCE ELEVATION/NOTE 1 IS THE FINISH FLOOR ABOVE THE REFERENCE ELEVATION/NOTE 1.
  3. TOP OF FINISH FLOOR IS ON THE FINISH FLOOR ABOVE THE REFERENCE ELEVATION/NOTE 1. THE REFERENCE ELEVATION/NOTE 1 IS THE FINISH FLOOR ABOVE THE REFERENCE ELEVATION/NOTE 1.
  4. ELEVATIONS OF HANDED STAIRS SHALL BE TO THE FINISH FLOOR ABOVE THE REFERENCE ELEVATION/NOTE 1.
  5. ELEVATIONS OF UNHANDED STAIRS SHALL BE TO THE FINISH FLOOR ABOVE THE REFERENCE ELEVATION/NOTE 1.
  6. USE COLUMN CENTERLINE FOR ALL COLUMN LOCATIONS UNLESS OTHERWISE NOTED.
  7. USE BEAM CENTERLINE FOR ALL BEAM LOCATIONS UNLESS OTHERWISE NOTED.
  8. USE WALL CENTERLINE FOR ALL WALL LOCATIONS UNLESS OTHERWISE NOTED.
  9. USE THE CENTERLINE OF THE COLUMN FOR ALL COLUMN LOCATIONS UNLESS OTHERWISE NOTED.
  10. USE THE CENTERLINE OF THE BEAM FOR ALL BEAM LOCATIONS UNLESS OTHERWISE NOTED.
  11. USE THE CENTERLINE OF THE WALL FOR ALL WALL LOCATIONS UNLESS OTHERWISE NOTED.
  12. USE THE CENTERLINE OF THE COLUMN FOR ALL COLUMN LOCATIONS UNLESS OTHERWISE NOTED.
  13. USE THE CENTERLINE OF THE BEAM FOR ALL BEAM LOCATIONS UNLESS OTHERWISE NOTED.
  14. USE THE CENTERLINE OF THE WALL FOR ALL WALL LOCATIONS UNLESS OTHERWISE NOTED.
  15. SEE NOTE ON SHEET FOR ADDITIONAL REQUIREMENTS.


**STRUCTURE PLAN NOTES:**

1. LOCAL CONCRETE SHALL BE USED FOR ALL CONCRETE WORK UNLESS OTHERWISE NOTED.
2. ALL CONCRETE SHALL BE CAST IN PLACE UNLESS OTHERWISE NOTED.
3. ALL CONCRETE SHALL BE CAST IN PLACE UNLESS OTHERWISE NOTED.
4. ALL CONCRETE SHALL BE CAST IN PLACE UNLESS OTHERWISE NOTED.
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14. ALL CONCRETE SHALL BE CAST IN PLACE UNLESS OTHERWISE NOTED.
15. ALL CONCRETE SHALL BE CAST IN PLACE UNLESS OTHERWISE NOTED.

**MASONRY WALL REVISIONS/DETAILS:**


NO.	DESCRIPTION	DATE
1	ADD MASONRY WALL REVISIONS/DETAILS	8/28/18
2	ADD MASONRY WALL REVISIONS/DETAILS	8/28/18
3	ADD MASONRY WALL REVISIONS/DETAILS	8/28/18
4	ADD MASONRY WALL REVISIONS/DETAILS	8/28/18
5	ADD MASONRY WALL REVISIONS/DETAILS	8/28/18
6	ADD MASONRY WALL REVISIONS/DETAILS	8/28/18
7	ADD MASONRY WALL REVISIONS/DETAILS	8/28/18
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12	ADD MASONRY WALL REVISIONS/DETAILS	8/28/18
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14	ADD MASONRY WALL REVISIONS/DETAILS	8/28/18
15	ADD MASONRY WALL REVISIONS/DETAILS	8/28/18

- MASONRY WALL REVISIONS/DETAILS:**
1. SEE PLAN FOR WALL REVISIONS/DETAILS.
  2. ALL WALLS SHALL BE CONSTRUCTED IN ACCORDANCE WITH THE REVISIONS/DETAILS.
  3. ALL WALLS SHALL BE CONSTRUCTED IN ACCORDANCE WITH THE REVISIONS/DETAILS.
  4. ALL WALLS SHALL BE CONSTRUCTED IN ACCORDANCE WITH THE REVISIONS/DETAILS.
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  15. ALL WALLS SHALL BE CONSTRUCTED IN ACCORDANCE WITH THE REVISIONS/DETAILS.

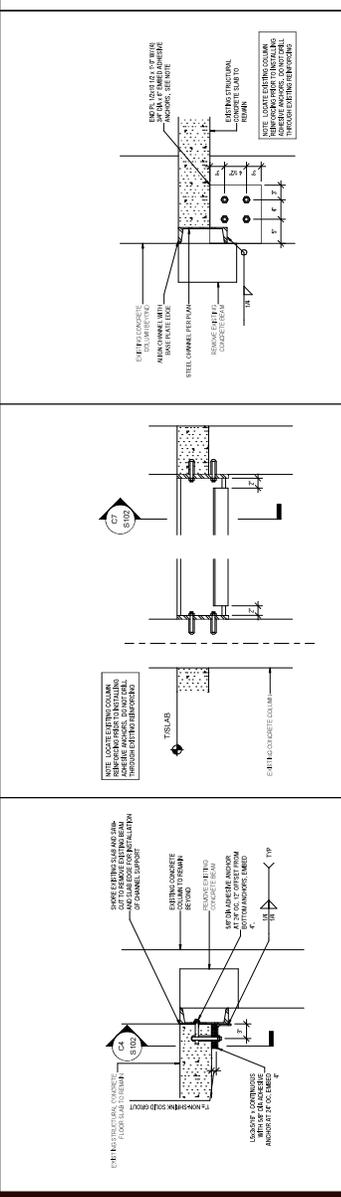

**C1 SECTION AT LIFT CHANNEL** SCALE: 1"=1'-0"  
**C4 CONNECTION DETAIL AT LIFT CHANNEL** SCALE: 1"=1'-0"  
**C7 SECTION AT LIFT CHANNEL** SCALE: 1"=1'-0"

- SECTION AT LIFT CHANNEL NOTES:**
1. PROVIDE REFERENCE ELEVATIONS FOR ALL TOP OF SLAB/BEAM/CEILING.
  2. TOP OF FINISH FLOOR IS ON THE FINISH FLOOR ABOVE THE REFERENCE ELEVATION/NOTE 1. THE REFERENCE ELEVATION/NOTE 1 IS THE FINISH FLOOR ABOVE THE REFERENCE ELEVATION/NOTE 1.
  3. TOP OF FINISH FLOOR IS ON THE FINISH FLOOR ABOVE THE REFERENCE ELEVATION/NOTE 1. THE REFERENCE ELEVATION/NOTE 1 IS THE FINISH FLOOR ABOVE THE REFERENCE ELEVATION/NOTE 1.
  4. ELEVATIONS OF HANDED STAIRS SHALL BE TO THE FINISH FLOOR ABOVE THE REFERENCE ELEVATION/NOTE 1.
  5. ELEVATIONS OF UNHANDED STAIRS SHALL BE TO THE FINISH FLOOR ABOVE THE REFERENCE ELEVATION/NOTE 1.
  6. USE COLUMN CENTERLINE FOR ALL COLUMN LOCATIONS UNLESS OTHERWISE NOTED.
  7. USE BEAM CENTERLINE FOR ALL BEAM LOCATIONS UNLESS OTHERWISE NOTED.
  8. USE WALL CENTERLINE FOR ALL WALL LOCATIONS UNLESS OTHERWISE NOTED.
  9. USE THE CENTERLINE OF THE COLUMN FOR ALL COLUMN LOCATIONS UNLESS OTHERWISE NOTED.
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  13. USE THE CENTERLINE OF THE BEAM FOR ALL BEAM LOCATIONS UNLESS OTHERWISE NOTED.
  14. USE THE CENTERLINE OF THE WALL FOR ALL WALL LOCATIONS UNLESS OTHERWISE NOTED.
  15. SEE NOTE ON SHEET FOR ADDITIONAL REQUIREMENTS.

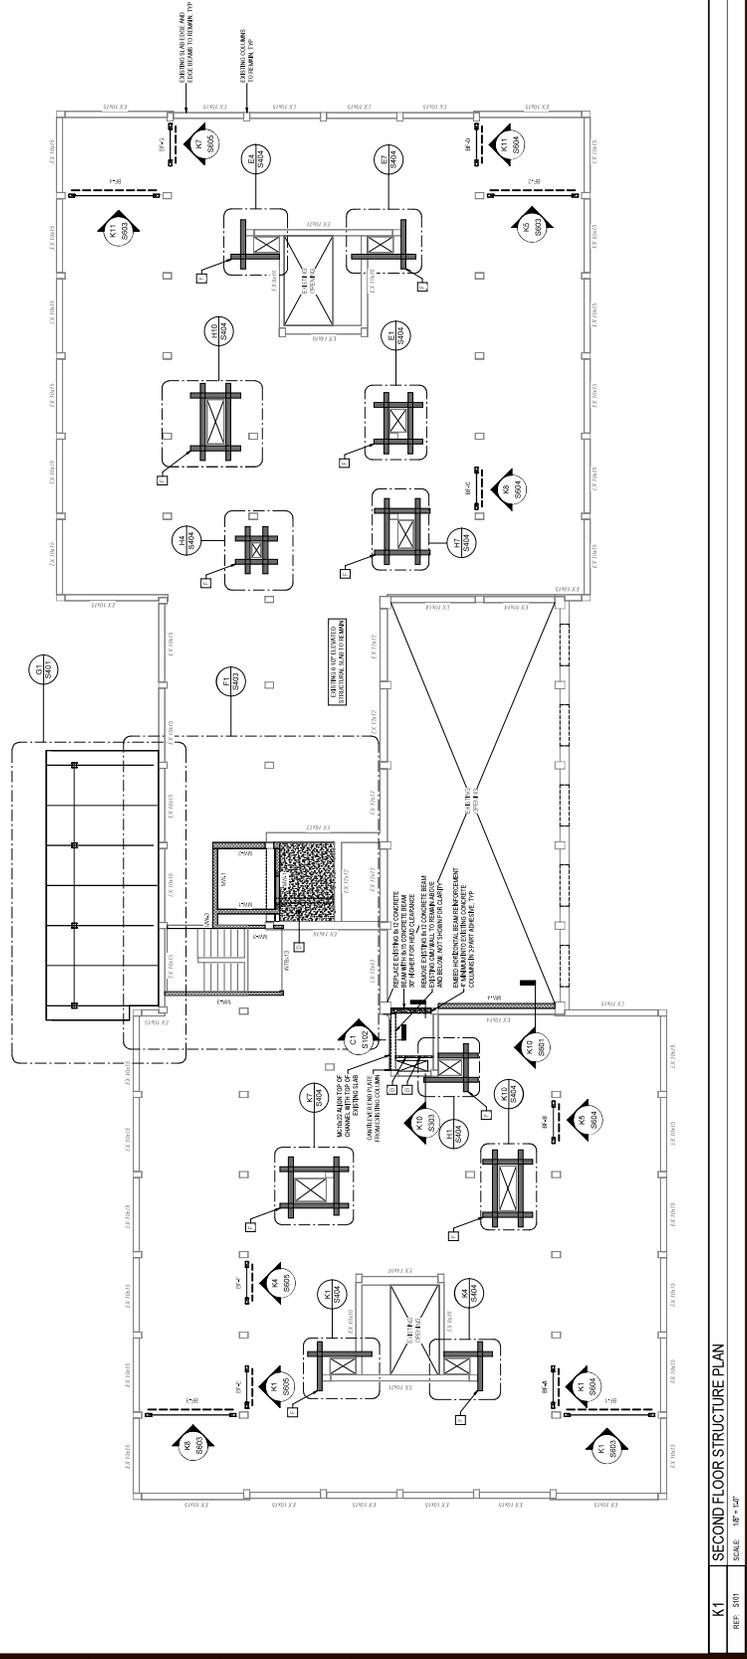

**K1 SECOND FLOOR STRUCTURE PLAN** SCALE: 1/8"=1'-0"



**REVISIONS**

Revision	Description	Date

**Phase**  
BID DOCUMENTS

**FOURTH FLOOR  
STRUCTURE PLAN**

Drawn By: **Chenxiyao** / Date: 8-26-2018  
CDS / Job: 8-26-2018  
Scale: E: 3/8"=1'-0" / Job: 3/4"=1'-0"  
Sheet: E: 3/8"=1'-0" / Job: 3/4"=1'-0"

Project Number: **S104**  
Scale: As Indicated



**REVISIONS**

Revision	Description	Date

**PROJECT NOTES**

1. SEE PLAN FOR WALL REVISIONS SCHEDULE.
2. SEE PLAN FOR WALL REVISIONS SCHEDULE.
3. SEE PLAN FOR WALL REVISIONS SCHEDULE.
4. SEE PLAN FOR WALL REVISIONS SCHEDULE.
5. SEE PLAN FOR WALL REVISIONS SCHEDULE.
6. SEE PLAN FOR WALL REVISIONS SCHEDULE.
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9. SEE PLAN FOR WALL REVISIONS SCHEDULE.
10. SEE PLAN FOR WALL REVISIONS SCHEDULE.
11. SEE PLAN FOR WALL REVISIONS SCHEDULE.
12. SEE PLAN FOR WALL REVISIONS SCHEDULE.

**STRUCTURAL PLAN NOTES**

1. ALL WALLS TO BE CONSTRUCTED WITH 8" CMU UNLESS OTHERWISE NOTED.
2. ALL WALLS TO BE CONSTRUCTED WITH 8" CMU UNLESS OTHERWISE NOTED.
3. ALL WALLS TO BE CONSTRUCTED WITH 8" CMU UNLESS OTHERWISE NOTED.
4. ALL WALLS TO BE CONSTRUCTED WITH 8" CMU UNLESS OTHERWISE NOTED.
5. ALL WALLS TO BE CONSTRUCTED WITH 8" CMU UNLESS OTHERWISE NOTED.
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11. ALL WALLS TO BE CONSTRUCTED WITH 8" CMU UNLESS OTHERWISE NOTED.
12. ALL WALLS TO BE CONSTRUCTED WITH 8" CMU UNLESS OTHERWISE NOTED.

**FOUNDATION NOTES**

1. ALL FOUNDATIONS TO BE CONSTRUCTED WITH 12" CONCRETE UNLESS OTHERWISE NOTED.
2. ALL FOUNDATIONS TO BE CONSTRUCTED WITH 12" CONCRETE UNLESS OTHERWISE NOTED.
3. ALL FOUNDATIONS TO BE CONSTRUCTED WITH 12" CONCRETE UNLESS OTHERWISE NOTED.
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11. ALL FOUNDATIONS TO BE CONSTRUCTED WITH 12" CONCRETE UNLESS OTHERWISE NOTED.
12. ALL FOUNDATIONS TO BE CONSTRUCTED WITH 12" CONCRETE UNLESS OTHERWISE NOTED.

**ROOFING NOTES**

1. ALL ROOFING TO BE CONSTRUCTED WITH 2" POLYSTYRENE INSULATION UNLESS OTHERWISE NOTED.
2. ALL ROOFING TO BE CONSTRUCTED WITH 2" POLYSTYRENE INSULATION UNLESS OTHERWISE NOTED.
3. ALL ROOFING TO BE CONSTRUCTED WITH 2" POLYSTYRENE INSULATION UNLESS OTHERWISE NOTED.
4. ALL ROOFING TO BE CONSTRUCTED WITH 2" POLYSTYRENE INSULATION UNLESS OTHERWISE NOTED.
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7. ALL ROOFING TO BE CONSTRUCTED WITH 2" POLYSTYRENE INSULATION UNLESS OTHERWISE NOTED.
8. ALL ROOFING TO BE CONSTRUCTED WITH 2" POLYSTYRENE INSULATION UNLESS OTHERWISE NOTED.
9. ALL ROOFING TO BE CONSTRUCTED WITH 2" POLYSTYRENE INSULATION UNLESS OTHERWISE NOTED.
10. ALL ROOFING TO BE CONSTRUCTED WITH 2" POLYSTYRENE INSULATION UNLESS OTHERWISE NOTED.
11. ALL ROOFING TO BE CONSTRUCTED WITH 2" POLYSTYRENE INSULATION UNLESS OTHERWISE NOTED.
12. ALL ROOFING TO BE CONSTRUCTED WITH 2" POLYSTYRENE INSULATION UNLESS OTHERWISE NOTED.

**MECHANICAL NOTES**

1. ALL MECHANICAL SYSTEMS TO BE INSTALLED IN ACCORDANCE WITH THE MECHANICAL SPECIFICATIONS.
2. ALL MECHANICAL SYSTEMS TO BE INSTALLED IN ACCORDANCE WITH THE MECHANICAL SPECIFICATIONS.
3. ALL MECHANICAL SYSTEMS TO BE INSTALLED IN ACCORDANCE WITH THE MECHANICAL SPECIFICATIONS.
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9. ALL MECHANICAL SYSTEMS TO BE INSTALLED IN ACCORDANCE WITH THE MECHANICAL SPECIFICATIONS.
10. ALL MECHANICAL SYSTEMS TO BE INSTALLED IN ACCORDANCE WITH THE MECHANICAL SPECIFICATIONS.
11. ALL MECHANICAL SYSTEMS TO BE INSTALLED IN ACCORDANCE WITH THE MECHANICAL SPECIFICATIONS.
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**ELECTRICAL NOTES**


1. ALL ELECTRICAL SYSTEMS TO BE INSTALLED IN ACCORDANCE WITH THE ELECTRICAL SPECIFICATIONS.
2. ALL ELECTRICAL SYSTEMS TO BE INSTALLED IN ACCORDANCE WITH THE ELECTRICAL SPECIFICATIONS.
3. ALL ELECTRICAL SYSTEMS TO BE INSTALLED IN ACCORDANCE WITH THE ELECTRICAL SPECIFICATIONS.
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11. ALL ELECTRICAL SYSTEMS TO BE INSTALLED IN ACCORDANCE WITH THE ELECTRICAL SPECIFICATIONS.
12. ALL ELECTRICAL SYSTEMS TO BE INSTALLED IN ACCORDANCE WITH THE ELECTRICAL SPECIFICATIONS.

**PLUMBING NOTES**

1. ALL PLUMBING SYSTEMS TO BE INSTALLED IN ACCORDANCE WITH THE PLUMBING SPECIFICATIONS.
2. ALL PLUMBING SYSTEMS TO BE INSTALLED IN ACCORDANCE WITH THE PLUMBING SPECIFICATIONS.
3. ALL PLUMBING SYSTEMS TO BE INSTALLED IN ACCORDANCE WITH THE PLUMBING SPECIFICATIONS.
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10. ALL PLUMBING SYSTEMS TO BE INSTALLED IN ACCORDANCE WITH THE PLUMBING SPECIFICATIONS.
11. ALL PLUMBING SYSTEMS TO BE INSTALLED IN ACCORDANCE WITH THE PLUMBING SPECIFICATIONS.
12. ALL PLUMBING SYSTEMS TO BE INSTALLED IN ACCORDANCE WITH THE PLUMBING SPECIFICATIONS.

**FINISHES NOTES**

1. ALL FINISHES TO BE CONSTRUCTED IN ACCORDANCE WITH THE FINISHES SPECIFICATIONS.
2. ALL FINISHES TO BE CONSTRUCTED IN ACCORDANCE WITH THE FINISHES SPECIFICATIONS.
3. ALL FINISHES TO BE CONSTRUCTED IN ACCORDANCE WITH THE FINISHES SPECIFICATIONS.
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12. ALL FINISHES TO BE CONSTRUCTED IN ACCORDANCE WITH THE FINISHES SPECIFICATIONS.

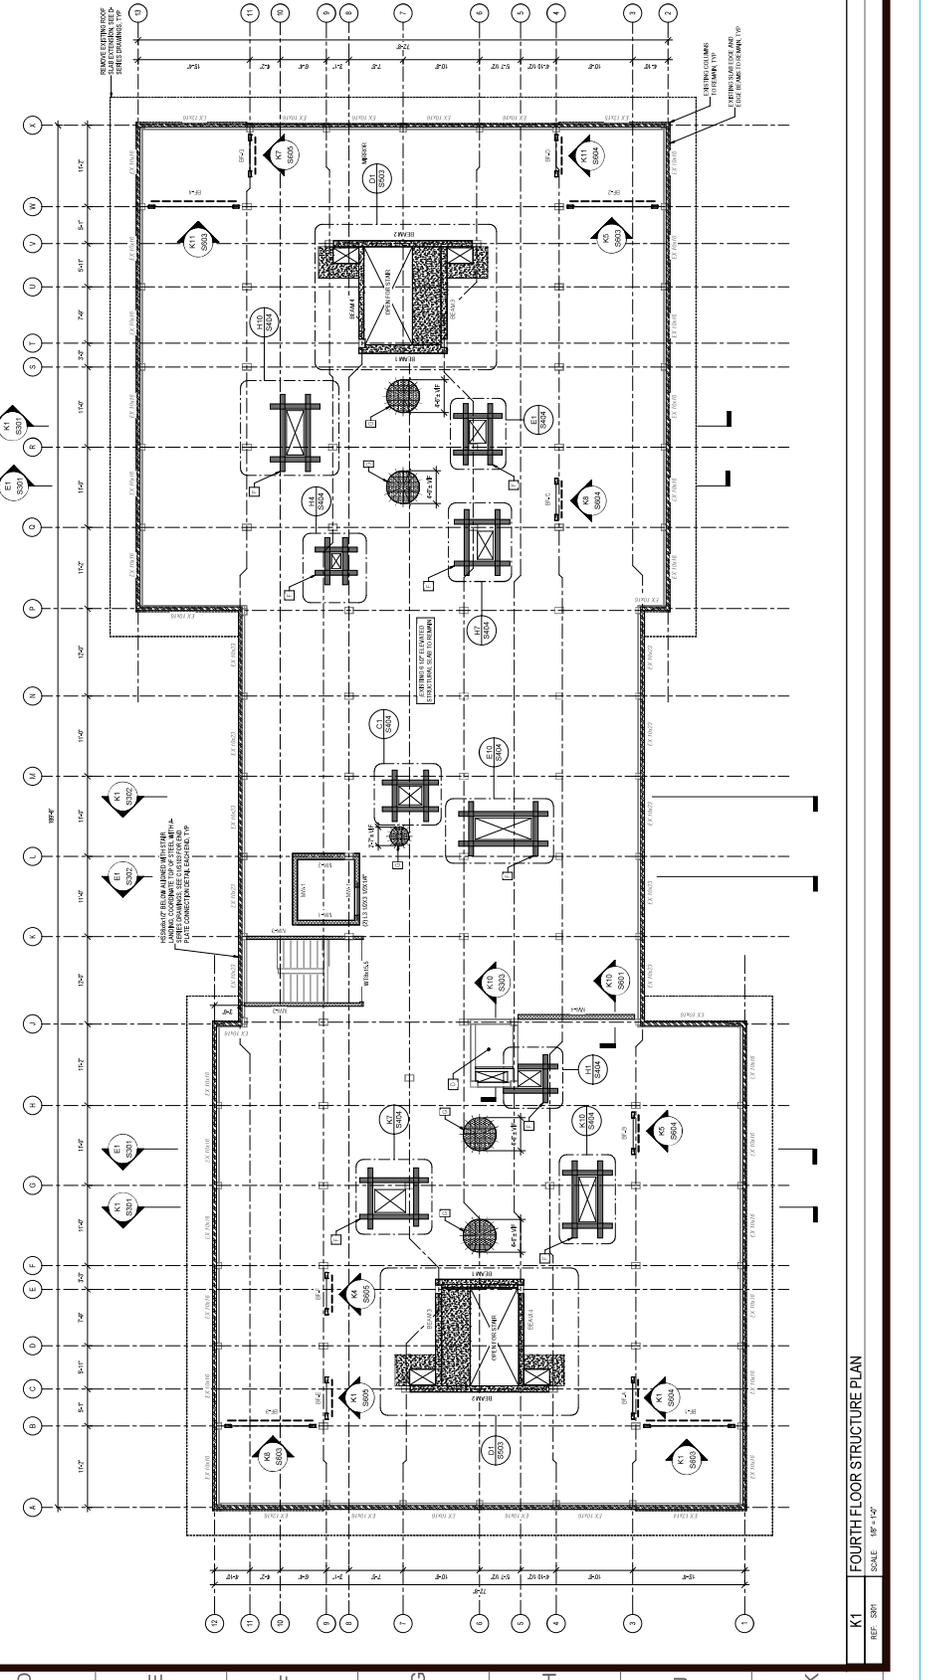

**K1 FOURTH FLOOR STRUCTURE PLAN**  
SCALE: 1/4"=1'-0"







Project Key

REVISIONS	Description	Date

STATE UNIVERSITY OF  
 NEW YORK AT  
**DEYO HALL  
 REHABILITATION  
 AND UPPER FLOOR  
 ADDITION**  
 1 HAWK DRIVE NEW PALTZ, NEW YORK  
 12561-2443

Phase


BID DOCUMENTS

Drawn By: **CD** / Checked By: **DM** / 8-28-2018  
 CDS / JAB  
 Scale: As Shown / DASHY Project No: 341830  
 Seal: E. Szymanski / Drawing Number




**S301**  
 Scale: 1/4" = 1'-0"

1 2 3 4 5 6 7 8 9 10 11 12 13

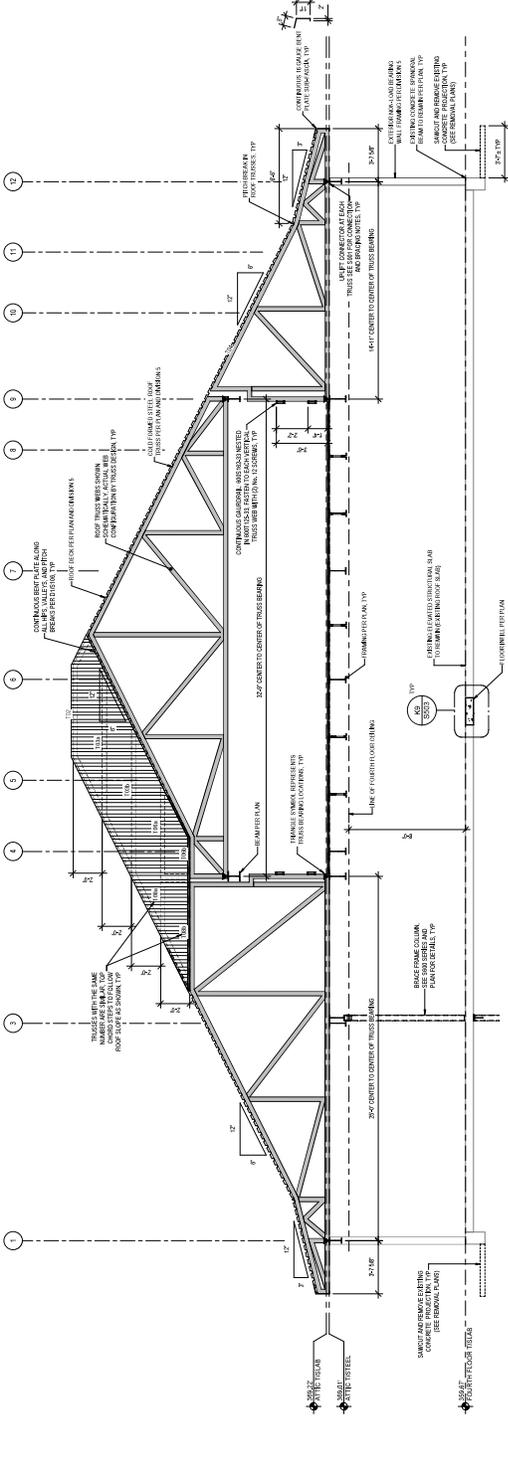

E1 SECTION AT FOURTH FLOOR AND ATTIC FRAMING

REF: S104 SCALE: 1/8" = 1'-0"

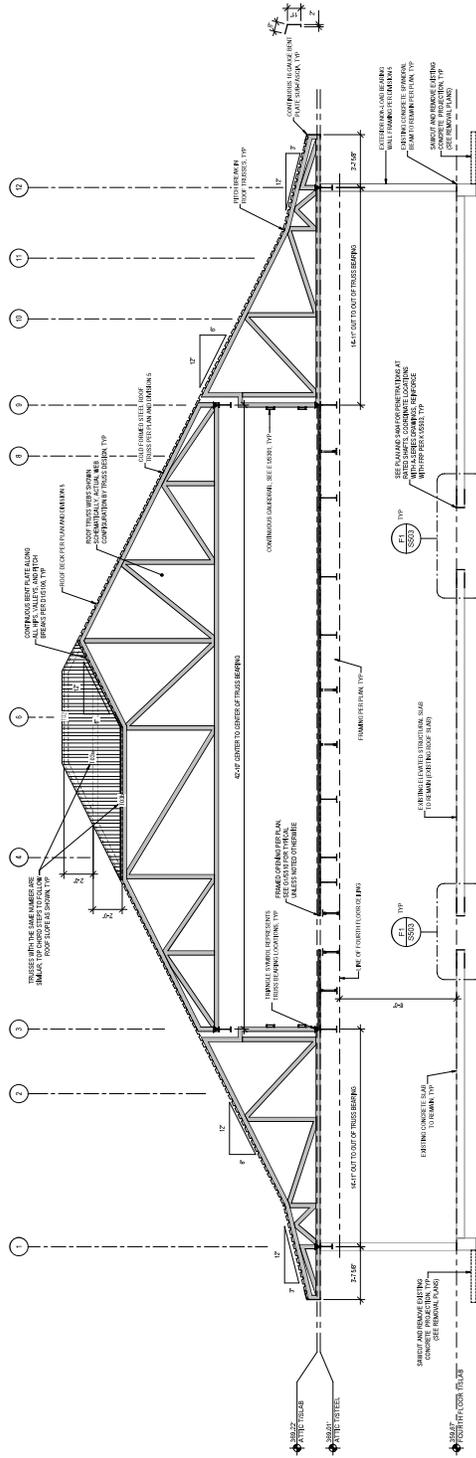

K1 SECTION AT FOURTH FLOOR AND ATTIC FRAMING

REF: S104 SCALE: 1/8" = 1'-0"



Project Key

REVISIONS	Description	Date

STATE UNIVERSITY OF  
 NEW YORK AT NEW  
 PALZ  
**DEYO HALL  
 REHABILITATION  
 AND UPPER FLOOR  
 ADDITION**  
 1 HAWK DRIVE NEW PALZ, NEW YORK  
 12561-2443

Phase

BID DOCUMENTS


SECTIONS

Drawn By: **CD** / Checked By: **DM** / Date: **8-28-2018**  
 CDS / JAB  
 Scale: As Shown  
 DASNY Project No: **341830**  
 Scale: As Shown  
 Drawing Number




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1 2 3 4 5 6 7 8 9 10 11 12 13

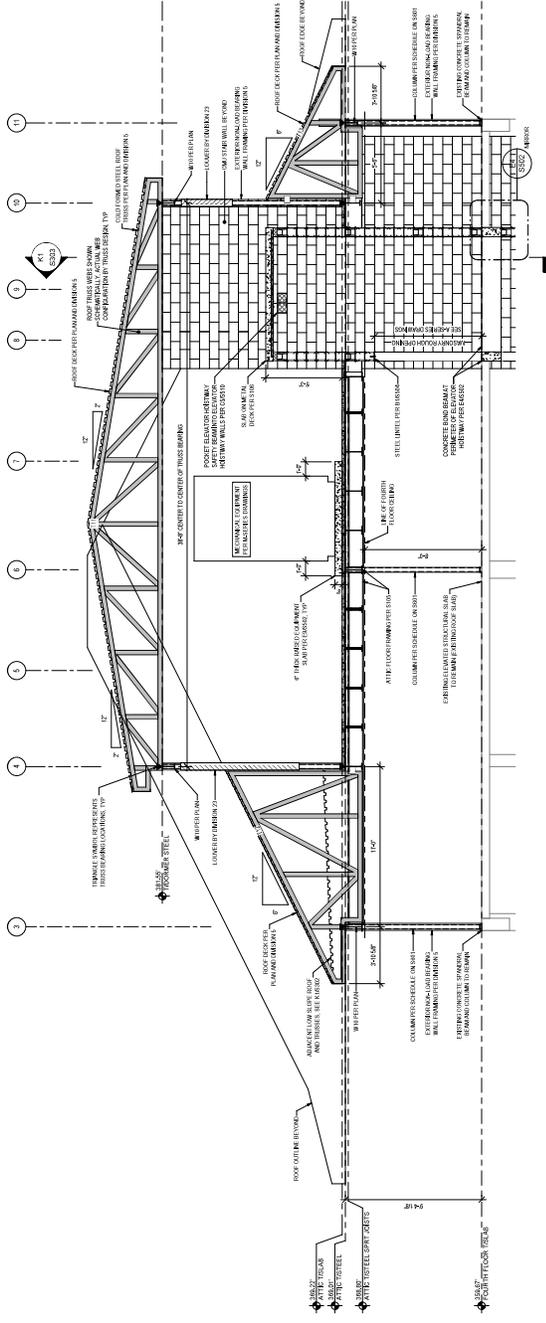

E1 SECTION AT ATTIC LOOKING WEST

REF: S04 SCALE: 1/4" = 1'-0"

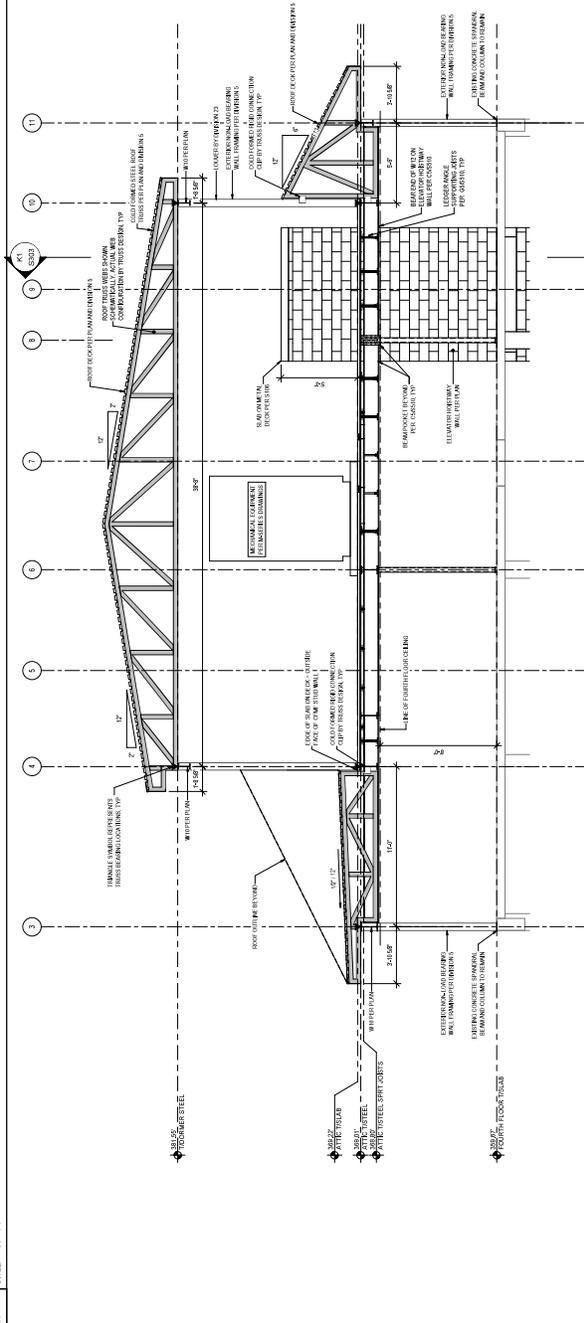

K1 SECTION AT PENTHOUSE

REF: S04 SCALE: 1/4" = 1'-0"















Project Key


REVISIONS	Date

STATE UNIVERSITY OF  
NEW YORK AT NEW  
PALTZ  
**DEYO HALL  
REHABILITATION  
AND UPPER FLOOR  
ADDITION**  
1 HAWK DRIVE NEW PALTZ, NEW YORK  
12561-2443

BID DOCUMENTS


























**SECTIONS AND DETAILS**

Drawn By: **DAW**  
Checked By: **DAW**  
Job No: **8-20-2018**  
Project No: **341830**  
Scale: **AS INDICATED**

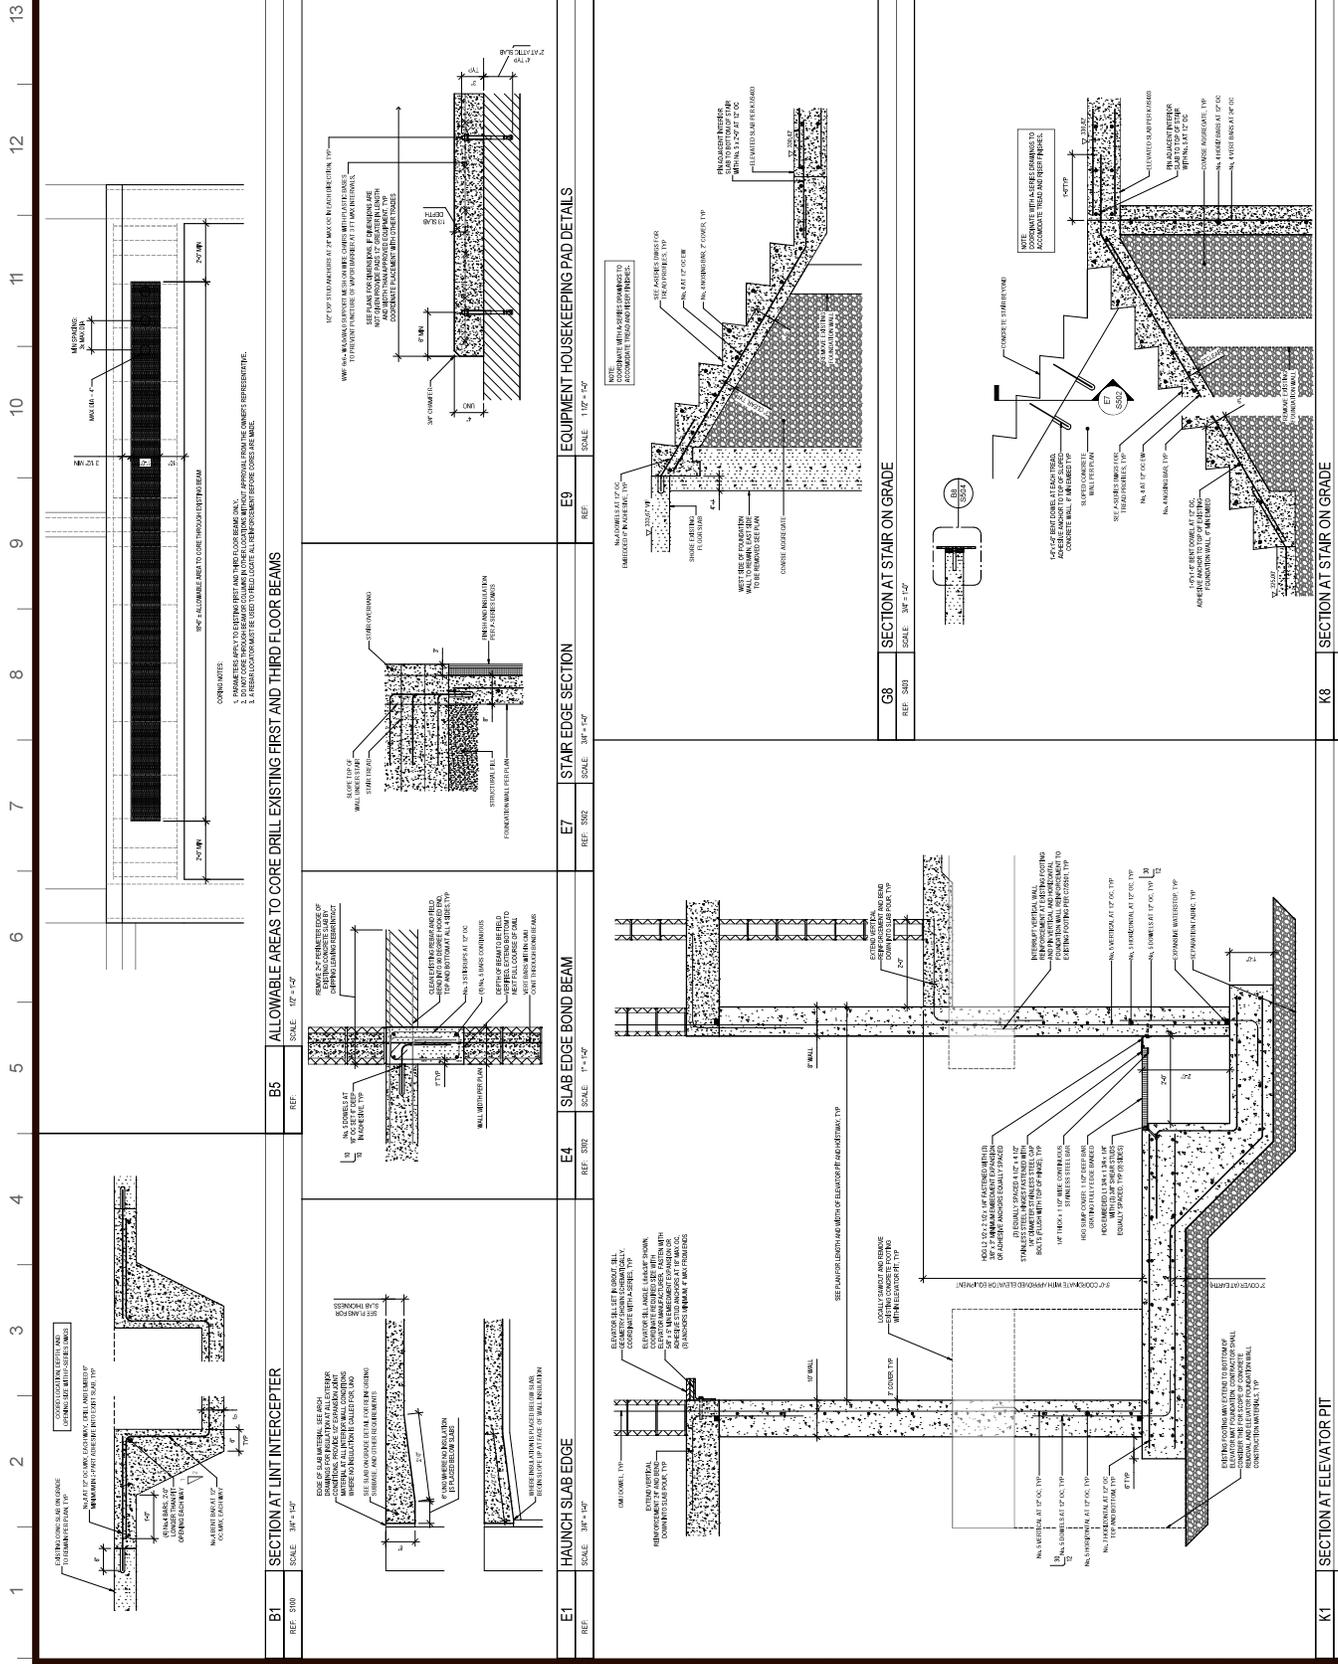



REVISIONS	Description	Date

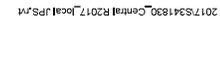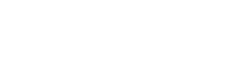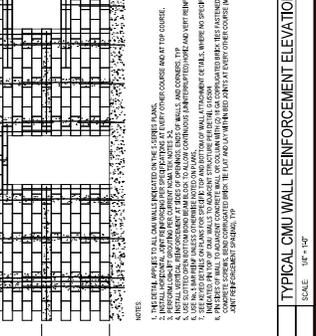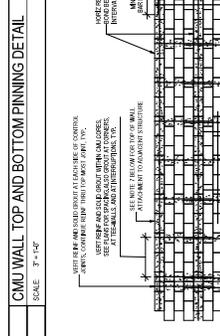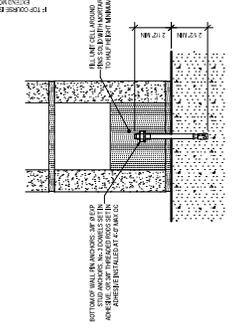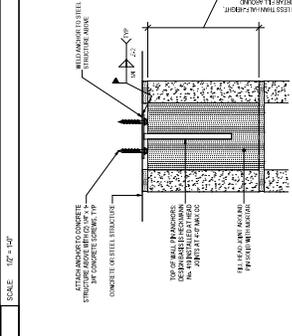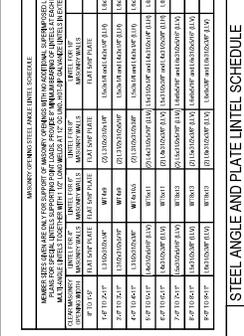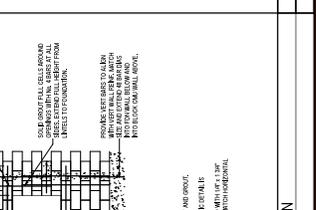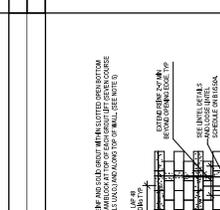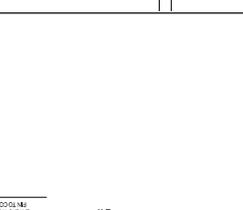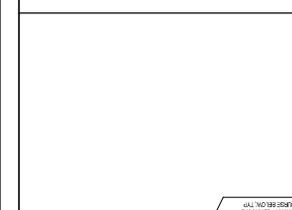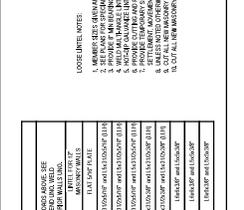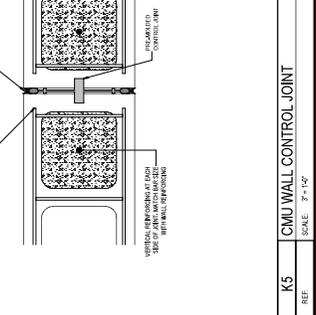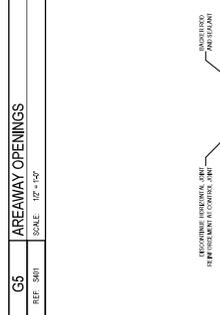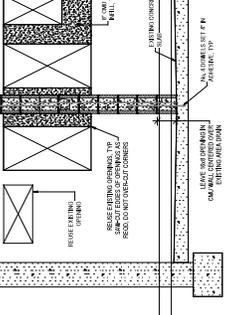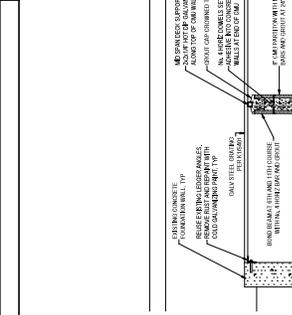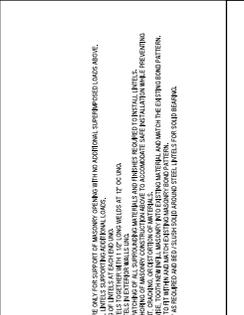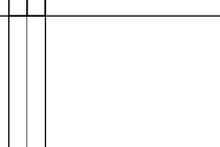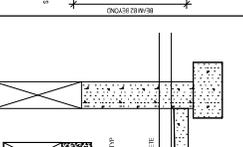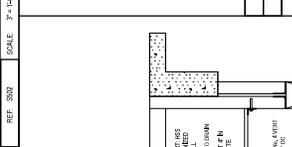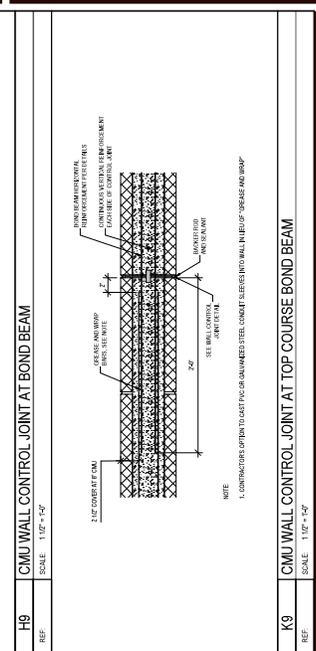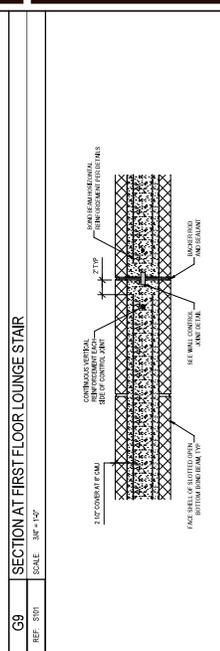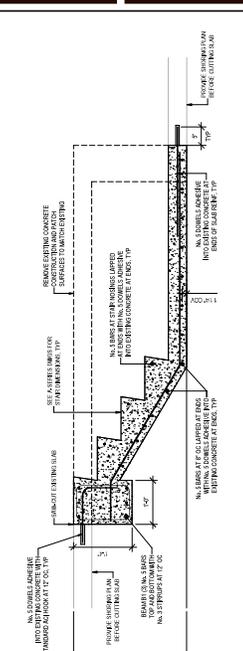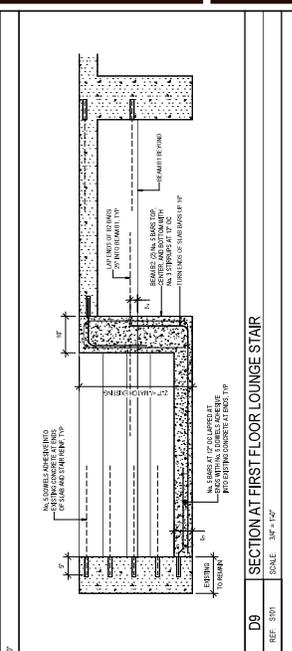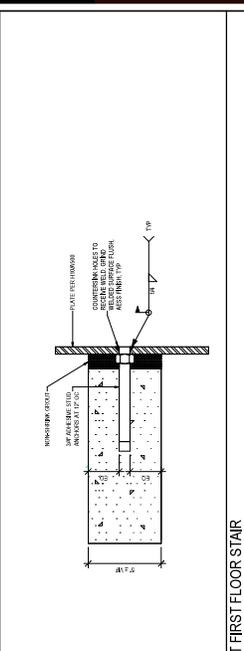

























Project Key

REVISIONS	Description	Date

Project Title  
**STATE UNIVERSITY OF  
 NEW YORK AT NEW  
 PALTZ**  
**DEYO HALL  
 REHABILITATION  
 AND UPPER FLOOR  
 ADDITION**  
 1 HAWK DRIVE NEW PALTZ, NEW YORK  
 12561-2443

Phase  
 BID DOCUMENTS


**NORTH & SOUTH  
 DEMOLITION EXTERIOR  
 ELEVATIONS**

Drawn By: **Cheney/El** Date: 8-26-2018  
 Author: **Chickler**  
 DASHY Project No: 241830  
 Seal & Signature: \_\_\_\_\_  
 Drawing Number: \_\_\_\_\_




**D200**

Scale: 1/8" = 1'-0"

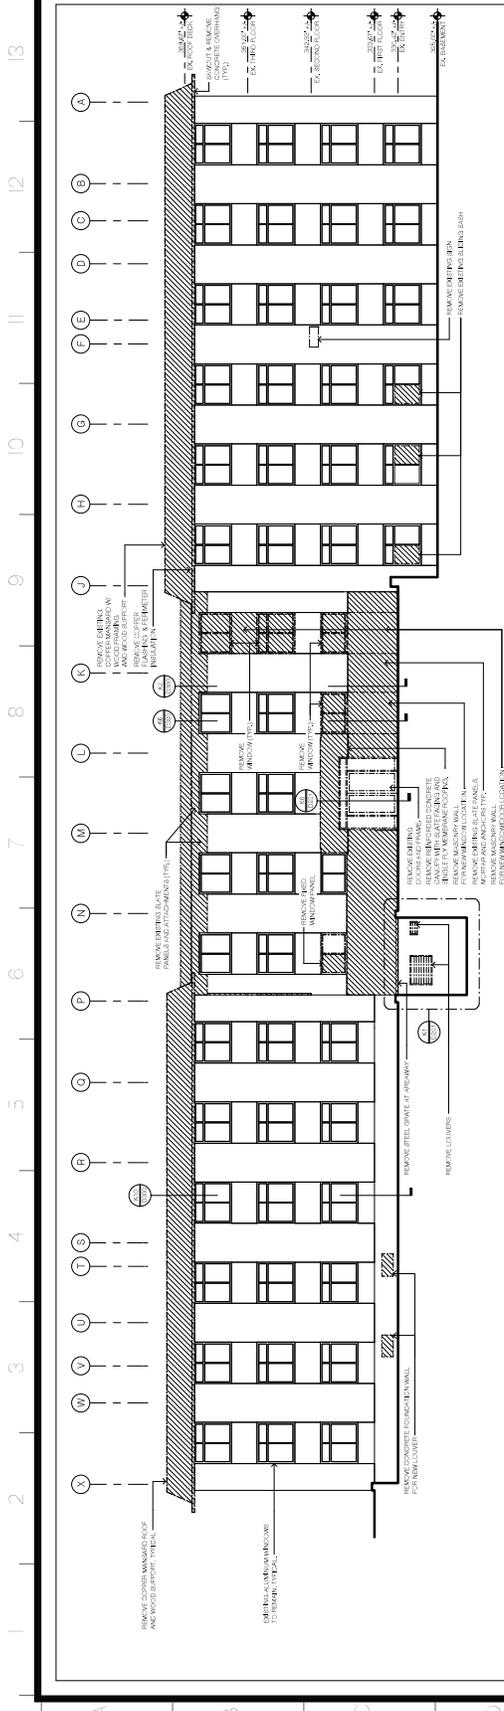

**NORTH EXTERIOR ELEVATION - SELECTIVE REMOVALS**  
 SCALE: 1/8" = 1'-0"

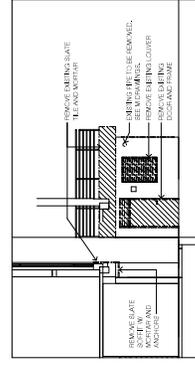


**PARTIAL WEST EXTERIOR ELEVATION**  
 SCALE: 1/8" = 1'-0"

**DEMOLITION LEGEND**

- REMOVE EXISTING CONSTRUCTION TO EXPOSE EXISTING CONSTRUCTION TO BE REMOVED
- REMOVE EXISTING MATERIALS AS SHOWN IN THE LEGEND
- REMOVE EXISTING MATERIALS AS SHOWN IN THE LEGEND
- REMOVE EXISTING MATERIALS AS SHOWN IN THE LEGEND
- REMOVE EXISTING MATERIALS AS SHOWN IN THE LEGEND

**DEMOLITION NOTES**

1. HAZARDOUS MATERIALS MUST BE IDENTIFIED PRIOR TO ANY OTHER DEMOLITION OR DEMOLITION TAKES UNDER DEMOLITION REQUIRED MATERIALS ARE ENCOUNTERED AND/OR UNEXPECTED OPENINGS AND NOTIFY OWNER IMMEDIATELY.
2. SEE HAZARDOUS MATERIALS ASSESSMENT DRAWINGS AND SPECIFICATIONS FOR HAZARDOUS MATERIALS ASSESSMENT AND REMOVAL PROCEDURES AND REMOVAL OF HAZARDOUS MATERIALS.
3. REMOVE ALL EXTERIOR WINDOW AND DOOR FRAMES AND GLASS.
4. REMOVE ALL EXTERIOR WINDOW AND DOOR FRAMES AND GLASS.
5. REMOVE ALL EXTERIOR WINDOW AND DOOR FRAMES AND GLASS.
6. REMOVE ALL EXTERIOR WINDOW AND DOOR FRAMES AND GLASS.
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17. REMOVE ALL EXTERIOR WINDOW AND DOOR FRAMES AND GLASS.
18. REMOVE ALL EXTERIOR WINDOW AND DOOR FRAMES AND GLASS.
19. REMOVE ALL EXTERIOR WINDOW AND DOOR FRAMES AND GLASS.
20. REMOVE ALL EXTERIOR WINDOW AND DOOR FRAMES AND GLASS.

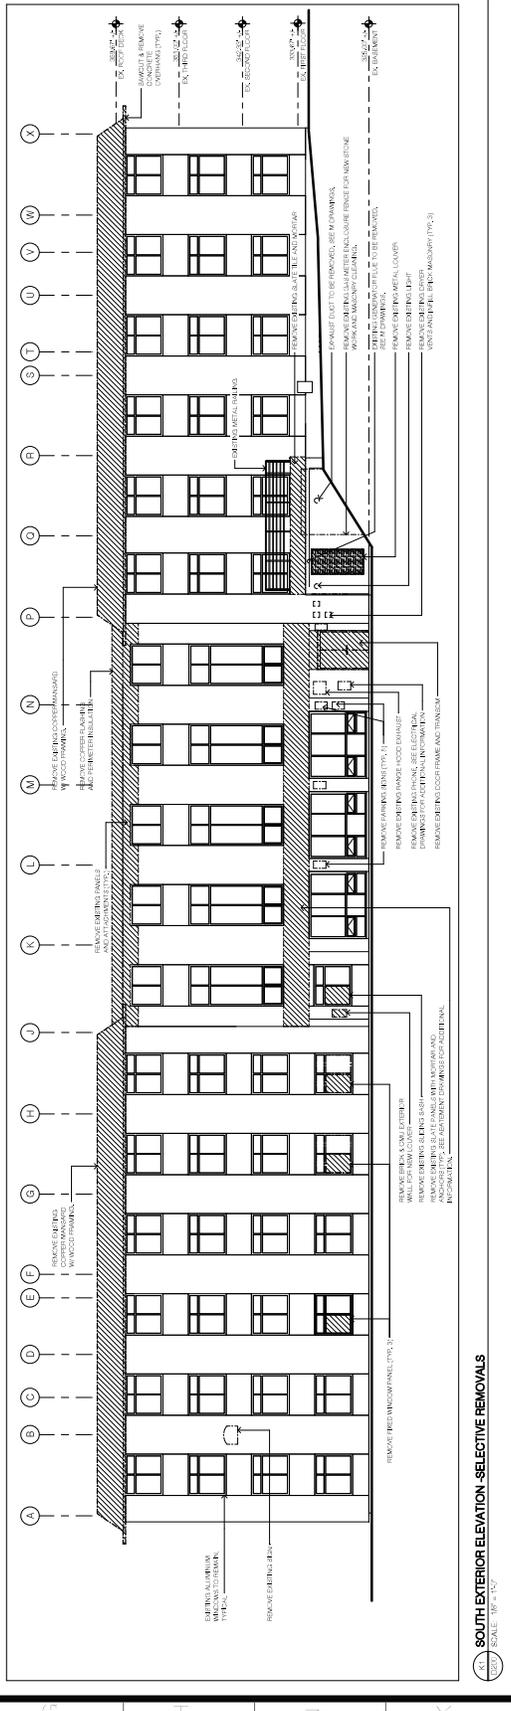

**SOUTH EXTERIOR ELEVATION - SELECTIVE REMOVALS**  
 SCALE: 1/8" = 1'-0"









